



Littleton Conservation Commission

37 Shattuck Street / Room 303

Phone: 978 540-2428

Fax: 978 952-2321

Filing Procedure Summary **Submit this checklist with application** **(rev December 20, 2021)**

The following procedures must be followed when filing under M.G.L. c. 131, §40 or the Littleton Wetlands Protection, Chapter 171 for a wetland permit. The procedure applies to Notice of Intents, Abbreviated Notice of Intents, Request for Determinations, and Abbreviated Notice of Resource Area Determinations.

This summary is not to be considered all inclusive and in no way should an applicant misconstrue its contents to replace any part of M.G.L. c. 131, §40 or the Littleton Wetlands Protection, Chapter 171.

X (1) one electronic file of complete submittal emailed to the Conservation Agent and 2 hard copies (with full sized, color plans) filed with the Conservation Commission hand delivered or mailed and received in the office before noon of filing deadline. Additional copies may be required of some projects. Please call ahead to determine meeting dates and filing deadlines.

X (1) one complete copy of the application must be filed with Department of Environmental Protection at:
Department of Environmental Protection
8 New Bond Street
Worcester, Massachusetts 01608

During COVID Emergency Provisions, MADEP also requires an electronic file sent to CERO_NOI@mass.gov (underscore between CERO and NOI)

With the Subject line based on this format "LITTLETON -xxx-STREET ADDRESS - APPLICANT NAME. The "xxx" will be NOI, ANRAD or RDA

X The applicant must include a certified list of abutters (including those in adjacent Towns) located within 100 feet of the property boundaries, according to the most recent records of the Town Assessors, or as determined by MADEP policy on abutter notification. If a Town line is within 300 feet of the Limit of Work, then that Town's Conservation Commission must also be notified.

X The applicant, at the applicant's expense, shall post to each abutter (and owner if owner is not applicant) by Certificated Mail (Return Receipt Requested), or by hand delivery with signature of abutter a copy of the Abutter Notification Form. An Affidavit of Service of such notification shall also be provided. Abutters' signed acknowledgement of notification (ie, green Return Receipt cards) shall be provide at the first public meeting/hearing. See the Littleton Conservation Commission website for the Abutter Notification Form or call the Agent.

PROJECT NAME/ADDRESS: Reconstruction of Foster St. 238-305 Foster St, 221-241 Taylor St **DATE:** 9/19/2023

X At the applicant's expense, the Commission shall publish a legal notice in a newspaper of local circulation announcing the public hearing. The Notice will be published at least five (5) working days prior to the meeting and will include the date, time and location of the public hearing. The newspaper will bill the applicant directly. This bill must be paid before the legal notice will be published. **Please provide information on who will pay the newspaper (owner, applicant and/or representative) with the application.**

Name	Stephen Jahnle
Company (if applicable)	Town of Littleton DPW
Mailing Address	39 Ayer Rd, Littleton, MA 01460
E-mail	sjahnle@littletonma.org
Phone	978-540-2670

N/A

(Town is the applicant)

Filing fees for MADEP and Town of Littleton under the MA Wetlands Protection Act regulations, as well as the Littleton Wetlands Protection ByLaw filing fee.

PROJECT NAME/ADDRESS: Reconstruction of Foster St. 238-305 Foster St, 221-241 Taylor St DATE: 9/19/2023

Plans Checklist to accompany application for Notice of Intent (NOI). This is a Bylaw Supplemental form to aid you in submitting complete and appropriate information on your plans. These are suggested/expected items to be shown on the plans but will not necessarily be applicable to all projects. Note that the Commission generally requires a colored plan for presentation purposes.

All lines must be marked X or identified as Not Applicable ("N/A"), or noted as to where the information can be found.

(1) X North arrow X Locus insert X Bar scale (preferably 1 in = 20 to 40 ft.)

(2) Title Block with Following Information:

 X Plan Title

 X Applicant's Name(s), address & phone

 X Property Owner Name(s), address & phone

 X Location/street name & number

 X Assessor map, lot, Registry book, page on all lots w/activity

 X Plan preparer's name, title, stamp, company name, address phone & fax

 X Date plan prepared, last revised, and revision notes

(3) X Existing contours

(4) X Existing structure(s) with natural and man-made features, including stone walls and trails

(5) X Trees over 8-inch diameter breast height within resource areas and buffer zones

(6) X Property lines; clearly mark limits of review area if entire property is not under review

(7) X Existing utilities, rights-of-way, easements, ancient ways or other deeded ways

(8) X Name of wetland scientist responsible for identifying wetland boundaries

(9) X Date wetland was flagged (must be no more than 3 years prior to current date)

(10) X Wetland resource area boundaries with flag numbers

(11) X 100 foot buffer zone limits and 50-foot No Disturb limit

(12) X Notations identifying all wetland types and delineation methodology

(13) X Shortest distance to all resource areas from closest proposed structure (use arrow)

Reconstruction of Foster St. 238-305 Foster

PROJECT NAME/ADDRESS: St, 221-241 Taylor St **DATE:** 9/19/2023

- (14) X Shortest distance to all resource areas from closest point of erosion control materials
- (15) X Proposed contours (one foot increments)
- (16) X Proposed location of utility lines
- (17) X Proposed structure(s) (including driveway work, septic components, etc)
- (18) X Existing and proposed stormwater management features (including temporary controls)
- (19) X Watersheds and drainage areas
- (20) X Test pit, boring holes and logs
- (21) X Conservation post detail and plaque detail
- (22) X Location of temporary stockpiles w/notation of content (e.g. excavated soils)
- (23) X Location of snow storage areas
- (24) X Location of dumpster(s)
- (25) X Cross-sections, particularly at key areas of slopes near wetland resource areas
- (26) X Mitigation plans as needed
- (27) X Construction sequencing
- (28) X Details as applicable, including type of erosion controls

PROJECT NAME/ADDRESS: Reconstruction of Foster St. 238-305 Foster St, 221-241 Taylor St DATE: 9/19/2023

One full sized color plans (and presentation plan) should be colored as follows.

Check if present	Feature	Line Type
x	Existing tree line	Green solid
x	Proposed tree line	Green dashed
x	Bordering Vegetated Wetlands*	Dark blue solid
x	Bank/Land Under Water	Light blue dashed
x	100 foot buffer from BVW and/or Bank	Yellow solid
x	50 foot No Disturb limit from BVW and/or Bank	Yellow dashed
x	Vernal Pool	Purple solid
x	Vernal Pool 100 foot	Purple dashed
x	Bordering Lands Subject to Flooding	Orange solid
x	Isolated Lands Subject to Flooding	Orange dashed
x	Mean Annual High Water	Light red solid
x	100 foot and 200 foot Riverfront Area	Light red dashed
x	Bank, Wetland, Land Under Water, Riverfront Area and Floodplain	Red solid with differentiated stippling/cross hatching
x	Mitigation Area	Red dashed line with differentiated stippling/cross hatching
x	Erosion controls	Brown dashed
x	Limit of work	Brown solid

*Note locations of any federal, non-state isolated vegetated wetlands

PROJECT NAME/ADDRESS: Reconstruction of Foster St. 238-305 Foster St, 221-241 Taylor St DATE: 9/19/2023

NOTICE OF INTENT

**Submitted to the
Town of Littleton, MA
Conservation Commission
for the
Reconstruction of Foster Street Project
in Littleton, MA**

MassDOT Project #609054

September 11, 2023

Prepared for:

Town of Littleton
37 Shattuck Street, PO BOX 1305
Littleton, MA 01460

Prepared by:



FUSS & O'NEILL

1550 Main Street, Suite 400
Springfield, MA 01103

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End of Report

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1 MassDEP WPA Form 3



Massachusetts Department of Environmental Protection
Bureau of Resource Protection - Wetlands

WPA Form 3 – Notice of Intent

Massachusetts Wetlands Protection Act M.G.L. c. 131, §40

Provided by MassDEP:

MassDEP File Number


Document Transaction Number

Littleton

City/Town

Important:

When filling out forms on the computer, use only the tab key to move your cursor - do not use the return key.

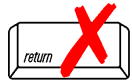

Note:
Before completing this form consult your local Conservation Commission regarding any municipal bylaw or ordinance.

A. General Information

1. Project Location (**Note:** electronic filers will click on button to locate project site):

Foster Street

a. Street Address

Littleton

b. City/Town

01460

c. Zip Code

Latitude and Longitude:

1425

f. Assessors Map/Plat Number

42.519123

d. Latitude

-71.502669

e. Longitude

R10 2 1

g. Parcel /Lot Number

2. Applicant:

Stephen

a. First Name

Jahnle

b. Last Name

Department of Public Works

c. Organization

39 Ayer Rd

d. Street Address

Littleton

e. City/Town

MA

f. State

01460

g. Zip Code

978-540-2670

h. Phone Number

i. Fax Number

sjahnle@littletonma.org

j. Email Address

3. Property owner (required if different from applicant): ☐ Check if more than one owner

Town of Littleton

a. First Name

b. Last Name

Town of Littleton-Department of Public Works

c. Organization

39 Ayer Rd

d. Street Address

Littleton

e. City/Town

MA

f. State

01460

g. Zip Code

978-540-2670

h. Phone Number

i. Fax Number

j. Email address

4. Representative (if any):

Dan

a. First Name

Delany, P.E.

b. Last Name

Fuss & O'Neill

c. Company

1550 Main Street, Suite 400

d. Street Address

Springfield

e. City/Town

MA

f. State

01103

g. Zip Code

800-286-2469

h. Phone Number

i. Fax Number

ddelany@fando.com

j. Email address

5. Total WPA Fee Paid (from NOI Wetland Fee Transmittal Form):

N/A

a. Total Fee Paid

N/A

b. State Fee Paid

N/A

c. City/Town Fee Paid



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Provided by MassDEP:

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A. General Information (continued)

6. General Project Description:

Work includes pavement reclamation and full depth reconstruction along Foster Street, construction of a 10 foot wide shared-use path, addition of curbing in select areas, installation of a new underground water main, new catch basins, realignment of the Grimes Lane & Foster Street intersection, and the addition of midblock crosswalks.

7a. Project Type Checklist: (Limited Project Types see Section A. 7b.)

- | | |
|---|---|
| 1. <input type="checkbox"/> Single Family Home | 2. <input type="checkbox"/> Residential Subdivision |
| 3. <input type="checkbox"/> Commercial/Industrial | 4. <input type="checkbox"/> Dock/Pier |
| 5. <input type="checkbox"/> Utilities | 6. <input type="checkbox"/> Coastal engineering Structure |
| 7. <input type="checkbox"/> Agriculture (e.g., cranberries, forestry) | 8. <input checked="" type="checkbox"/> Transportation |
| 9. <input type="checkbox"/> Other | |

7b. Is any portion of the proposed activity eligible to be treated as a limited project (including Ecological Restoration Limited Project) subject to 310 CMR 10.24 (coastal) or 310 CMR 10.53 (inland)?

1. ☒ Yes ☐ No If yes, describe which limited project applies to this project. (See 310 CMR 10.24 and 10.53 for a complete list and description of limited project types)

310 CMR 10.53(3)(f)

2. Limited Project Type

If the proposed activity is eligible to be treated as an Ecological Restoration Limited Project (310 CMR 10.24(8), 310 CMR 10.53(4)), complete and attach Appendix A: Ecological Restoration Limited Project Checklist and Signed Certification.

8. Property recorded at the Registry of Deeds for:

NA (roadway right of way)

a. County

b. Certificate # (if registered land)

c. Book

d. Page Number

B. Buffer Zone & Resource Area Impacts (temporary & permanent)

- ☒ Buffer Zone Only – Check if the project is located only in the Buffer Zone of a Bordering Vegetated Wetland, Inland Bank, or Coastal Resource Area.
- ☐ Inland Resource Areas (see 310 CMR 10.54-10.58; if not applicable, go to Section B.3, Coastal Resource Areas).

Check all that apply below. Attach narrative and any supporting documentation describing how the project will meet all performance standards for each of the resource areas altered, including standards requiring consideration of alternative project design or location.



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B. Buffer Zone & Resource Area Impacts (temporary & permanent) (cont'd)

For all projects affecting other Resource Areas, please attach a narrative explaining how the resource area was delineated.

Resource Area	Size of Proposed Alteration	Proposed Replacement (if any)
a. <input type="checkbox"/> Bank	0 1. linear feet	0 2. linear feet
b. <input type="checkbox"/> Bordering Vegetated Wetland	0 1. square feet	0 2. square feet
c. <input type="checkbox"/> Land Under Waterbodies and Waterways	0 1. square feet 0 3. cubic yards dredged	0 2. square feet

Resource Area	Size of Proposed Alteration	Proposed Replacement (if any)
d. <input type="checkbox"/> Bordering Land Subject to Flooding	1. square feet 3. cubic feet of flood storage lost	2. square feet 4. cubic feet replaced
e. <input type="checkbox"/> Isolated Land Subject to Flooding	1. square feet 2. cubic feet of flood storage lost	3. cubic feet replaced
f. <input type="checkbox"/> Riverfront Area	1. Name of Waterway (if available) - specify coastal or inland	

2. Width of Riverfront Area (check one):

- ☐ 25 ft. - Designated Densely Developed Areas only
- ☐ 100 ft. - New agricultural projects only
- ☐ 200 ft. - All other projects

3. Total area of Riverfront Area on the site of the proposed project: _____ square feet

4. Proposed alteration of the Riverfront Area:

a. total square feet _____ b. square feet within 100 ft. _____ c. square feet between 100 ft. and 200 ft. _____

5. Has an alternatives analysis been done and is it attached to this NOI? ☐ Yes ☐ No

6. Was the lot where the activity is proposed created prior to August 1, 1996? ☐ Yes ☐ No

3. ☐ Coastal Resource Areas: (See 310 CMR 10.25-10.35)

Note: for coastal riverfront areas, please complete **Section B.2.f.** above.



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B. Buffer Zone & Resource Area Impacts (temporary & permanent) (cont'd)

Check all that apply below. Attach narrative and supporting documentation describing how the project will meet all performance standards for each of the resource areas altered, including standards requiring consideration of alternative project design or location.

Online Users:
Include your document transaction number (provided on your receipt page) with all supplementary information you submit to the Department.

<u>Resource Area</u>	<u>Size of Proposed Alteration</u>	<u>Proposed Replacement (if any)</u>
a. <input type="checkbox"/> Designated Port Areas	Indicate size under Land Under the Ocean, below	
b. <input type="checkbox"/> Land Under the Ocean	1. square feet	
	2. cubic yards dredged	
c. <input type="checkbox"/> Barrier Beach	Indicate size under Coastal Beaches and/or Coastal Dunes below	
d. <input type="checkbox"/> Coastal Beaches	1. square feet	2. cubic yards beach nourishment
e. <input type="checkbox"/> Coastal Dunes	1. square feet	2. cubic yards dune nourishment
	<u>Size of Proposed Alteration</u>	<u>Proposed Replacement (if any)</u>
f. <input type="checkbox"/> Coastal Banks	1. linear feet	
g. <input type="checkbox"/> Rocky Intertidal Shores	1. square feet	
h. <input type="checkbox"/> Salt Marshes	1. square feet	2. sq ft restoration, rehab., creation
i. <input type="checkbox"/> Land Under Salt Ponds	1. square feet	
	2. cubic yards dredged	
j. <input type="checkbox"/> Land Containing Shellfish	1. square feet	
k. <input type="checkbox"/> Fish Runs	Indicate size under Coastal Banks, inland Bank, Land Under the Ocean, and/or inland Land Under Waterbodies and Waterways, above	
	1. cubic yards dredged	
l. <input type="checkbox"/> Land Subject to Coastal Storm Flowage	1. square feet	
4. <input type="checkbox"/> Restoration/Enhancement	If the project is for the purpose of restoring or enhancing a wetland resource area in addition to the square footage that has been entered in Section B.2.b or B.3.h above, please enter the additional amount here.	
	a. square feet of BVW	b. square feet of Salt Marsh
5. <input type="checkbox"/> Project Involves Stream Crossings		
	a. number of new stream crossings	b. number of replacement stream crossings



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C. Other Applicable Standards and Requirements

- ☐ This is a proposal for an Ecological Restoration Limited Project. Skip Section C and complete Appendix A: Ecological Restoration Limited Project Checklists – Required Actions (310 CMR 10.11).

Streamlined Massachusetts Endangered Species Act/Wetlands Protection Act Review

1. Is any portion of the proposed project located in **Estimated Habitat of Rare Wildlife** as indicated on the most recent Estimated Habitat Map of State-Listed Rare Wetland Wildlife published by the Natural Heritage and Endangered Species Program (NHESP)? To view habitat maps, see the *Massachusetts Natural Heritage Atlas* or go to http://maps.massgis.state.ma.us/PRI_EST_HAB/viewer.htm.

a. ☐ Yes ☒ No

If yes, include proof of mailing or hand delivery of NOI to:

**Natural Heritage and Endangered Species Program
Division of Fisheries and Wildlife
1 Rabbit Hill Road
Westborough, MA 01581**

04/18/2023

b. Date of map

If yes, the project is also subject to Massachusetts Endangered Species Act (MESA) review (321 CMR 10.18). To qualify for a streamlined, 30-day, MESA/Wetlands Protection Act review, please complete Section C.1.c, and include requested materials with this Notice of Intent (NOI); *OR* complete Section C.2.f, if applicable. *If MESA supplemental information is not included with the NOI, by completing Section 1 of this form, the NHESP will require a separate MESA filing which may take up to 90 days to review (unless noted exceptions in Section 2 apply, see below).*

- c. Submit Supplemental Information for Endangered Species Review*

1. ☐ Percentage/acreage of property to be altered:

(a) within wetland Resource Area

percentage/acreage

(b) outside Resource Area

percentage/acreage

2. ☐ Assessor's Map or right-of-way plan of site

2. ☐ Project plans for entire project site, including wetland resource areas and areas outside of wetlands jurisdiction, showing existing and proposed conditions, existing and proposed tree/vegetation clearing line, and clearly demarcated limits of work **

(a) ☐ Project description (including description of impacts outside of wetland resource area & buffer zone)

(b) ☐ Photographs representative of the site

* Some projects **not** in Estimated Habitat may be located in Priority Habitat, and require NHESP review (see <https://www.mass.gov/ma-endangered-species-act-mesa-regulatory-review>).

Priority Habitat includes habitat for state-listed plants and strictly upland species not protected by the Wetlands Protection Act.

** MESA projects may not be segmented (321 CMR 10.16). The applicant must disclose full development plans even if such plans are not required as part of the Notice of Intent process.



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C. Other Applicable Standards and Requirements (cont'd)

- (c) ☐ MESA filing fee (fee information available at <https://www.mass.gov/how-to/how-to-file-for-a-mesa-project-review>).

Make check payable to "Commonwealth of Massachusetts - NHESP" and **mail to NHESP** at above address

Projects altering 10 or more acres of land, also submit:

- (d) ☐ Vegetation cover type map of site
- (e) ☐ Project plans showing Priority & Estimated Habitat boundaries
- (f) OR Check One of the Following

1. ☐ Project is exempt from MESA review.
Attach applicant letter indicating which MESA exemption applies. (See 321 CMR 10.14, <https://www.mass.gov/service-details/exemptions-from-review-for-projectsactivities-in-priority-habitat>; the NOI must still be sent to NHESP if the project is within estimated habitat pursuant to 310 CMR 10.37 and 10.59.)

2. ☐ Separate MESA review ongoing. a. NHESP Tracking # _____ b. Date submitted to NHESP _____

3. ☐ Separate MESA review completed.
Include copy of NHESP "no Take" determination or valid Conservation & Management Permit with approved plan.

3. For coastal projects only, is any portion of the proposed project located below the mean high water line or in a fish run?

- a. ☒ Not applicable – project is in inland resource area only b. ☐ Yes ☐ No

If yes, include proof of mailing, hand delivery, or electronic delivery of NOI to either:

South Shore - Cohasset to Rhode Island border, and the Cape & Islands:

North Shore - Hull to New Hampshire border:

Division of Marine Fisheries -
Southeast Marine Fisheries Station
Attn: Environmental Reviewer
836 South Rodney French Blvd.
New Bedford, MA 02744
Email: dmf.envreview-south@mass.gov

Division of Marine Fisheries -
North Shore Office
Attn: Environmental Reviewer
30 Emerson Avenue
Gloucester, MA 01930
Email: dmf.envreview-north@mass.gov

Also if yes, the project may require a Chapter 91 license. For coastal towns in the Northeast Region, please contact MassDEP's Boston Office. For coastal towns in the Southeast Region, please contact MassDEP's Southeast Regional Office.

- c. ☐ Is this an aquaculture project? d. ☐ Yes ☒ No

If yes, include a copy of the Division of Marine Fisheries Certification Letter (M.G.L. c. 130, § 57).



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C. Other Applicable Standards and Requirements (cont'd)

Online Users:

Include your document transaction number (provided on your receipt page) with all supplementary information you submit to the Department.

4. Is any portion of the proposed project within an Area of Critical Environmental Concern (ACEC)?
 a. ☐ Yes ☒ No If yes, provide name of ACEC (see instructions to WPA Form 3 or MassDEP Website for ACEC locations). **Note:** electronic filers click on Website.
 b. ACEC
5. Is any portion of the proposed project within an area designated as an Outstanding Resource Water (ORW) as designated in the Massachusetts Surface Water Quality Standards, 314 CMR 4.00?
 a. ☐ Yes ☒ No
6. Is any portion of the site subject to a Wetlands Restriction Order under the Inland Wetlands Restriction Act (M.G.L. c. 131, § 40A) or the Coastal Wetlands Restriction Act (M.G.L. c. 130, § 105)?
 a. ☐ Yes ☒ No
7. Is this project subject to provisions of the MassDEP Stormwater Management Standards?
 a. ☒ Yes. Attach a copy of the Stormwater Report as required by the Stormwater Management Standards per 310 CMR 10.05(6)(k)-(q) and check if:
 1. ☐ Applying for Low Impact Development (LID) site design credits (as described in Stormwater Management Handbook Vol. 2, Chapter 3)
 2. ☒ A portion of the site constitutes redevelopment
 3. ☐ Proprietary BMPs are included in the Stormwater Management System.
- b. ☐ No. Check why the project is exempt:
 1. ☐ Single-family house
 2. ☐ Emergency road repair
 3. ☐ Small Residential Subdivision (less than or equal to 4 single-family houses or less than or equal to 4 units in multi-family housing project) with no discharge to Critical Areas.

D. Additional Information

- ☐ This is a proposal for an Ecological Restoration Limited Project. Skip Section D and complete Appendix A: Ecological Restoration Notice of Intent – Minimum Required Documents (310 CMR 10.12).

Applicants must include the following with this Notice of Intent (NOI). See instructions for details.

Online Users: Attach the document transaction number (provided on your receipt page) for any of the following information you submit to the Department.

1. ☒ USGS or other map of the area (along with a narrative description, if necessary) containing sufficient information for the Conservation Commission and the Department to locate the site. (Electronic filers may omit this item.)
2. ☒ Plans identifying the location of proposed activities (including activities proposed to serve as a Bordering Vegetated Wetland [BVW] replication area or other mitigating measure) relative to the boundaries of each affected resource area.



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Provided by MassDEP:

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City/Town

D. Additional Information (cont'd)

3. ☒ Identify the method for BVW and other resource area boundary delineations (MassDEP BVW Field Data Form(s), Determination of Applicability, Order of Resource Area Delineation, etc.), and attach documentation of the methodology.

4. ☒ List the titles and dates for all plans and other materials submitted with this NOI.

MassDOT # 609054 Plan and Profile of Foster St. Permitting Plan Set

a. Plan Title

Fuss & O'Neill

Dan Delany, PE

b. Prepared By

c. Signed and Stamped by

04/28/2023

1"=20'

d. Final Revision Date

e. Scale

f. Additional Plan or Document Title

g. Date

5. ☐ If there is more than one property owner, please attach a list of these property owners not listed on this form.
6. ☐ Attach proof of mailing for Natural Heritage and Endangered Species Program, if needed.
7. ☐ Attach proof of mailing for Massachusetts Division of Marine Fisheries, if needed.
8. ☒ Attach NOI Wetland Fee Transmittal Form
9. ☒ Attach Stormwater Report, if needed.

E. Fees

1. ☒ Fee Exempt: No filing fee shall be assessed for projects of any city, town, county, or district of the Commonwealth, federally recognized Indian tribe housing authority, municipal housing authority, or the Massachusetts Bay Transportation Authority.

Applicants must submit the following information (in addition to pages 1 and 2 of the NOI Wetland Fee Transmittal Form) to confirm fee payment:

2. Municipal Check Number

3. Check date

4. State Check Number

5. Check date

6. Payor name on check: First Name

7. Payor name on check: Last Name



Massachusetts Department of Environmental Protection
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WPA Form 3 – Notice of Intent

Massachusetts Wetlands Protection Act M.G.L. c. 131, §40

Provided by MassDEP:

MassDEP File Number

Document Transaction Number

Littleton

City/Town

F. Signatures and Submittal Requirements

I hereby certify under the penalties of perjury that the foregoing Notice of Intent and accompanying plans, documents, and supporting data are true and complete to the best of my knowledge. I understand that the Conservation Commission will place notification of this Notice in a local newspaper at the expense of the applicant in accordance with the wetlands regulations, 310 CMR 10.05(5)(a).

I further certify under penalties of perjury that all abutters were notified of this application, pursuant to the requirements of M.G.L. c. 131, § 40. Notice must be made by Certificate of Mailing or in writing by hand delivery or certified mail (return receipt requested) to all abutters within 100 feet of the property line of the project location.

1. Signature of Applicant

2. Date

3. Signature of Property Owner (if different)

4. Date

5. Signature of Representative (if any)

6. Date

For Conservation Commission:

Two copies of the completed Notice of Intent (Form 3), including supporting plans and documents, two copies of the NOI Wetland Fee Transmittal Form, and the city/town fee payment, to the Conservation Commission by certified mail or hand delivery.

For MassDEP:

One copy of the completed Notice of Intent (Form 3), including supporting plans and documents, one copy of the NOI Wetland Fee Transmittal Form, and a **copy** of the state fee payment to the MassDEP Regional Office (see Instructions) by certified mail or hand delivery.

Other:


If the applicant has checked the "yes" box in any part of Section C, Item 3, above, refer to that section and the Instructions for additional submittal requirements.

The original and copies must be sent simultaneously. Failure by the applicant to send copies in a timely manner may result in dismissal of the Notice of Intent.



Massachusetts Department of Environmental Protection
Bureau of Resource Protection - Wetlands
NOI Wetland Fee Transmittal Form
Massachusetts Wetlands Protection Act M.G.L. c. 131, §40

Important: When filling out forms on the computer, use only the tab key to move your cursor - do not use the return key.

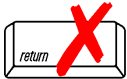

A. Applicant Information

1. Location of Project:

Foster Street

a. Street Address

Littleton

b. City/Town

c. Check number

d. Fee amount

2. Applicant Mailing Address:

Stephen

a. First Name

Jahnle

b. Last Name

Town of Littleton-Dept. of Public Works

c. Organization

39 Ayer Rd

d. Mailing Address

Littleton

e. City/Town

MA

f. State

01460

g. Zip Code

978-540-2670

h. Phone Number

i. Fax Number

j. Email Address

3. Property Owner (if different):

Town of Littleton

a. First Name

b. Last Name

Town of Littleton-Department of Public Works

c. Organization

39 Ayer Rd

d. Mailing Address

Littleton

e. City/Town

MA

f. State

01460

g. Zip Code

978-540-2670

h. Phone Number

i. Fax Number

j. Email Address

To calculate filing fees, refer to the category fee list and examples in the instructions for filling out WPA Form 3 (Notice of Intent).

B. Fees

Fee should be calculated using the following process & worksheet. **Please see Instructions before filling out worksheet.**

Step 1/Type of Activity: Describe each type of activity that will occur in wetland resource area and buffer zone.

Step 2/Number of Activities: Identify the number of each type of activity.

Step 3/Individual Activity Fee: Identify each activity fee from the six project categories listed in the instructions.

Step 4/Subtotal Activity Fee: Multiply the number of activities (identified in Step 2) times the fee per category (identified in Step 3) to reach a subtotal fee amount. Note: If any of these activities are in a Riverfront Area in addition to another Resource Area or the Buffer Zone, the fee per activity should be multiplied by 1.5 and then added to the subtotal amount.

Step 5/Total Project Fee: Determine the total project fee by adding the subtotal amounts from Step 4.

Step 6/Fee Payments: To calculate the state share of the fee, divide the total fee in half and subtract \$12.50. To calculate the city/town share of the fee, divide the total fee in half and add \$12.50.



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B. Fees (continued)

Step 1/Type of Activity	Step 2/Number of Activities	Step 3/Individual Activity Fee	Step 4/Subtotal Activity Fee

Step 5/Total Project Fee: _____

Step 6/Fee Payments:

Total Project Fee:	N/A Fee exempt
	a. Total Fee from Step 5
State share of filing Fee:	N/A
	b. 1/2 Total Fee less \$12.50
City/Town share of filing Fee:	N/A
	c. 1/2 Total Fee plus \$12.50

C. Submittal Requirements

- a.) Complete pages 1 and 2 and send with a check or money order for the state share of the fee, payable to the Commonwealth of Massachusetts.

Department of Environmental Protection
Box 4062
Boston, MA 02211

- b.) **To the Conservation Commission:** Send the Notice of Intent or Abbreviated Notice of Intent; a **copy** of this form; and the city/town fee payment.

To MassDEP Regional Office (see Instructions): Send a copy of the Notice of Intent or Abbreviated Notice of Intent; a **copy** of this form; and a **copy** of the state fee payment. (E-filers of Notices of Intent may submit these electronically.)

2 Executive Summary

Pursuant to the Massachusetts Wetland Protection Act, M.G.L.c. 131 § 40, 310 CMR. 10.00, the Town of Littleton is the applicant for this Notice of Intent (NOI) proposing a linear transportation improvement project that will redevelop Foster Street between Taylor Street and Balsam Lane, replace the surface of Taylor Street for 205 feet, and realign the intersection of Grimes Lane at Foster Street. A new 10-foot wide separated shared-use path will be created parallel to Foster Street while the road surface on Foster St will be narrowed by 4 feet. The project addresses vehicular, pedestrian, and bicycle safety. The project proposes an improved stormwater drainage system to the maximum extent practical for a redevelopment project. Upgrades are proposed to some existing catch basins. The project will also include the replacement of a 10 inch water main underneath Foster Street in an effort to 'dig once' and reduce disturbance to the corridor.

The project is eligible as a limited project under 10.53(3)(f):

“ Maintenance and improvement of existing public roadways, but limited to widening less than a single lane, adding shoulders, correcting substandard intersections, and improving inadequate drainage systems.”

Because the project will not widen the road by the width of one lane the project is eligible as a redevelopment project for stormwater management therefore the Massachusetts Stormwater Management Standards are proposed to be met to the maximum extent practicable.

The project proposes permanent and temporary impacts to the 100-ft Buffer Zone and the Town of Littleton 50-ft No Disturbance Zone. The applicant is requesting a Waiver from the Commission from the provisions of Section 4.2, 50-ft No Disturb Zone, under the relevant provisions of Section 1.4(2) of the Town of Littleton Wetland Protection Regulations.

3 Existing Conditions

3.1 Existing Site Description

The project is located on Foster Street in Littleton, MA between Taylor Street and Balsam Lane. A locus map of the project area is provided in the attached Figure 1.

The project is located in the Merrimack Watershed. The receiving waters for the project include Beaver Brook, a category 3 impaired waterway for bacteria/pathogens and Mill Pond, a freshwater lake and a category 5 impaired waterway for not supporting aesthetic, primary contact, or secondary contact due to macrophytes.

A sample of site photos along the corridor is attached in Appendix E. The dimensions of the project limits are:

- The project length on Foster Street is 3,936 ft (0.75 mi).
- The project length on Taylor Street is 205 ft extending north and south from the intersection with Foster Street.
- The project length on Grimes Lane is 145 ft extending southeast from the intersection with Foster Street.
- The total project length is therefore 4,286 ft (0.81 mi).
- The project area is traversed via an overhead bridge by Massachusetts State Route 2. No work is proposed on the bridge structure.
- The project area is also traversed at-grade by a 30 ft-wide double-track rail crossing of the MBTA Fitchburg Line. No work is proposed on the tracks.
- The total work area of the project limits sums to 5.37 acres within the limits of grading.

The Town of Littleton owns roadway right-of-way (ROW) layouts that vary between 40-70 feet wide in the project area on Foster Street and Taylor Street. On Grimes Lane however, the Town layout narrows to 20-40 feet in width.

The land surrounding the project area is part of the Boston Metropolitan Statistical Area (MSA) Large Urbanized Area. The surrounding land use is a variety of uses including industrial, commercial, single-family residential, and the I-495/Littleton commuter rail station owned by the MBTA. Several adjacent properties have maintained a rural historical character.

The existing pavement on Taylor Street is generally 44 ft wide consisting of two 12 ft wide lanes and 10 ft paved shoulders on each roadside. Taylor Street is classified as an urban collector road and has a speed limit of 35 mph. There are currently no bicycle or pedestrian facilities along Taylor Street in the project limits.

Existing drainage on Taylor Street is mostly conveyed by runoff infiltration from the edge of road to the adjacent vegetated areas. Taylor Street has two catch basins conveying closed stormwater drainage underneath Taylor Street exiting the project area to the north.

The existing pavement on Foster Street is generally 28 ft wide consisting of two 12 ft wide lanes and 2 ft paved shoulders on each side. Foster Street is classified as an urban collector and has a speed limit of 30 mph. There is currently a single 500 ft length sidewalk spanning from the MBTA station driveway to the Route 2 overpass on the north side of the road. There are no other bicycle or pedestrian facilities along Foster Street in the project limits.

Existing drainage on Foster Street is mostly conveyed by runoff infiltration from the edge of road to the adjacent vegetated areas. Foster Street also has a system of catch basins conveying closed stormwater drainage to open outfalls adjacent to the roadside.

The short section of Grimes Lane in the project area has neither pedestrian accommodations nor catch basins. The width of pavement on Grimes Lane at Foster Street is below current vehicular safety standards for two-way traffic, narrowing to just 10 feet. Grimes Lane is classified as a local road and has a speed limit of 25 mph.

There are two existing culvert crossings beneath Foster Street. The project plans included in Appendix B include a base topographical survey showing an 18 inch corrugated metal pipe Culvert running beneath and transverse to Foster Street at project Station 10+30, adjacent to the parcels of 295 Foster Street and 300 Foster Street. The culvert conveys stormwater drainage from Foster Street and connects an open body of water with an intermittent stream.

There is also a 48 inch Reinforced Concrete Pipe culvert at project station 24+85 conveying an intermittent stream underneath Foster Street located within the State-owned layout of Route 2.

On the frontage of the MBTA station parcel, there is an existing rip-rap swale with catch basins contained in the swale conveying water away from Foster Street and the MBTA parking area.

3.2 Resource Area Delineation

Inland resource areas were delineated in July and August of 2018 by Robin Casioppo, a wetland and soil scientist employed by Fuss & O'Neill, and by Josh Wilson, PWS, also employed by Fuss & O'Neill. The delineations were performed in accordance with methods developed by Massachusetts DEP and with respect to the Wetlands Protection Act. A wetland delineation report has been included in Appendix D.

The delineation found resource areas in the project area including Bank, Land Under Water, Buffer Zone, and Bordering Vegetated Wetland. The attached plans in Appendix B include delineation flags for the resource areas and buffer zone boundaries as part of the topographic survey base mapping underlying the proposed plans.

4 Proposed Conditions

4.1 Project Description

The project proposes the following work in the project area with an overall goal of improving safety for all modes of travel along the Foster Street corridor.

Upgrades to vehicular, pedestrian, and bicycle safety

- A Shared-use path for non-motorized travel use along the north side of Foster Street connecting Balsam Lane to Taylor Street and serving the frontage of the MBTA Commuter Rail Station.
- (4) Rectangular Rapid Flashing Beacons to alert drivers of pedestrian crossings with revised crosswalks for safer visibility and accessibility compliant pedestrian curb ramps.
 - (3) Located on Foster Street
 - (1) Located on Taylor Street
- New 10-foot wide pedestrian and bike sidewalk ramps on Taylor Street at the Foster Street intersection.
- New pavement markings with vehicle warning & regulatory signage for better driver visibility
- Full-depth pavement reconstruction on Foster Street.
- Re-alignment of Grimes Lane at Foster Street to increase safety at the rail crossing and sight distance for all users at the intersection. The improvements will bring the width of Grimes Lane into safety standards for a two-way road.
- Increased LED streetlighting coverage along Foster St.
- Replaced aging guard rail at steep road side embankments.

Drainage Improvements

Because curbing will be added to the road shoulder for all of the west side of Foster Street for the shared-use path and parts of the east side to improve pedestrian safety, the closed drainage system will be upgraded to provide improved treatment.

- (9) Existing catch basins on Foster Street replaced with new deep-sump (4ft) catch basins
- (3) New deep-sump catch basins on Foster Street
- (4) New leaching (impervious) catch basins on Foster Street to convey stormwater runoff into ground infiltration
- (7) Existing catch basins remodeled and repaired
- All other existing catch basins in the project limits remaining are to be cleaned at the completion of construction
- The rip-rap drainage swale on the frontage of MBTA property will be moved less than 5 feet to the north and rebuilt as having the same overall area as existing. The location of the swale is proposed to be shifted to fit the shared-use path.

Maintenance and Repair to Critical Town Infrastructure

- A new 10 inch water service main under Foster Street through the project limits. This asset upgrade seeks to leverage the opening of the road for pavement reconstruction as preventative maintenance and critical infrastructure upgrade.

Pavement Widening

- To implement the shared-use path on Foster Street to MassDOT design standards, overall impervious area widening was necessary. The existing paved cross section of Foster Street is 28 ft wide. The proposed road cross section will narrow the road pavement on Foster Street by 4 ft but will add a 10 ft wide paved shared-use path. This results in a new cross section containing a total of 34 ft in pavement width when the shared-use path is included. This is 6 ft more of total pavement width than the exiting condition on Foster Street.

Impervious Area

- The existing condition has a total of 2.930 acres of impervious area within the public layout work limits. The proposed condition has a total of 3.542 acres within the public layout work limits. The project proposes to create an additional 0.612 acres (26,612 SF) of impervious area within the project limits. The net new impervious area is distributed along the 0.75 mile long Foster Street corridor.

Layout Alteration and Easements

- The project stays within the existing road layout ROW for a large majority of the project. Where grading of slopes exceeds the layout boundaries or a utility pole must be moved to the edge of the layout boundary, layout alterations and easements are being proposed as part of the project. The temporary and permanent easements are shown on the plans in Appendix B.

Tree and Shrub Plantings

- Tree plantings are proposed at two locations. Five native species including red maple trees, *Acer Rubrum*, are proposed to be planted at the frontage of 305 Foster Street. The maple trees will replace a stand of 1 Pine and 2 Hawthorne on private property that must be removed for utility pole relocation. The ornamental shrub 'Mountain Fire Andromeda' is proposed to be planted at the frontage of 284 Foster Street in the public right of way where a slope is being cut back close to the boundary of a private lawn. The purpose of the shrub plantings is for visual screening.

4.2 Alternatives Analysis

The design was initiated in the Fall of 2017 and followed the multi-stage MassDOT project design and development process. The design process evaluated different alternatives for impacts and sought public and stakeholder involvement.

The preferred alternative for the design of Foster Street minimized impacts compared to a second viable alternative by reducing the width of pavement and providing a vegetated buffer between the path and road. Concept 2 below was not selected to continue past 25% design in part because Concept 1 achieved the same mobility and safety goals with a narrower width of pavement by 1ft.

Figure 1: An Early Concept Alternative for Foster Street that was Not Selected
Total Pavement Width is 35ft



Figure 2: The Preferred Alternative for Foster Street
Total Pavement Width is 34ft with a Vegetated Buffer Between Path and Edge of Road



The two concepts above were presented to the Littleton Board of Selectmen and community members at the Town Select Board meeting on January 14, 2019. Community members present at the meeting, including some who live on Foster Street, overwhelmingly favored the shared-use path concept. Those

in favor of the shared-use path believed it would not only benefit adjacent business office parks, but also local residents who would use it for recreational purposes. They preferred the proposed buffer separating vehicular traffic and pedestrians and cyclists. The majority of the Board members present at the meeting supported Concept 2 which included the shared-use path, as they appreciate the increased pedestrian and cyclist safety, as well as the decreased vehicular speeds expected as a result of the proposed road narrowing. With the support of its constituents, the Board passed a motion endorsing Concept 2.

The project design team presented at the Littleton Station Area Visioning Study Community Meeting listening session at Littleton Middle School on April 5, 2019 and the follow-up community visioning session on April 6, 2019. The event was hosted by The Town of Littleton Planning Department.

A required 25% design submission public hearing was hosted by MassDOT. The meeting took place virtually on May 28, 2020. MassDOT recorded the meeting and held an extended mail-in public comment period. The preferred alternative was selected after the conclusion of the design public hearing process.

After the design public hearing comment period, the design continued to be refined as MassDOT performed design reviews at 75% and 100% design stages.

4.3 Erosion and Sedimentation Control

The proposed project will enact erosion and sediment control during construction using the following methods.

- **Sediment Control Barriers**

Staked compost filter tubes or equivalent are proposed for sediment control barriers. The placement of sedimentation control barriers for the Project are shown on the Construction Plans section of the proposed project plans in Appendix B. The construction details section of the proposed plans includes a typical example of a compost filter tube installation. Silt fence is included as incidental to the item when required at sensitive resource areas.

- **SWPPP**

Sedimentation control for the proposed project will be implemented through the National Pollutant Discharge Elimination System (NDPES) required Storm Water Pollution and Protection Plan (SWPPP) which must be prepared by the contractor prior to the commencement of construction. The Plan will include the General Permit conditions and detailed descriptions of erosion and sedimentation controls to be implemented during construction. The SWPPP plan requires weekly inspection and monthly reporting of the condition of erosion controls. The Town will be included on the distribution list of the inspection forms and reports.

- **Silt Sacks**

Silt sacks shall be installed in retained existing catch basins and drop inlets within the project limits and as required by the MassDOT Resident Engineer to prevent sediment from entering existing catch basins during construction. The Contractor shall inspect the condition of silt sacks after each rainstorm and

during major rain events. Silt sacks shall be cleaned periodically to remove and dispose of accumulated debris as required. Silt sacks, which become damaged during construction operations, shall be repaired or replaced immediately at no additional cost to the Department. When emptying the silt sack, the contractor shall take all due care to prevent sediment from entering the structure. Any silt or other debris found in the drainage system at the end of construction shall be removed at the Contractors expense. The silt and sediment from the silt sack shall be legally disposed of offsite. Under no condition shall silt and sediment from the insert be deposited on site and used in construction.

4.4 Sequence of Construction Activities

The Project is proposed to be constructed in a single phase under the control and oversight of MassDOT who will provide on-site construction administrative and inspection services during the entire construction duration.

Although the contractor will have the ability to propose adjusting the sequence of work to optimize scheduling and efficiency, or may perform work simultaneously, a general sequence of construction is as follows:

- Creation of a Storm Water Pollution and Prevention Plan (SWPPP)
- Erosion and sedimentation control installation
- Establishment of contractor access and laydown areas outside of resource areas
- Work zone safety signage establishment including rail crossing location and temporary traffic guidance
- Removal of vegetation within the limit of work as needed for access
- Work on underground utilities including water main installation and storm drainage
- Work on overhead utilities
- Testing of new water main
- Excavation and grading to establish new sub-base of shared-use path and road
- Installation of curbing, sidewalk ramps, guardrail, fencing and new permanent traffic safety signage
- Full-depth paving of shared use path and road
- Establish plantings and loam/seed
- Installation of pavement markings
- Restoration of temporary work areas and removal of temp signage
- Removal of erosion and sedimentation controls

5 310 CMR 10.00 WPA Regulations Review

This section describes how the project conforms to the relevant provisions of 310 CMR 10.00, the Wetland Protection Act, enumerates the proposed project impacts to resource areas, and describes how the project meets performance standards under the Act.

5.1 Limited Project Status

Under 310 CMR 10.53, projects may be eligible as a limited project:

“Notwithstanding the provisions of 310 CMR 10.54 through 10.58 and 10.60, the Issuing Authority may issue an Order of Conditions and impose such conditions as will contribute to the interests identified in M.G.L. c. 131, § 40 permitting the following limited projects (although no such project may be permitted which will have any adverse effect on specified habitat sites of Rare Species, as identified by procedures established under 310 CMR 10.59). In determining whether to exercise its discretion to approve the limited projects listed in 310 CMR 10.53(3), the Issuing Authority shall consider the following factors: the magnitude of the alteration and the significance of the project site to the interests identified in M.G.L. c. 131, § 40, the availability of reasonable alternatives to the proposed activity, the extent to which adverse impacts are minimized, and the extent to which mitigation measures, including replication or restoration, are provided to contribute to the protection of the interests identified in M.G.L. c. 131, § 40.”

The project is eligible as a limited project under 310 CMR 10.53(3)(f) which stipulates that:

“Maintenance and improvement of existing public roadways, but limited to widening less than a single lane, adding shoulders, correcting substandard intersections, and improving inadequate drainage systems.”

The proposed widening of paved surface in the Foster Street Corridor is 6ft wide. This is less than the width of a single traffic lane, which has a typical minimum of 10ft wide. The widening on Foster Street is not providing an additional lane for motorized vehicle travel, but instead a non-motorized shared-use path.

5.2 Bank (310 CMR 10.54)

Bank was delineated in the project area as shown on the plans in Appendix B. Bank flags are found in the project area at the following locations:

- On the property of 300 Foster Street. Between project stations 9+00 and 10+75 on the east side of Foster Street. The flag series in the plans is A100-A116. There is an open freshwater body adjacent to a culvert located beneath Foster Street.

- On MassDOT property, between project stations 24+75 and 25+00, there is an intermittent stream flowing from a culvert underneath Foster Street. The flag series in the plans is F600-F602 (R&L) on the west side of Foster Street. On the east side of Foster Street the flag series are H800-803 and I900-901.

No temporary or permanent impacts to Bank are proposed by the project.

5.3 Bordering Vegetative Wetland (310 CMR 10.55)

BVW was delineated in the project area as shown on the plans in Appendix B. BVW flags are found in the project area at the following locations:

- On the east side of Foster Street at the property of 260 Foster Street. Between project stations 30+50 and 33+00. Flag series K200-K220.
- On the east side of Foster Street and adjacent to Grimes at the property of 260 Foster Street. Between project stations 26+50 and 30+25. Flag series L300-L326.
- On the west side of Foster Street at the property of 295 Foster Street. Between project stations 9+00 and 10+50. Flag series B200-B205.
- On the west side of Foster Street at the property of 295 Foster Street. Between project stations 10+40 and 10+45. Flag series C300-C309.
- On the west side of Foster Street at the property of 295 Foster Street. Between project stations 12+00 and 17+00. Flag series D400-D405.
- On the east side of Foster Street at the properties of 300 and 290 Foster Street. Between project stations 13+50 and 14+50. Flag series E500-E503.
- On the east side of Foster Street at the property of the Mass. Dept of Transportation. Between project stations 24+75 and 25+00. Flag series J100-104.

No temporary or permanent impacts to BVW are proposed by the project.

5.4 Land Under Water (310 CMR 10.56)

LUW is found in the project area at the locations described under Bank.

No temporary or permanent impacts to LUW are proposed by the project.

5.5 Land Subject to Flooding (310 CMR 10.57)

The Federal Emergency Management Agency (FEMA) Flood Insurance Rate Map (FIRM) does not depict areas of potential flooding in the project limits. Bordering Land Subject to Flooding (BLSF) is not mapped as overlapping at the project site. BLSF is defined in 310 CMR 10.57 (2)(a)(1) as “an area with low, flat topography adjacent to and inundated by flood waters rising from creeks, rivers, streams, ponds or lakes. It extends from the banks of these waterways and water bodies; where a bordering vegetated wetland occurs, it extends from said wetlands.” No temporary or permanent impacts to BLSF

or ILSF are proposed by the project. The FEMA FIRM map panels for the project are provided in Appendix A.

5.6 Riverfront Area (310 CMR 10.58)

There is no Riverfront Area within the project limits. No temporary or permanent impacts to Riverfront Area are proposed by the project.

5.7 100-ft Buffer Zone (310 CMR 10.02(2)(b))

The project work limit area contains a total of 116,466 SF (2.67 AC) of 100-ft Buffer Zone measured from BVW and Bank. The existing impervious area within the 100-ft Buffer Zone is 50,517 SF (1.16 AC).

Permanent impacts are calculated as the area of new impervious surface from the shared use path or realignment of the road. Temporary impacts for the project are areas to be disturbed by construction activities, but ultimately returned to a vegetated cover with loam & seed. Table 1 summarizes the existing and proposed impacts to the 100-ft Buffer Zone.

Table 1: Buffer Zone Impacts

100-FT Buffer from BVW or Bank			
Description	Area (SF/ AC)	Perm./Temp.	Cause/Descrip. Of Impacts
Total Zone Area in Project Limit	116,466/ 2.67	-	-
Existing Impervious	50,517/ 1.16	Perm.	Road surface, Sidewalk
Net Change in Impervious	15,768/ 0.36	Perm.	Road surface, Shared-use path
Proposed Impervious	66,285/ 1.52	Perm.	Road surface, Shared-use path
Temp. Impacts	35,344/ 0.81	Temp.	Earthwork, grading, grubbing. To be restored with loam & seed

The net increase of proposed permanent impact to 100-ft Buffer Zone is 15,768 SF or 0.36 AC within the 5.37 AC and 0.81-mile-long project area.

The general provisions of 310 CMR 10.53 states that:

“The Issuing Authority may consider the characteristics of the Buffer Zone, such as the presence of steep slopes, that may increase the potential for adverse impacts on Resource Areas. Conditions may include limitations on the scope and location of work in the Buffer Zone as necessary to avoid alteration of Resource Areas. The Issuing Authority may require erosion and

sedimentation controls during construction, a clear limit of work, and the preservation of natural vegetation adjacent to the Resource Area and/or other measures commensurate with the scope and location of the work within the Buffer Zone to protect the interests of M.G.L. c. 131, § 40. Where a Buffer Zone has already been developed, the Issuing Authority may consider the extent of existing development in its review of subsequent proposed work and, where prior development is extensive, may consider measures such as the restoration of natural vegetation adjacent to a Resource Area to protect the interest of M.G.L. c. 131, § 40.”

As a linear transportation project in an existing corridor, the project was not able to avoid the Buffer Zone. The design alternatives analysis, described in Section 4.2, did select a preferred alternative that is 1ft narrower in total pavement width than the next alternate design. The impacted Buffer Zone is a previously developed road corridor. The project proposes an erosion and sediment control plan as described in Section 4.3 and shown on the plans. The project also proposes to revegetate the temporary impact areas within the Buffer Zone with loam & seed.

6 Stormwater Report

The project is located in the Merrimack Watershed. The receiving waters for the project include Beaver Brook, a category 3 impaired waterway for bacteria/pathogens. Also Mill Pond, a freshwater lake and a category 5 impaired waterway for not supporting aesthetic, primary contact, or secondary contact due to macrophytes.

The project is eligible as a redevelopment and a limited project under the Wetlands Protection Act. The following is a description of how the proposed project meets the stormwater standards to the maximum extent practicable in accordance with the Massachusetts Stormwater Handbook.

The project will result in a net increase of an additional 0.612 acres of impervious area within the project limits distributed along the 0.75 mile long linear Foster Street corridor. Upgrades to the storm water system are proposed to the maximum extent practicable.

Standard 1: No new stormwater conveyances (e.g. outfalls) may discharge untreated stormwater directly to or cause erosion in wetlands or waters of the Commonwealth

No new stormwater point source discharges to the resource areas are proposed as part of the redevelopment project. Two existing discharge points will be improved upon with new flared ends and rip rap protection. All other existing discharge points will remain as is. Installation of rip rap protection at refurbished outfalls will provide erosion protection, which is an improvement to the existing condition. The project complies with Standard 1.

Standard 2: Peak Rate Attenuation

Attenuation improvement has been proposed to the maximum extent practical. The project proposes improved attenuation through:

- 4 new leaching catch basins with 3 feet of sump depth
- 9 existing non-deep sump catch basins on Foster Street to be replaced with deep sump catch basins. A deep-sump catch basin has 4 feet of sump depth compare to 2-3ft for a non-deep sump catch basin
- 3 new deep sump catch basin locations are proposed on Foster Street
- 7 existing catch basins will be remodeled and repaired
- All other remaining catch basins will be cleaned of debris and sediment there by restoring original sump capacity

No new detention areas for attenuation are proposed outside of the width of road as this is a linear transportation project corridor where impacts to adjacent property and trees have been intentionally minimized. The project is a redevelopment and meets the Stormwater Standard 2 to the maximum extent practicable.

Standard 3: Stormwater Recharge

Recharge has been proposed to the maximum extent practicable. In the existing condition, recharge is provided by a combination of sheet flow to the road shoulder where infiltration occurs and by discharge where the closed drainage system outfalls. The proposed condition will also provide recharge by a combination infiltration by sheetflow at the edges of the shared-use path and outfall at existing discharge points. Improvements to recharge are provided by:

- Four new leaching catch basins on Foster Street will convey stormwater runoff to ground infiltration
- A riprap swale at the frontage of the MBTA Station will be repaired and rebuilt 5 feet offset from the existing location to accommodate the proposed shared-use path

No new infiltration areas are proposed outside road and shared-use path as this is a linear transportation corridor where impacts to adjacent property and trees have been intentionally minimized. The project is a redevelopment project and meets the Stormwater Standard 3 to the maximum extent practicable.

Standard 4: Water Quality

Water quality will be maintained and improved by the following:

- 4 new leaching catch basins
- 9 existing non-deep sump catch basins on Foster Street to be replaced with deep sump catch basins. A deep-sump catch basin has 4 feet of sump depth compare to 2-3ft for a non-deep sump catch basin
- 3 new deep sump catch basin locations are proposed on Foster Street
- 7 existing catch basins will be remodeled and repaired
- All other remaining catch basins will be cleaned of debris and sediment there by restoring original sump capacity

The proposed post-construction operation and maintenance of the closed drainage structures will maintain the treatment capability of the system. A suggested Long-term Operation and Maintenance Plan, including required maintenance activities and schedule of maintenance requirements is included in Appendix G. This is a redevelopment project and meets Stormwater Standard 4 to the maximum extent practicable. A TSS removal spread sheet for deep sump catch basins can be found in Appendix H. The deep sump catch basins will provide 25% TSS removal. The leaching catch basins will provide 25% TSS removal as they will be offline and not connected to a deep sum catch basin.

Standard #5: Land Uses with Higher Potential Pollutant Loads

Standard 5 does not apply to the project. The project does not contain any area of higher pollutant loads as defined by the Massachusetts Stormwater Handbook.

Standard #6: Critical Areas

Standard 6 does not apply to the project. This project does not contain any critical areas as defined by the Massachusetts Stormwater Handbook.

Standard #7: Redevelopment

This project is a redevelopment project. Standards 2, 3, and 4 are met to the maximum extent practicable. Standards 1, 8, 9, and 10 are met fully.

Standard #8: Construction Period Controls

It is anticipated that there will be no pollution created during the development of the site. Erosion and sedimentation controls will be implemented and maintained during construction until construction is complete and disturbed areas have been stabilized. This will be done in accordance with local, state, and federal requirements. Details of the erosion and sedimentation control measures are shown on the Site Plans located in Appendix B. The contractor will be responsible to ensure the correct implementation of the erosion and sedimentation controls. MassDOT will provide continuous on-site construction inspection to ensure contractor compliance with erosion and sedimentation controls.

The extent and schedule for the commencement of construction activities, grading, and soil stabilization measures will be recorded and maintained as part of the Stormwater Pollution Prevention Plan (SWPPP). The SWPPP will be completed and provided by the contractor prior to the start of construction in accordance with the EPA NPDES General Permit for Discharge from Construction activities.

Standard #9: Operation and Maintenance Plan

A Construction Operation and Maintenance (O&M) Plan has been developed for the redevelopment of the site and is included in Appendix G. The contractor and Town of Littleton shall be responsible for the construction operation and maintenance of the site.

A suggested Long-term Operation and Maintenance Plan, including required maintenance activities and schedule of maintenance requirements is included in Appendix G. The Town of Littleton will be responsible for post construction operation and maintenance of the site.

Standard #10: Illicit Discharge to Drainage System

This project does not contain illicit discharges to Stormwater Management Systems as defined in the Massachusetts Stormwater Handbook. A copy of the Illicit Impact Statement can be found in Appendix I.

7 Town of Littleton Wetland Protection Regulation Review

The performance standards of the Town of Littleton Wetland Protection Regulations are described in this section.

7.1 The 50-ft No-Disturbance Zone

The Town of Littleton observes a 50-ft No-Disturbance Zone where:

“No activities or work is permitted other than passive (foot or non-motorized vehicle) passage and removal of invasive vegetation if done in compliance with these Regulations. Except as noted, no vegetation may be disturbed, and the area should remain unchanged from its pre-project state.”

The project work limit area contains a total of 45,253 SF (1.04 AC) of 50-ft No-Disturbance Zone measured from BVW or Bank. Existing impervious area within the 50-ft No-Disturb Zone totals 14,655 SF (0.34 AC). The construction of the shared-use path and shifting of the existing road alignment in some locations will result in an additional 7,499 SF (0.17 AC) of impervious area within the 50-ft-No-Disturbance Zone.

Permanent impacts are calculated as the area of new impervious surface. Temporary impacts are areas that will be disturbed by construction activities such as earthwork and then returned to a vegetated cover with loam & seed. Table 2 summarizes the impacts to the 50-ft No Disturb Zone.

Table 2: 50-ft No Disturbance Zone Impacts

50-FT No Disturb Zone from BVW or Bank			
Description	Area (SF/ AC)	Perm./Temp.	Cause/Descrip. Of Impacts
Total Zone Area in Project Limit	45,253 / 1.04	-	-
Existing Impervious	14,655 / 0.34	Perm.	Road surface, Sidewalk
Net Change in Impervious	7,499 / 0.17	Perm.	Road surface, Shared-use path
Proposed Impervious	22,154 / 0.50	Perm.	Road surface, Shared-use path
Temp. Impacts	14,355 / 0.33	Temp.	Earthwork, grading, grubbing. To be restored with loam & seed

Only projects meeting the eligibility for a waiver under Section 1.4 of the Town Regulations may be exempt. See Section 8.4 for more information on the project's eligibility for a waiver.

7.2 Performance Standards in the 100-ft Buffer Zone

The Town performance standards for work in the 100-Ft Buffer Zone (Section 4.3 of the Littleton Wetland Bylaw Regulations) state that:

“The activity shall not significantly impair the values and functions of the adjacent Areas Subject to Protection. The quantity and quality of resource values and functions, as well as pre-project conditions, such as ground slope, soil conditions, vegetation, and prior disturbance of the site should be considered explicitly in making this determination. Any offsetting mitigation provided shall also be considered, including the inclusion of pedestrian and bicycle access rights-of-way in the project (which can reduce the pollutant runoff and climate change contribution associated with the project).”

The project proposes pedestrian and bicycle access on Foster Street in a safe, dedicated and separate facility. The project is a potentially important step toward a larger more complete network of bicycle and pedestrian access for the Town of Littleton and the MBTA commuter rail station. The shared-use path will contribute to the reduction in vehicular trips and emissions as a non-motorized link to commuter rail service and as a new recreational trail for local residents

7.3 Other Resource Areas

- The project limits are not within an area of NHESP Estimated Habitats of Rare Wildlife or NHESP Priority Habitats of Rare Species.
- There are no state certified vernal pools within the project limits.
- The project is not within an Area of Critical Environmental Concern.
- The project does not discharge or drain to a waterbody designated as an Outstanding Resource Water. The nearest ORW is Nagog Pond in Acton located 5.4 miles east of the project area.

Attached Figure 2 shows the most recent NHESP Habitats map of the project area as accessed from MassMapper showing data from the most recent NHESP Atlas.

7.4 Eligibility for Waiver

Section 1.4(2) of the Town Regulation states that:

“The Commission may also waive the provisions of Sections 4.2, 4.3, and/or 4.5, to permit any of the limited projects listed in 310 CMR 10.53(3)(a) through (t). In determining whether to exercise its discretion to approve a limited project, the Commission shall consider the following factors: the magnitude of the alteration, the significance of the project site to the

Interests Protected by the Bylaw, the availability of reasonable alternatives to the proposed activity, the extent to which adverse impacts are minimized, and the extent to which mitigation measures are provided to contribute to the protection of the Interests Protected by the Bylaw”

The magnitude of the alteration proposed by the project is small when compared to the overall project limits. The overall project limit totals 5.37 acres. The project area permanently impacting the 50-ft No-Disturb Zone is 0.16 acres, comprising a share of 3% of the total project area.

The significance of the project site to the interests protected by the Bylaw may be considered in context of roadside vegetation. The vegetated shoulders of Foster Street within the 50-ft No Disturb Zone have been in close proximity to the road and vehicular traffic with associated roadside mowing and stormwater runoff for many years. The project area does not contain NHESP priority or estimated habitats or vernal pools (see Figure 2 attached).

The availability of reasonable alternatives was evaluated as discussed in the Alternatives Analysis Section 5.2. The preferred alternative did reduce permanent impacts to the 50-ft- No-Disturb Zone by selecting a cross section with 1ft less of total new pavement width compared to an alternate design.

Impacts are proposed to be minimized via the sedimentation and erosion control measures proposed. All temporary impact areas will receive loam & seed to restore ground cover vegetation. A mitigating factor will be the creation of a new facility for non-motorized travel. The shared-use path may contribute to the reduction in vehicular trips and emissions as a link to commuter rail service and as a new recreational trail for local residents.

In summary, the applicant respectfully requests that the Littleton Conservation Commission find these measures adequately protective of the interests identified in the Town Bylaw and issue a waiver to the work described in this NOI and on the attached plans.


8 Conclusion

In Summary, the project proposes a new 10 foot wide separated shared-use path on Foster St while the road surface on Foster St will be narrowed by 4 feet. An unsafe intersection at Grimes Lane and Foster Street is proposed to be realigned. The project addresses vehicular, pedestrian, and bicycle safety. The project proposes an improved stormwater drainage system to the maximum extent practical including four new leaching catch basins and upgrades to some existing catch basins as described in Section 4. The project will also include the replacement of a 10 inch water main underneath Foster Street in an effort to 'dig once' and reduce sediment disturbance in the corridor.

Because the project area is an existing roadway and the project will not widen the road by the width of one lane, under 310 CMR, the project is eligible as a redevelopment project for stormwater management and also eligible as a limited project under 10.53(3)(f). The project proposes permanent and temporary impacts to 100-ft Buffer Zone and the Town of Littleton 50-ft No Disturbance Zone. All temporary impact areas will be revegetated with loam and grass seed. No other resource areas are proposed to be impacted. The applicant is requesting a Waiver from the Commission under the relevant provisions of Section 1.4(2) of the Town of Littleton Wetland Protection Regulations.

The applicant respectfully requests that the Littleton Conservation Commission find these measures adequately protective of the interests identified in the WPA and the Town Bylaw as presented in this NOI.

Figures

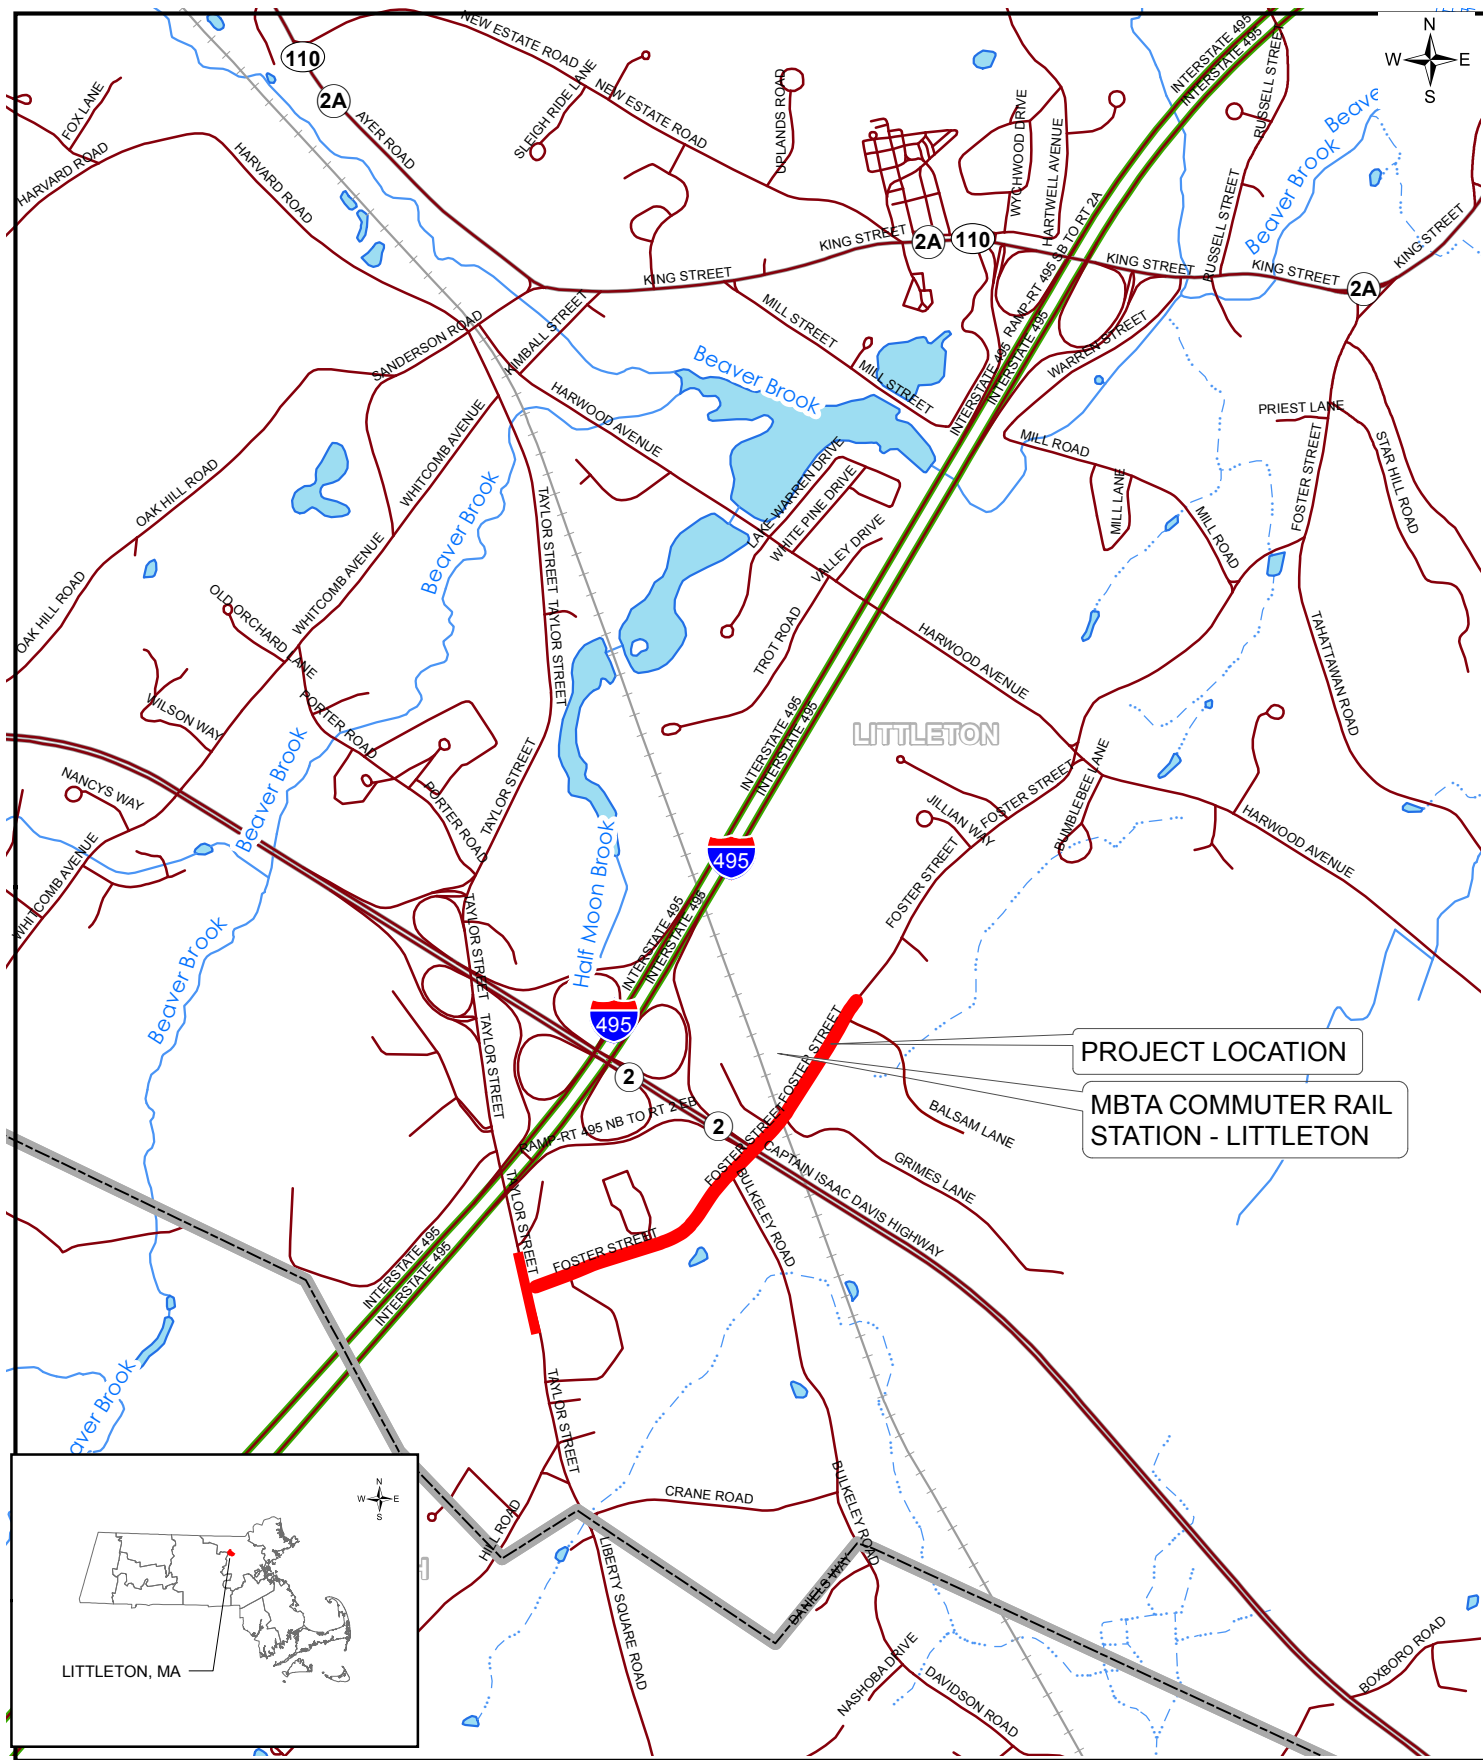

PROJECT LOCATION

MBTA COMMUTER RAIL
STATION - LITTLETON

0 1,000 2,000
Feet

Source: Office of Geographic and Environmental
Information (MassGIS), Commonwealth of
Massachusetts Executive Office of Environmental
Affairs



FUSS & O'NEILL

78 INTERSTATE DRIVE WEST SPRINGFIELD, MA 01089 413.452.0445

www.fando.com

RECONSTRUCTION OF FOSTER STREET
(PHASE I)

SITE LOCATION MAP

MASSDOT PROJ. #609054


LITTLETON

MASSACHUSETTS

PROJ. No. 20170044.A20
DATE: FEBRUARY 2018

FIG. 1

Figure2: Natural Resources Map

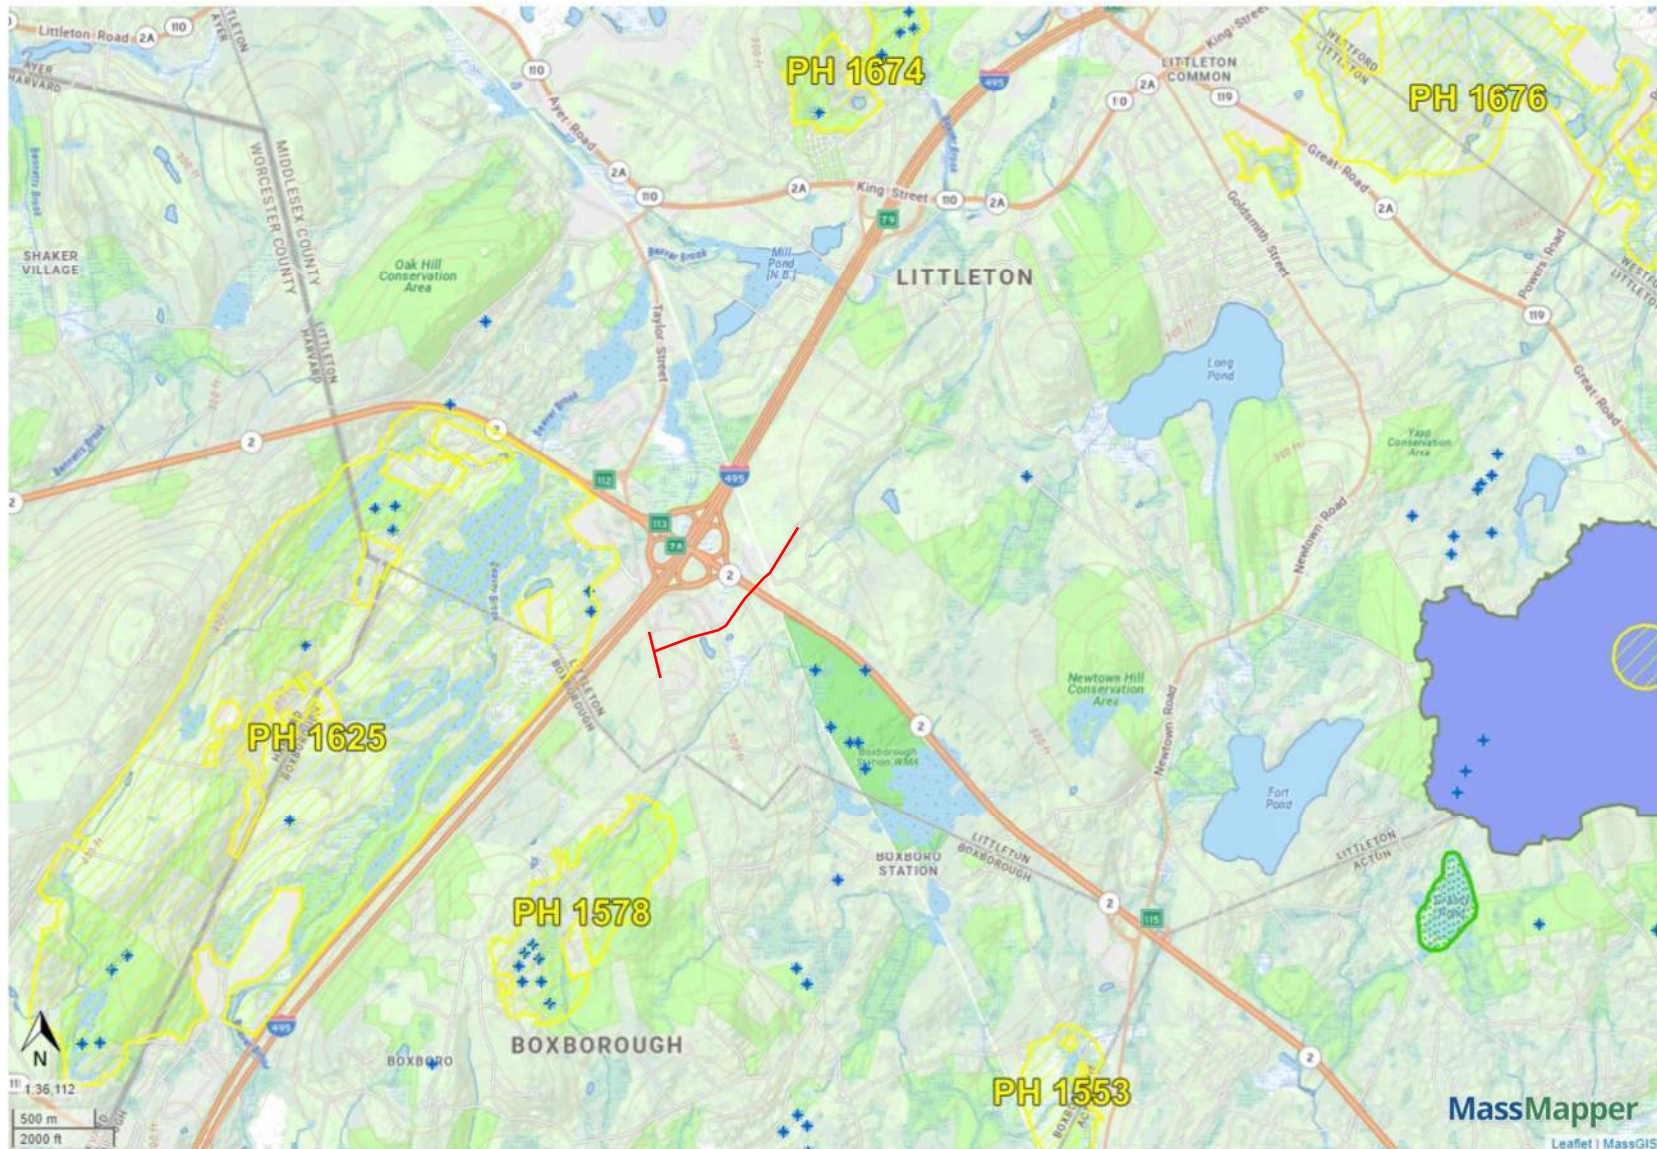

- NHESP Natural Communities
 -
- NHESP Priority Habitats of Rare Species
 -
- NHESP Estimated Habitats of Rare Wildlife
 -
- NHESP Certified Vernal Pools
 - ★
- Outstanding Resource Waters
 - ACEC
 - Cape Cod National Seashore
 - Protected Shoreline
 - Public Water Supply Watershed
 - Retired Public Water Supply
 - Scenic/Protected River
 - Wildlife Refuge

Project Extent

Accessed from
<https://maps.massgis.digital.mass.gov/MassMapper/MassMapper.html>

by A.Keegan, PE on
 4/18/2023

NHESP Data based on
 August 2021 NHESP
 Atlas

Appendix A

FEMA FIRM MAPS

NOTES TO USERS

This map is for use in administering the National Flood Insurance Program. It does not necessarily identify all areas subject to flooding, particularly from local drainage sources of small size. The community map repository should be consulted for possible updated or additional flood hazard information.

To obtain more detailed information in areas where **Base Flood Elevations (BFEs)** and/or **floodways** have been determined, users are encouraged to consult the Flood Profiles and Floodway Data and/or Summary of Stillwater Elevations tables contained within the Flood Insurance Study (FIS) Report that accompanies this FIRM. Users should be aware that BFEs shown on the FIRM represent rounded whole-foot elevations. These BFEs are intended for flood insurance rating purposes only and should not be used as the sole source of flood elevation information. Accordingly, flood elevation data presented in the FIS Report should be utilized in conjunction with the FIRM for purposes of construction and/or floodplain management.

Certain areas not in Special Flood Hazard Areas may be protected by **flood control structures**. Refer to Section 2.4 "Flood Protection Measures" of the Flood Insurance Study Report for information on flood control structures for this jurisdiction.

The **projection** used in the preparation of this map was Massachusetts State Plane Mainland Zone (FIPS zone 2001). The **horizontal datum** was NAD 83, GRS 1980 spheroid. Differences in datum, spheroid, projection or UTM zones used in the production of FIRMs for adjacent jurisdictions may result in slight positional differences in map features across jurisdiction boundaries. These differences do not affect the accuracy of this FIRM.

Flood elevations on this map are referenced to the North American Vertical Datum of 1988. These flood elevations must be compared to structure and ground elevations referenced to the same **vertical datum**. For information regarding conversion between the National Geodetic Vertical Datum of 1929 and the North American Vertical Datum of 1988, visit the National Geodetic Survey website at <http://www.ngs.noaa.gov> or contact the National Geodetic Survey at the following address:

NGS Information Services
NOAA, NNGS12
National Geodetic Survey
SSMC-3, #9202
1315 East-West Highway
Silver Spring, Maryland 20910-3282
(301) 713-3242

To obtain current elevation, description, and/or location information for **bench marks** shown on this map, please contact the Information Services Branch of the National Geodetic Survey at (301) 713-3242, or visit its website at <http://www.ngs.noaa.gov>.

Base map information shown on this FIRM was derived from orthophotography provided by MassGIS at a scale of 1:500 from photography dated April 2006.

The **profile baselines** depicted on this map represent the hydraulic modeling baselines that match the flood profiles in the FIS report. As a result of improved topographic data, the **profile baseline**, in some cases, may deviate significantly from the channel centerline or appear outside the SFHA.

This map reflects more detailed and up-to-date **stream channel configurations** than those shown on the previous FIRM for this jurisdiction. The floodplains and floodways that were transferred from the previous FIRM may have been adjusted to conform to these new stream channel configurations. As a result, the Flood Profiles and Floodway Data tables for multiple streams in the Flood Insurance Study Report (which contains authoritative hydraulic data) may reflect stream channel distances that differ from what is shown on this map.


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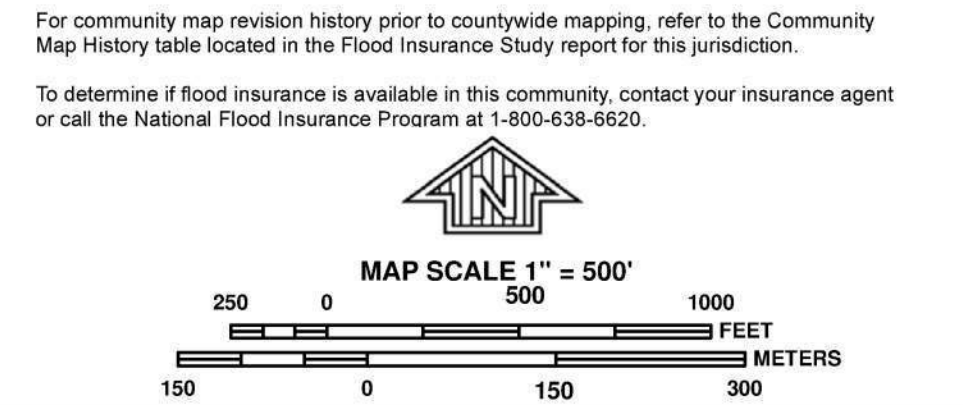
FLOOD HAZARD INFORMATION IS NOT SHOWN ON THIS MAP IN AREAS OUTSIDE OF MIDDLESEX COUNTY



LEGEND

- SPECIAL FLOOD HAZARD AREAS (SFHAs) SUBJECT TO INUNDATION BY THE 1% ANNUAL CHANCE FLOOD**
- The 1% annual chance flood (100-year flood), also known as the base flood, is the flood that has a 1% chance of being equaled or exceeded in any given year. The Special Flood Hazard Area is the area subject to flooding by the 1% annual chance flood. Areas of Special Flood Hazard include Zones A, AE, AH, AO, AR, A99, and VE. The Base Flood Elevation is the water-surface elevation of the 1% annual chance flood.
- ZONE A** No Base Flood Elevations determined.
- ZONE AE** Base Flood Elevations determined.
- ZONE AH** Flood depths of 1 to 3 feet (usually areas of ponding); Base Flood Elevations determined.
- ZONE AO** Flood depths of 1 to 3 feet (usually sheet flow on sloping terrain); average depths determined. For areas of alluvial fan flooding, velocities also determined.
- ZONE AR** Special Flood Hazard Areas formerly protected from the 1% annual chance flood by a flood control system that was subsequently destroyed. Zone AR indicates that the former flood control system is being restored to provide protection from the 1% annual chance or greater flood.
- ZONE A99** Area to be protected from 1% annual chance flood by a Federal flood protection system under construction; no Base Flood Elevations determined.
- ZONE VE** Coastal flood zone with velocity hazard (wave action); no Base Flood Elevations determined.
- ZONE V** Coastal flood zone with velocity hazard (wave action); Base Flood Elevations determined.
- FLOODWAY AREAS IN ZONE AE**
- The floodway is the channel of a stream plus any adjacent floodplain areas that must be kept free of encroachment so that the 1% annual chance flood can be carried without substantial increases in flood heights.
- OTHER FLOOD AREAS**
- ZONE X** Areas of 0.2% annual chance flood; areas of 1% annual chance flood with average depths of less than 1 foot or with drainage areas less than 1 square mile; and areas protected by levees from 1% annual chance flood.
- OTHER AREAS**
- ZONE X** Areas determined to be outside the 0.2% annual chance floodplain.
- ZONE D** Areas in which flood hazards are undetermined, but possible.
- COASTAL BARRIER RESOURCES SYSTEM (CBRS) AREAS**
- OTHERWISE PROTECTED AREAS (OPAs)**
- CBRS areas and OPAs are normally located within or adjacent to Special Flood Hazard Areas.
- 1% Annual Chance Floodplain Boundary
- 0.2% Annual Chance Floodplain Boundary
- Floodway boundary
- Zone D boundary
- CBRS and OPA boundary
- Boundary dividing Special Flood Hazard Area Zones and boundary dividing Special Flood Hazard Areas of different Base Flood Elevations, flood depths, or flood velocities.
- Base Flood Elevation line and value; elevation in feet*
- Base Flood Elevation value where uniform within zone; elevation in feet*

- * Referenced to the North American Vertical Datum of 1988
- Cross section line**
- Transect line**
- 45° 02' 08", 93° 02' 12"
- Geographic coordinates referenced to the North American Datum of 1983 (NAD 83) Western Hemisphere
- 4989000 M
- 1000-meter ticks: Massachusetts State Plane Mainland Zone (FIPS Zone 2001), Lambert Conformal Conic projection
- 1000-meter Universal Transverse Mercator grid values, zone 19
- Bench mark (see explanation in Notes to Users section of this FIRM panel)
- DX5510 X
- M1.5
- River Mile
- MAP REPOSITORIES**
- Refer to Map Repositories list on Map Index
- EFFECTIVE DATE OF COUNTYWIDE FLOOD INSURANCE RATE MAP**
- June 4, 2010
- EFFECTIVE DATE(S) OF REVISION(S) TO THIS PANEL**
- July 7, 2014 - to update corporate limits, to change Base Flood Elevations and Special Flood Hazard Areas, to add roads and road names, and to incorporate previously issued Letters of Map Revision.

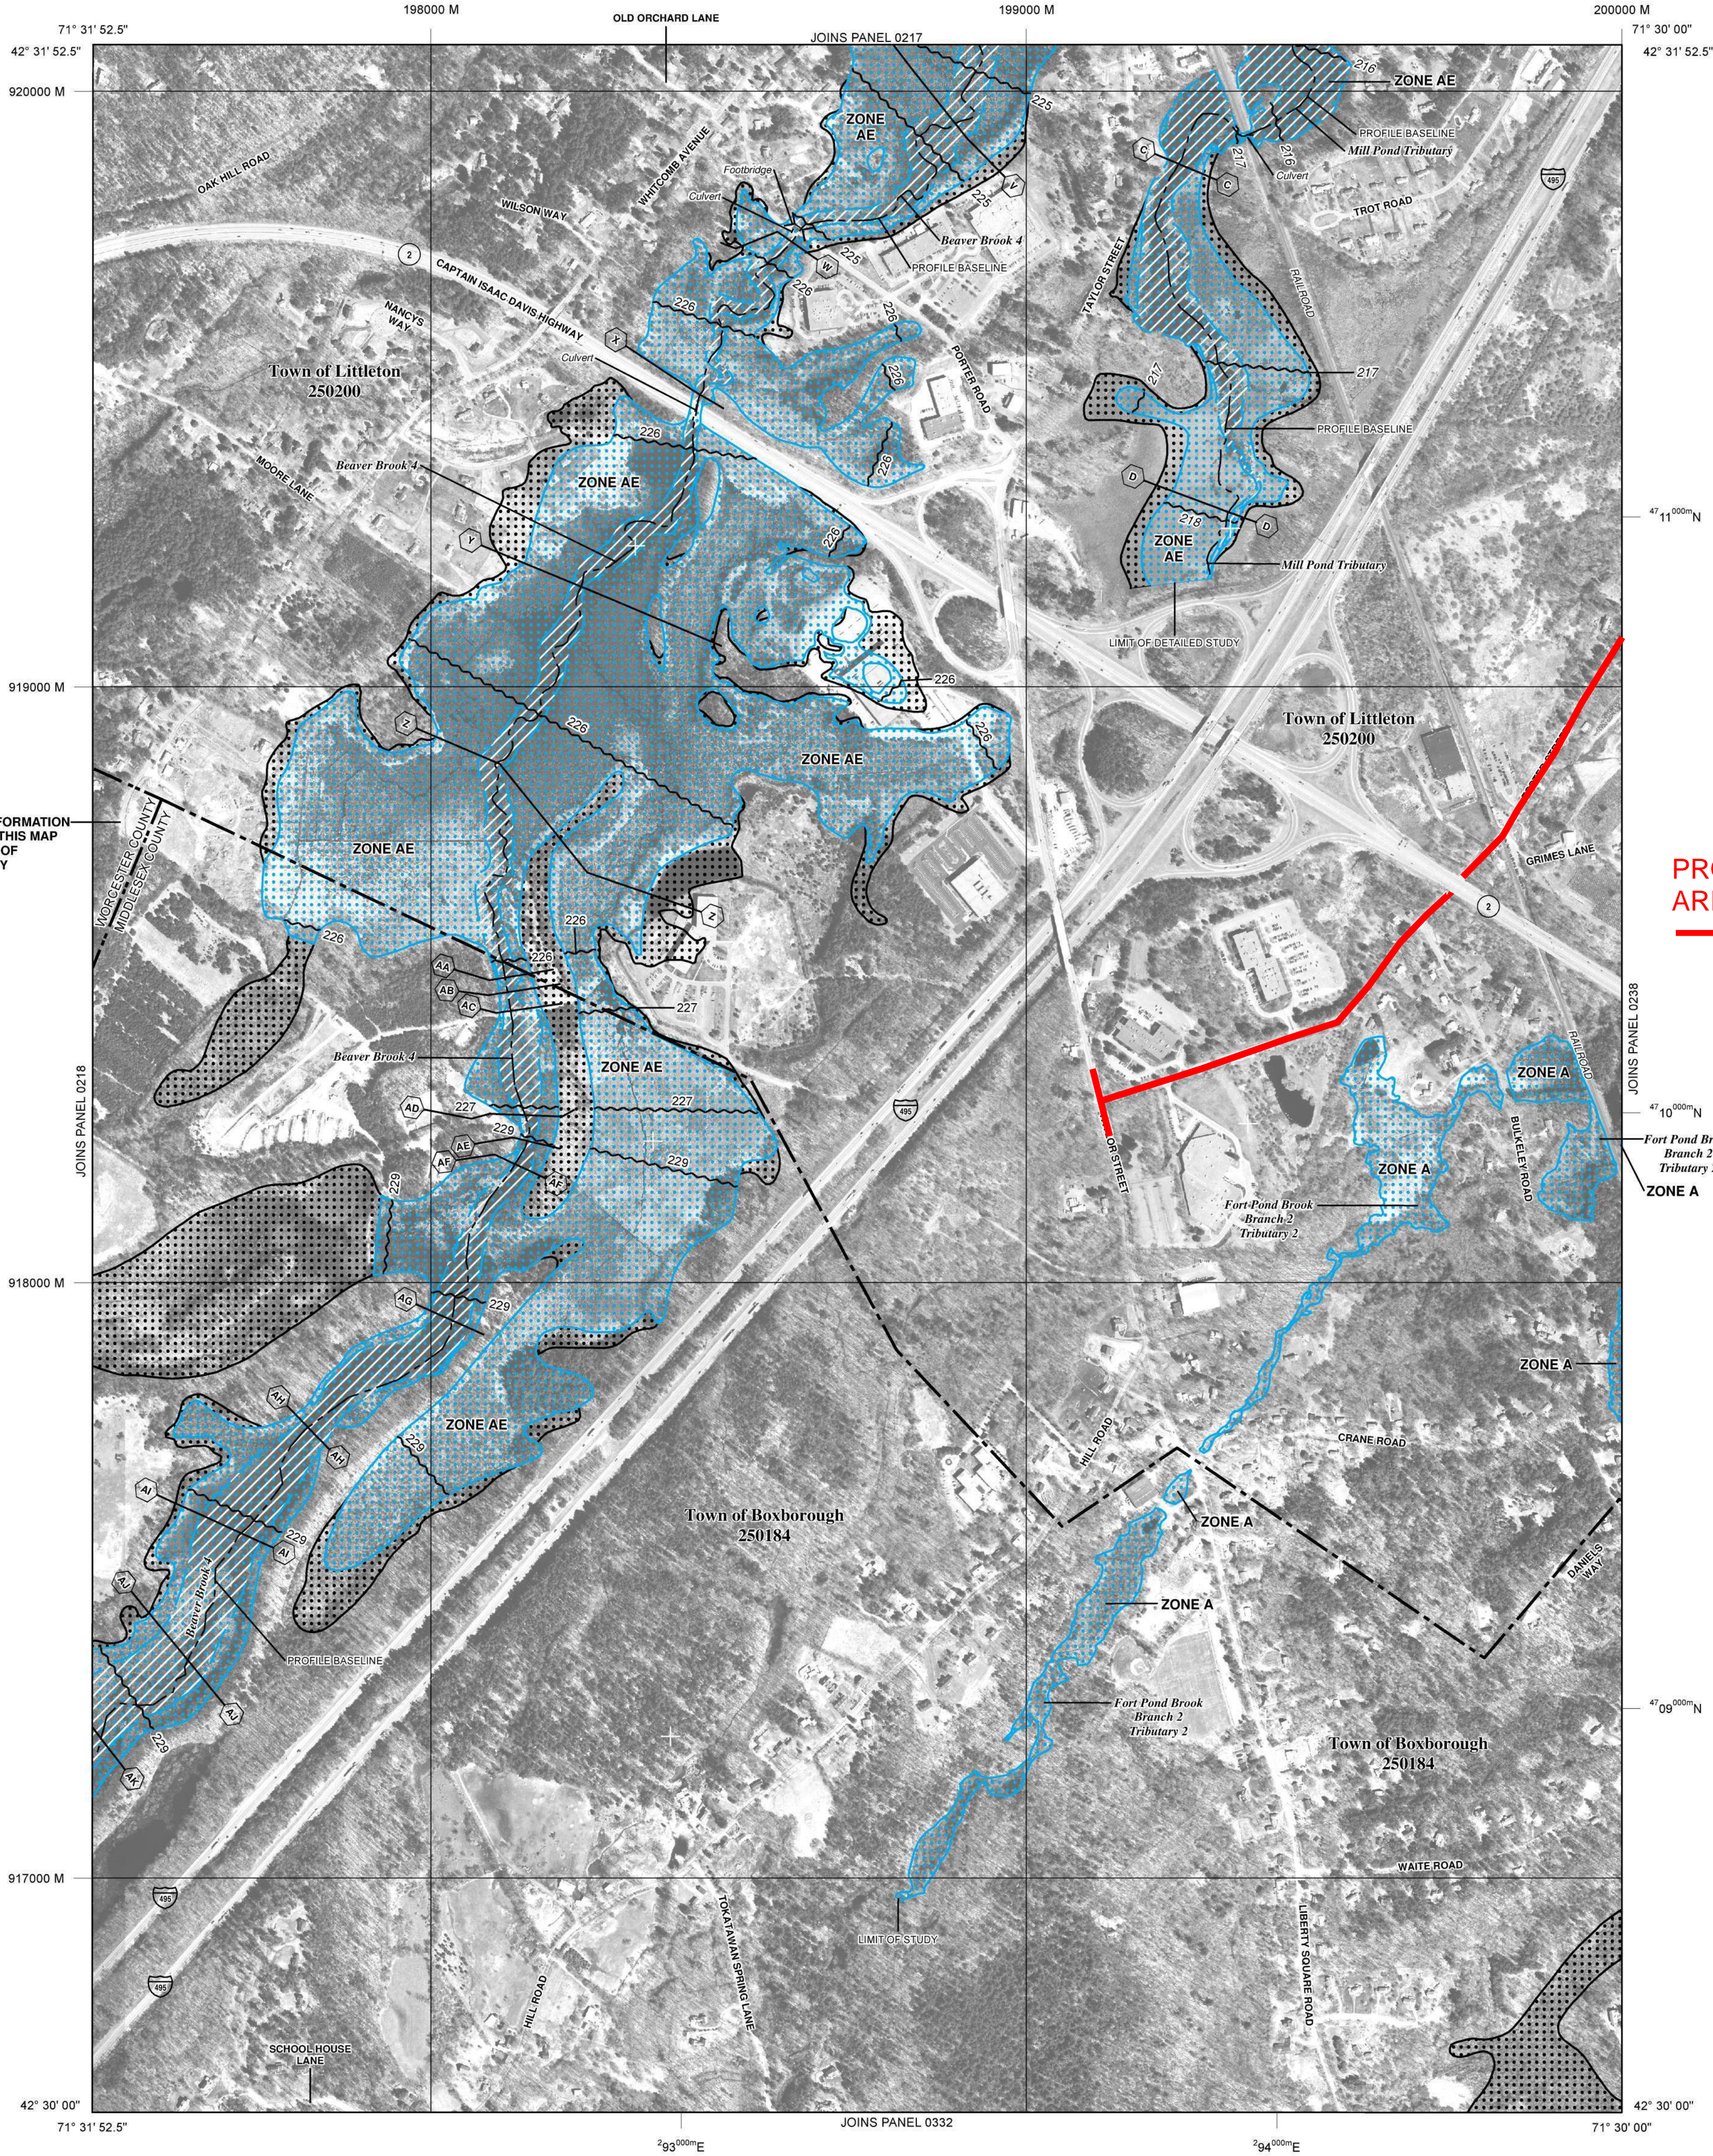

NATIONAL FLOOD INSURANCE PROGRAM

PANEL 0219F

FIRM

FLOOD INSURANCE RATE MAP

MIDDLESEX COUNTY, MASSACHUSETTS (ALL JURISDICTIONS)

PANEL 219 OF 656
(SEE MAP INDEX FOR FIRM PANEL LAYOUT)

CONTAINS:

COMMUNITY	NUMBER	PANEL	SUFFIX
BOXBOROUGH, TOWN OF	250184	0219	F
LITTLETON, TOWN OF	250200	0219	F

Notice to User: The **Map Number** shown below should be used when placing map orders; the **Community Number** shown above should be used on insurance applications for the subject community.

MAP NUMBER
25017C0219F

MAP REVISED
JULY 7, 2014

Federal Emergency Management Agency

NOTES TO USERS

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Boundaries of the **floodways** were computed at cross sections and interpolated between cross sections. The floodways were based on hydraulic considerations with regard to requirements of the National Flood Insurance Program. Floodway widths and other pertinent floodway data are provided in the Flood Insurance Study Report for this jurisdiction.

Certain areas not in Special Flood Hazard Areas may be protected by **flood control structures**. Refer to Section 2.4 "Flood Protection Measures" of the Flood Insurance Study Report for information on flood control structures for this jurisdiction.

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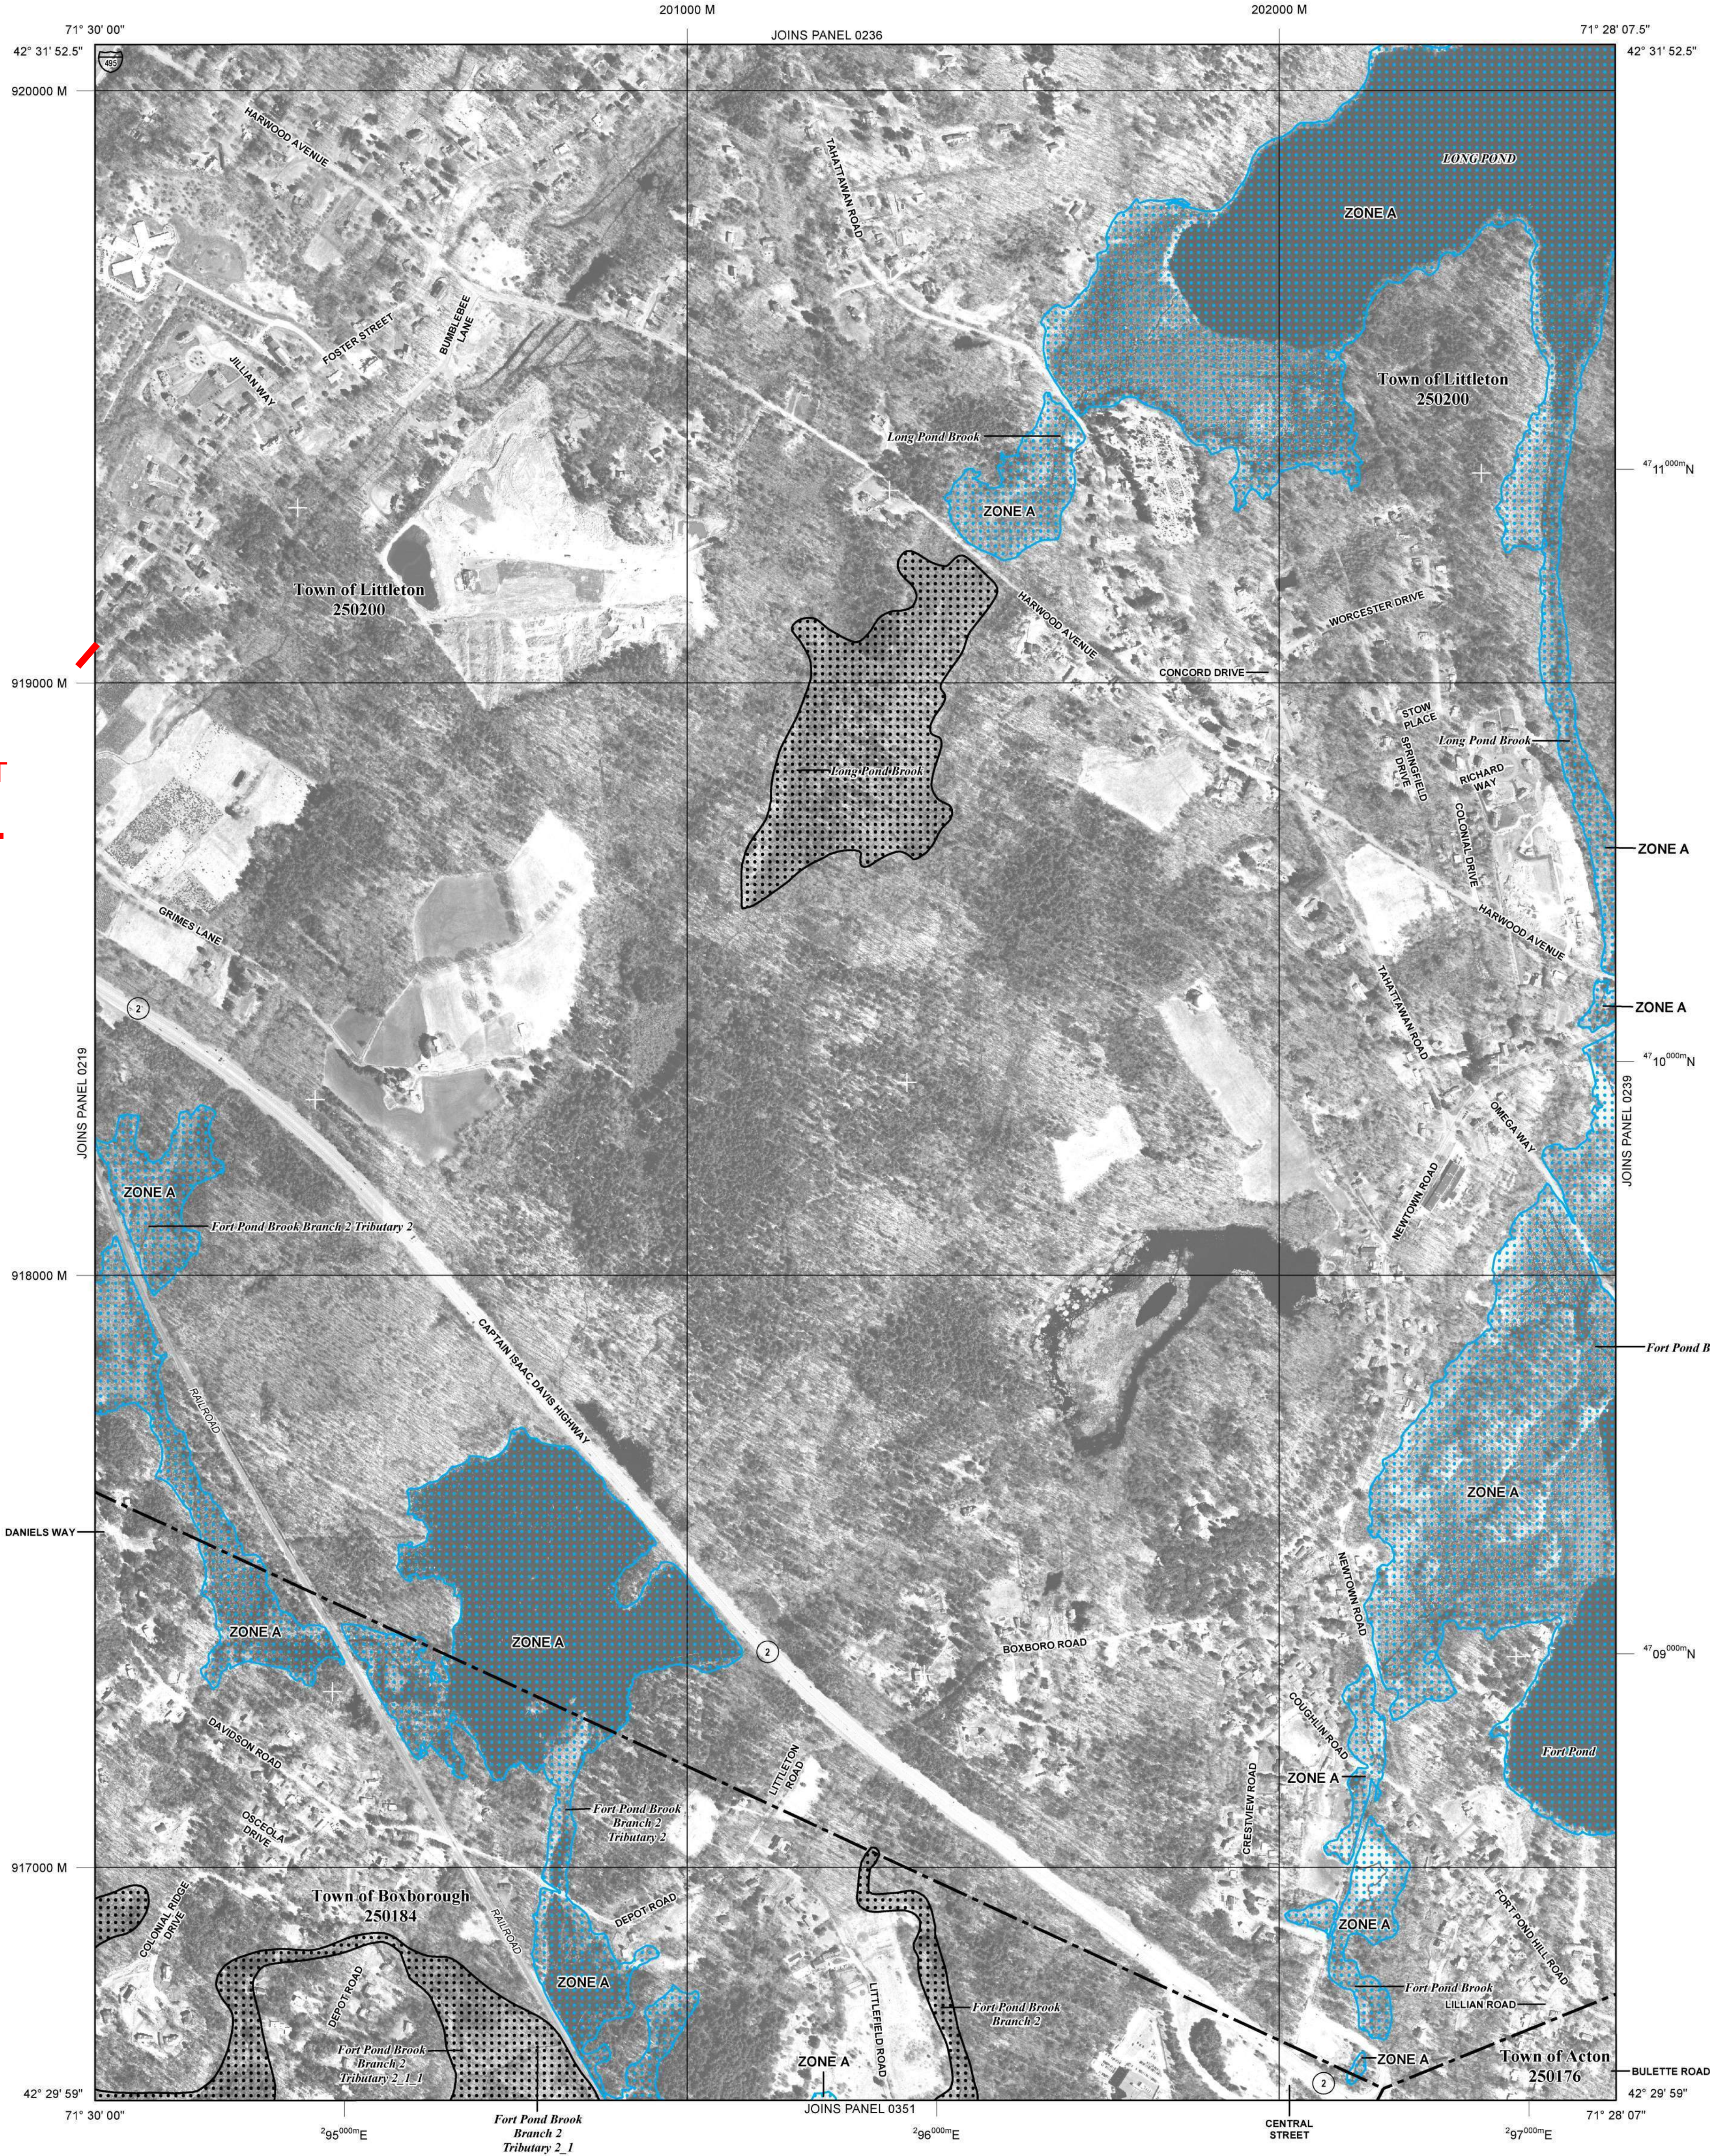
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PROJECT
AREA




LEGEND

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Floodway boundary
Zone D boundary
CBRS and OPA boundary
Boundary dividing Special Flood Hazard Area Zones and boundary dividing Special Flood Hazard Areas of different Base Flood Elevations, flood depths, or flood velocities.
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Transect line
45° 02' 08", 93° 02' 12"
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1000-meter Universal Transverse Mercator grid values, zone 19
DX5510 X
Bench mark (see explanation in Notes to Users section of this FIRM panel)
M1.5
River Mile
MAP REPOSITORIES
Refer to Map Repositories list on Map Index
EFFECTIVE DATE OF COUNTYWIDE FLOOD INSURANCE RATE MAP
June 4, 2010
EFFECTIVE DATE(S) OF REVISION(S) TO THIS PANEL
July 7, 2014 - to update corporate limits, to change Base Flood Elevations and Special Flood Hazard Areas, to add roads and road names, and to incorporate previously issued Letters of Map Revision.



NFIP
NATIONAL FLOOD INSURANCE PROGRAM

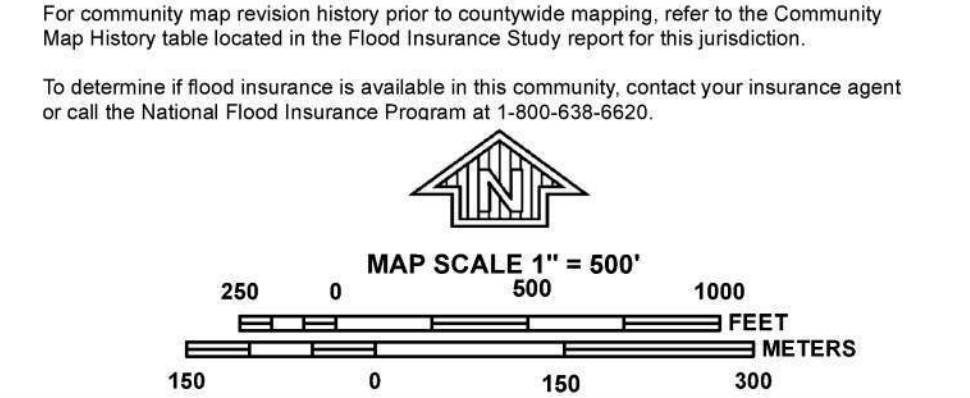PANEL 0238F

FIRM
FLOOD INSURANCE RATE MAP
MIDDLESEX COUNTY,
MASSACHUSETTS
(ALL JURISDICTIONS)

PANEL 238 OF 656
(SEE MAP INDEX FOR FIRM PANEL LAYOUT)

CONTAINS:

COMMUNITY	NUMBER	PANEL	SUFFIX
ACTON, TOWN OF	250176	0238	F
BOXBOROUGH, TOWN OF	250184	0238	F
LITTLETON, TOWN OF	250200	0238	F

Notice to User: The **Map Number** shown below should be used when placing map orders; the **Community Number** shown above should be used on insurance applications for the subject community.

MAP NUMBER
25017C0238F
MAP REVISED
JULY 7, 2014
Federal Emergency Management Agency

Appendix B

Project Plans

MASSACHUSETTS DEPARTMENT OF TRANSPORTATION
HIGHWAY DIVISION

PLAN AND PROFILE OF
FOSTER STREET
(BRIDGE NO. L-13-017)

IN THE TOWN OF
LITTLETON
MIDDLESEX COUNTY

FEDERAL AID PROJECT NO. XXX-XXXX(XXX)X

LITTLETON
RECONSTRUCTION OF FOSTER STREET

STATE	FED. AID PROJ. NO.	SHEET NO.	TOTAL SHEETS
MA	XXX-XXXX(XXX)X	1	129
PROJECT FILE NO.		609054	

TITLE SHEET & INDEX

THESE PLANS ARE SUPPLEMENTED BY THE OCTOBER 2017 CONSTRUCTION STANDARD DETAILS, THE 2015 OVERHEAD SIGNAL STRUCTURE AND FOUNDATION STANDARD DRAWINGS, MASSDOT TRAFFIC MANAGEMENT PLANS AND DETAIL DRAWINGS, THE 1990 STANDARD DRAWINGS FOR SIGNS AND SUPPORTS, THE 1968 STANDARD DRAWINGS FOR TRAFFIC SIGNALS AND HIGHWAY LIGHTING, AND THE LATEST EDITION OF THE AMERICAN STANDARD FOR NURSERY STOCK.

PERMITTING PLAN SET
100% SUBMITTAL

PERMITTING PLAN SET
PAGE NO.

1
2
3
4-8
9-16
17-24
25-31

32-39
40-47

48-55
56-61

62-117

SHEET NO.


1
2
3
4-8
9-16
E1-E8
17-23
~~25-32~~
33-40
41-48
~~49-50~~
~~51-56~~
57-64
68-70
~~71-73~~
74-129

INDEX

DESCRIPTION

TITLE SHEET & INDEX
LEGEND & ABBREVIATIONS
KEY PLAN & BORING LOCATIONS
TYPICAL SECTIONS
CONSTRUCTION PLANS
ENVIRONMENTAL PLANS
PROFILE - FOSTER STREET
CURB & BASELINE TIE PLANS *
GRADING PLANS
PAVEMENT MARKING & SIGNING PLANS
TRAFFIC SIGN SUMMARY SHEET *
TEMPORARY TRAFFIC CONTROL PLANS *
DRAINAGE & UTILITY PLANS
CONSTRUCTION DETAILS
WHEELCHAIR RAMP/DRIVEWAY DETAILS *
GROSS SECTIONS

*NOT INCLUDED IN PERMITTING PLAN SET

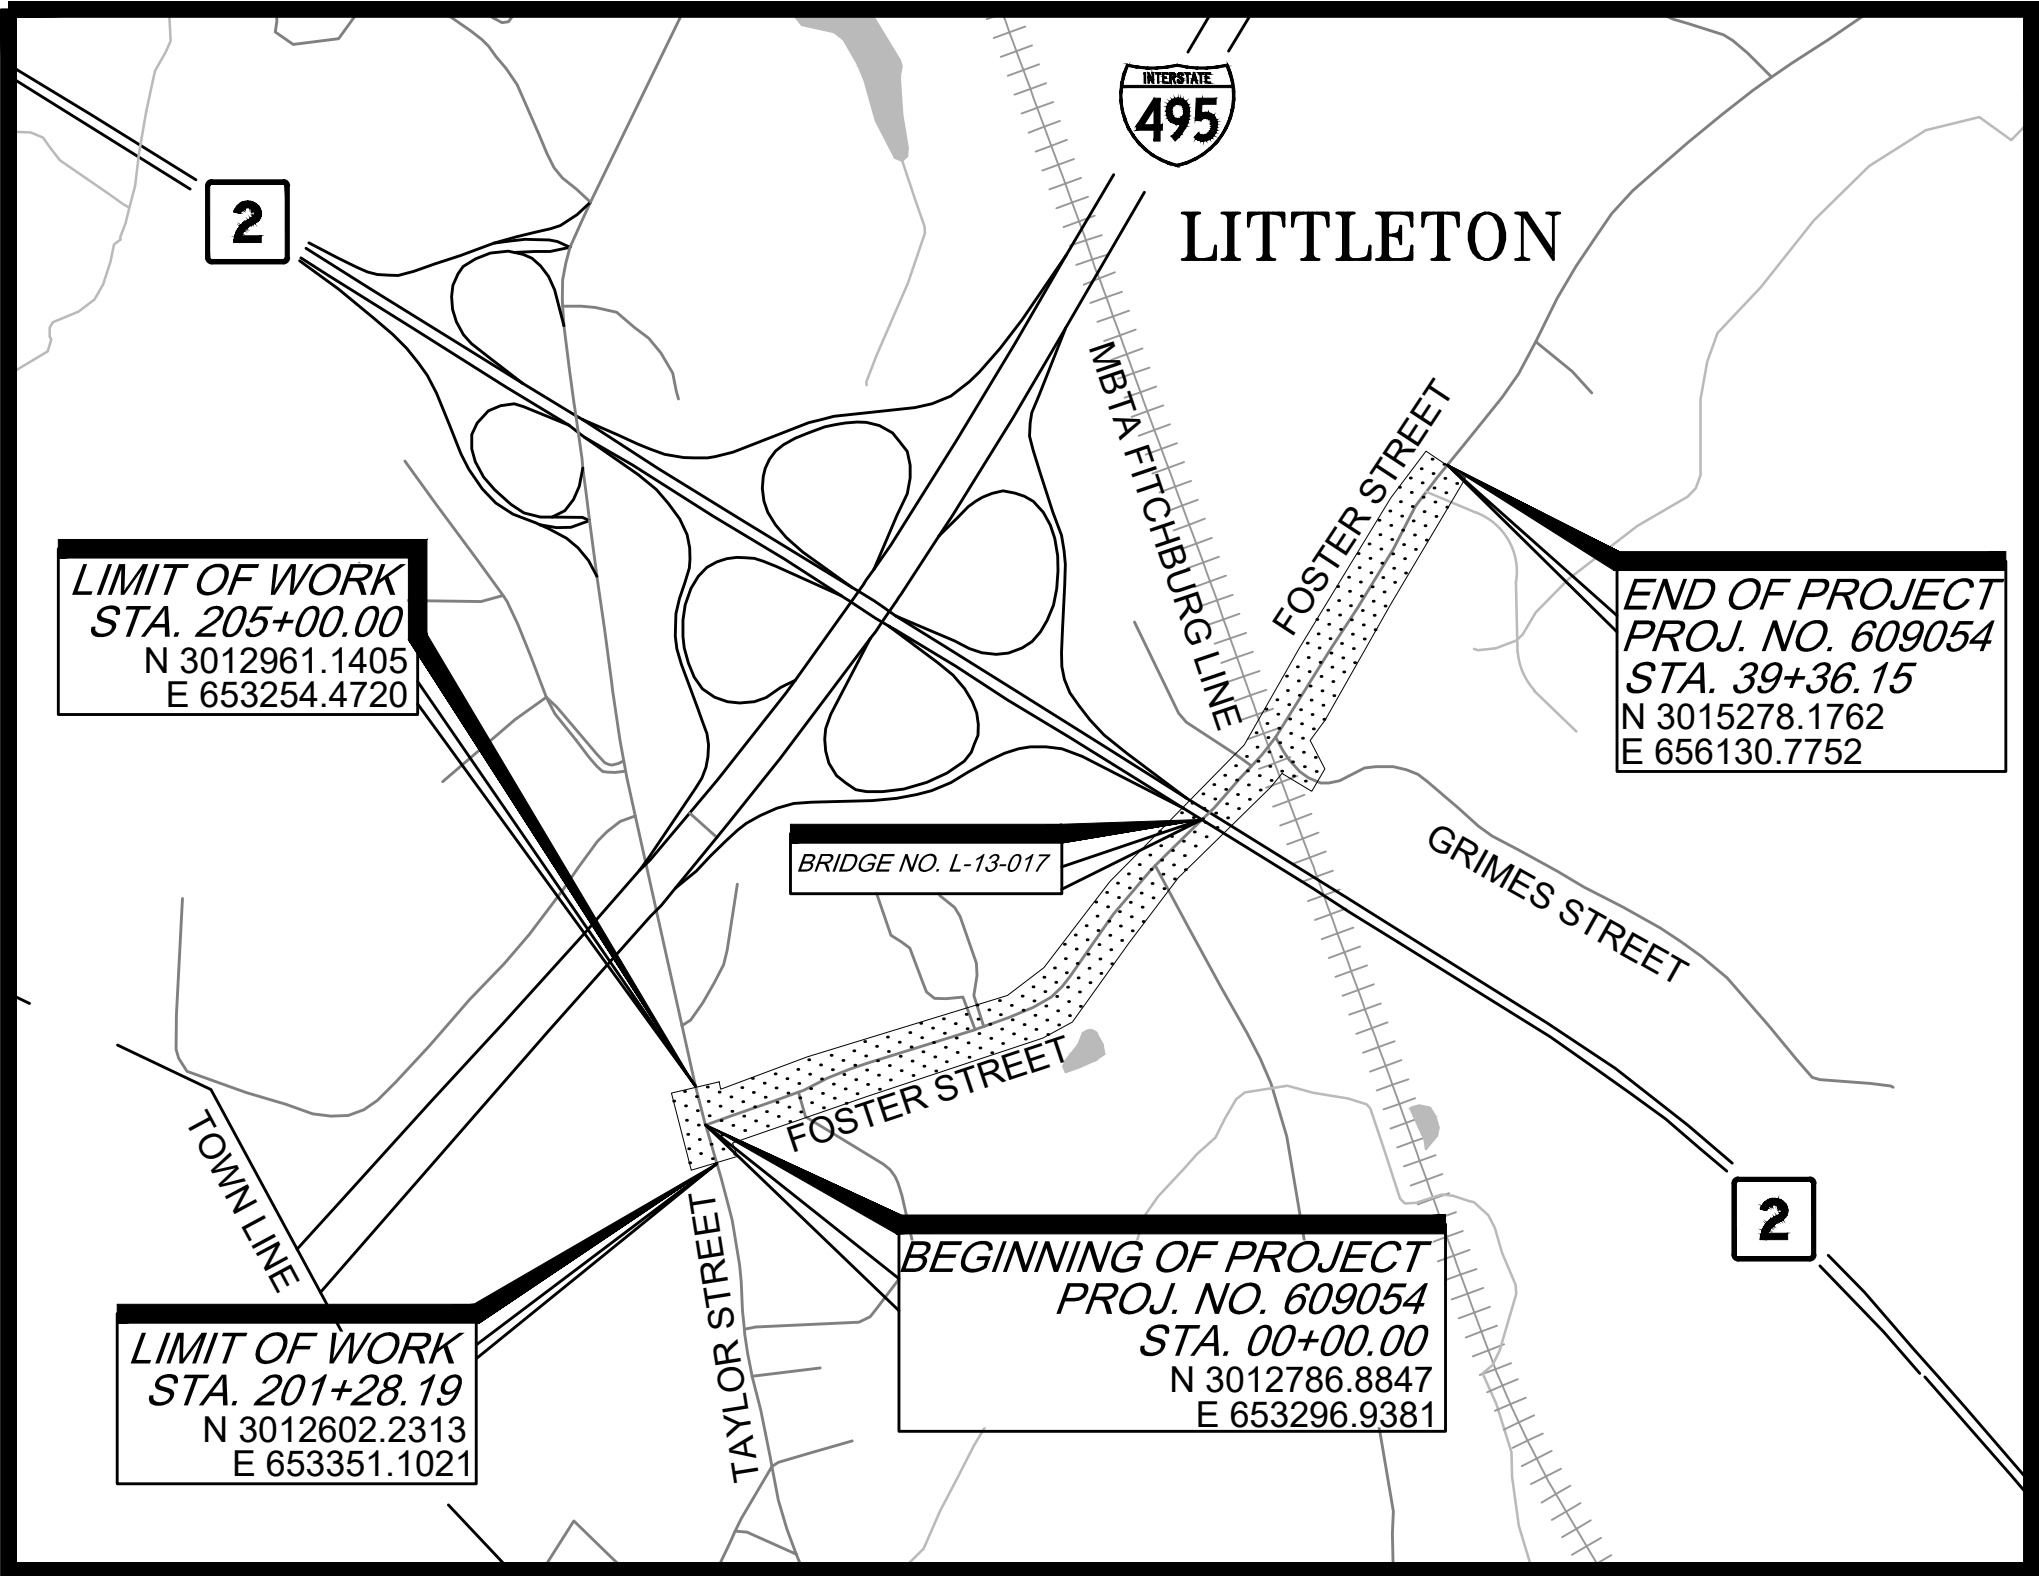

LENGTH OF PROJECT = 3936.15 FEET = 0.745 MILES
(FOSTER STREET)

NOT FOR CONSTRUCTION

DESIGN DESIGNATION (FOSTER STREET)

DESIGN SPEED	35 MPH
ADT (2017)	2,100
ADT (2037)	2,562
K	12%
D	69% (NB)
T (PEAK HOUR)	0.9%
T (AVERAGE DAY)	5.5%
DHV	252
DDHV	174 (NB)
FUNCTIONAL CLASSIFICATION	URBAN COLLECTOR


08-11-2023	NOI SUBMISSION	1
10-21-2022	100% SUBMISSION	1
11-18-2020	75% SUBMISSION	1
06-13-2019	25% SUBMISSION	1
03-14-2019	PRE-25% SUBMISSION	1
DATE	DESCRIPTION	REV #



APPROVED	
CHIEF ENGINEER	DATE

LITTLETON			
RECONSTRUCTION OF FOSTER STREET			
STATE	FED. AID PROJ. NO.	SHEET NO.	TOTAL SHEETS
MA	XXX-XXXX(XXX)X	2	129
PROJECT FILE NO.		609054	

File Path: J:\DWG\2017\0044\A21\KEY01.dwg Layout: KEY01 Plotted: Wed, April 19, 2023 - 1:47 AM User: akeegan
MS VIEW: - Layer: STATE: - Plotter: AUTOCAD PDF (GENERAL DOCUMENTATION) PC3 CTB File: MADOT-D.STB

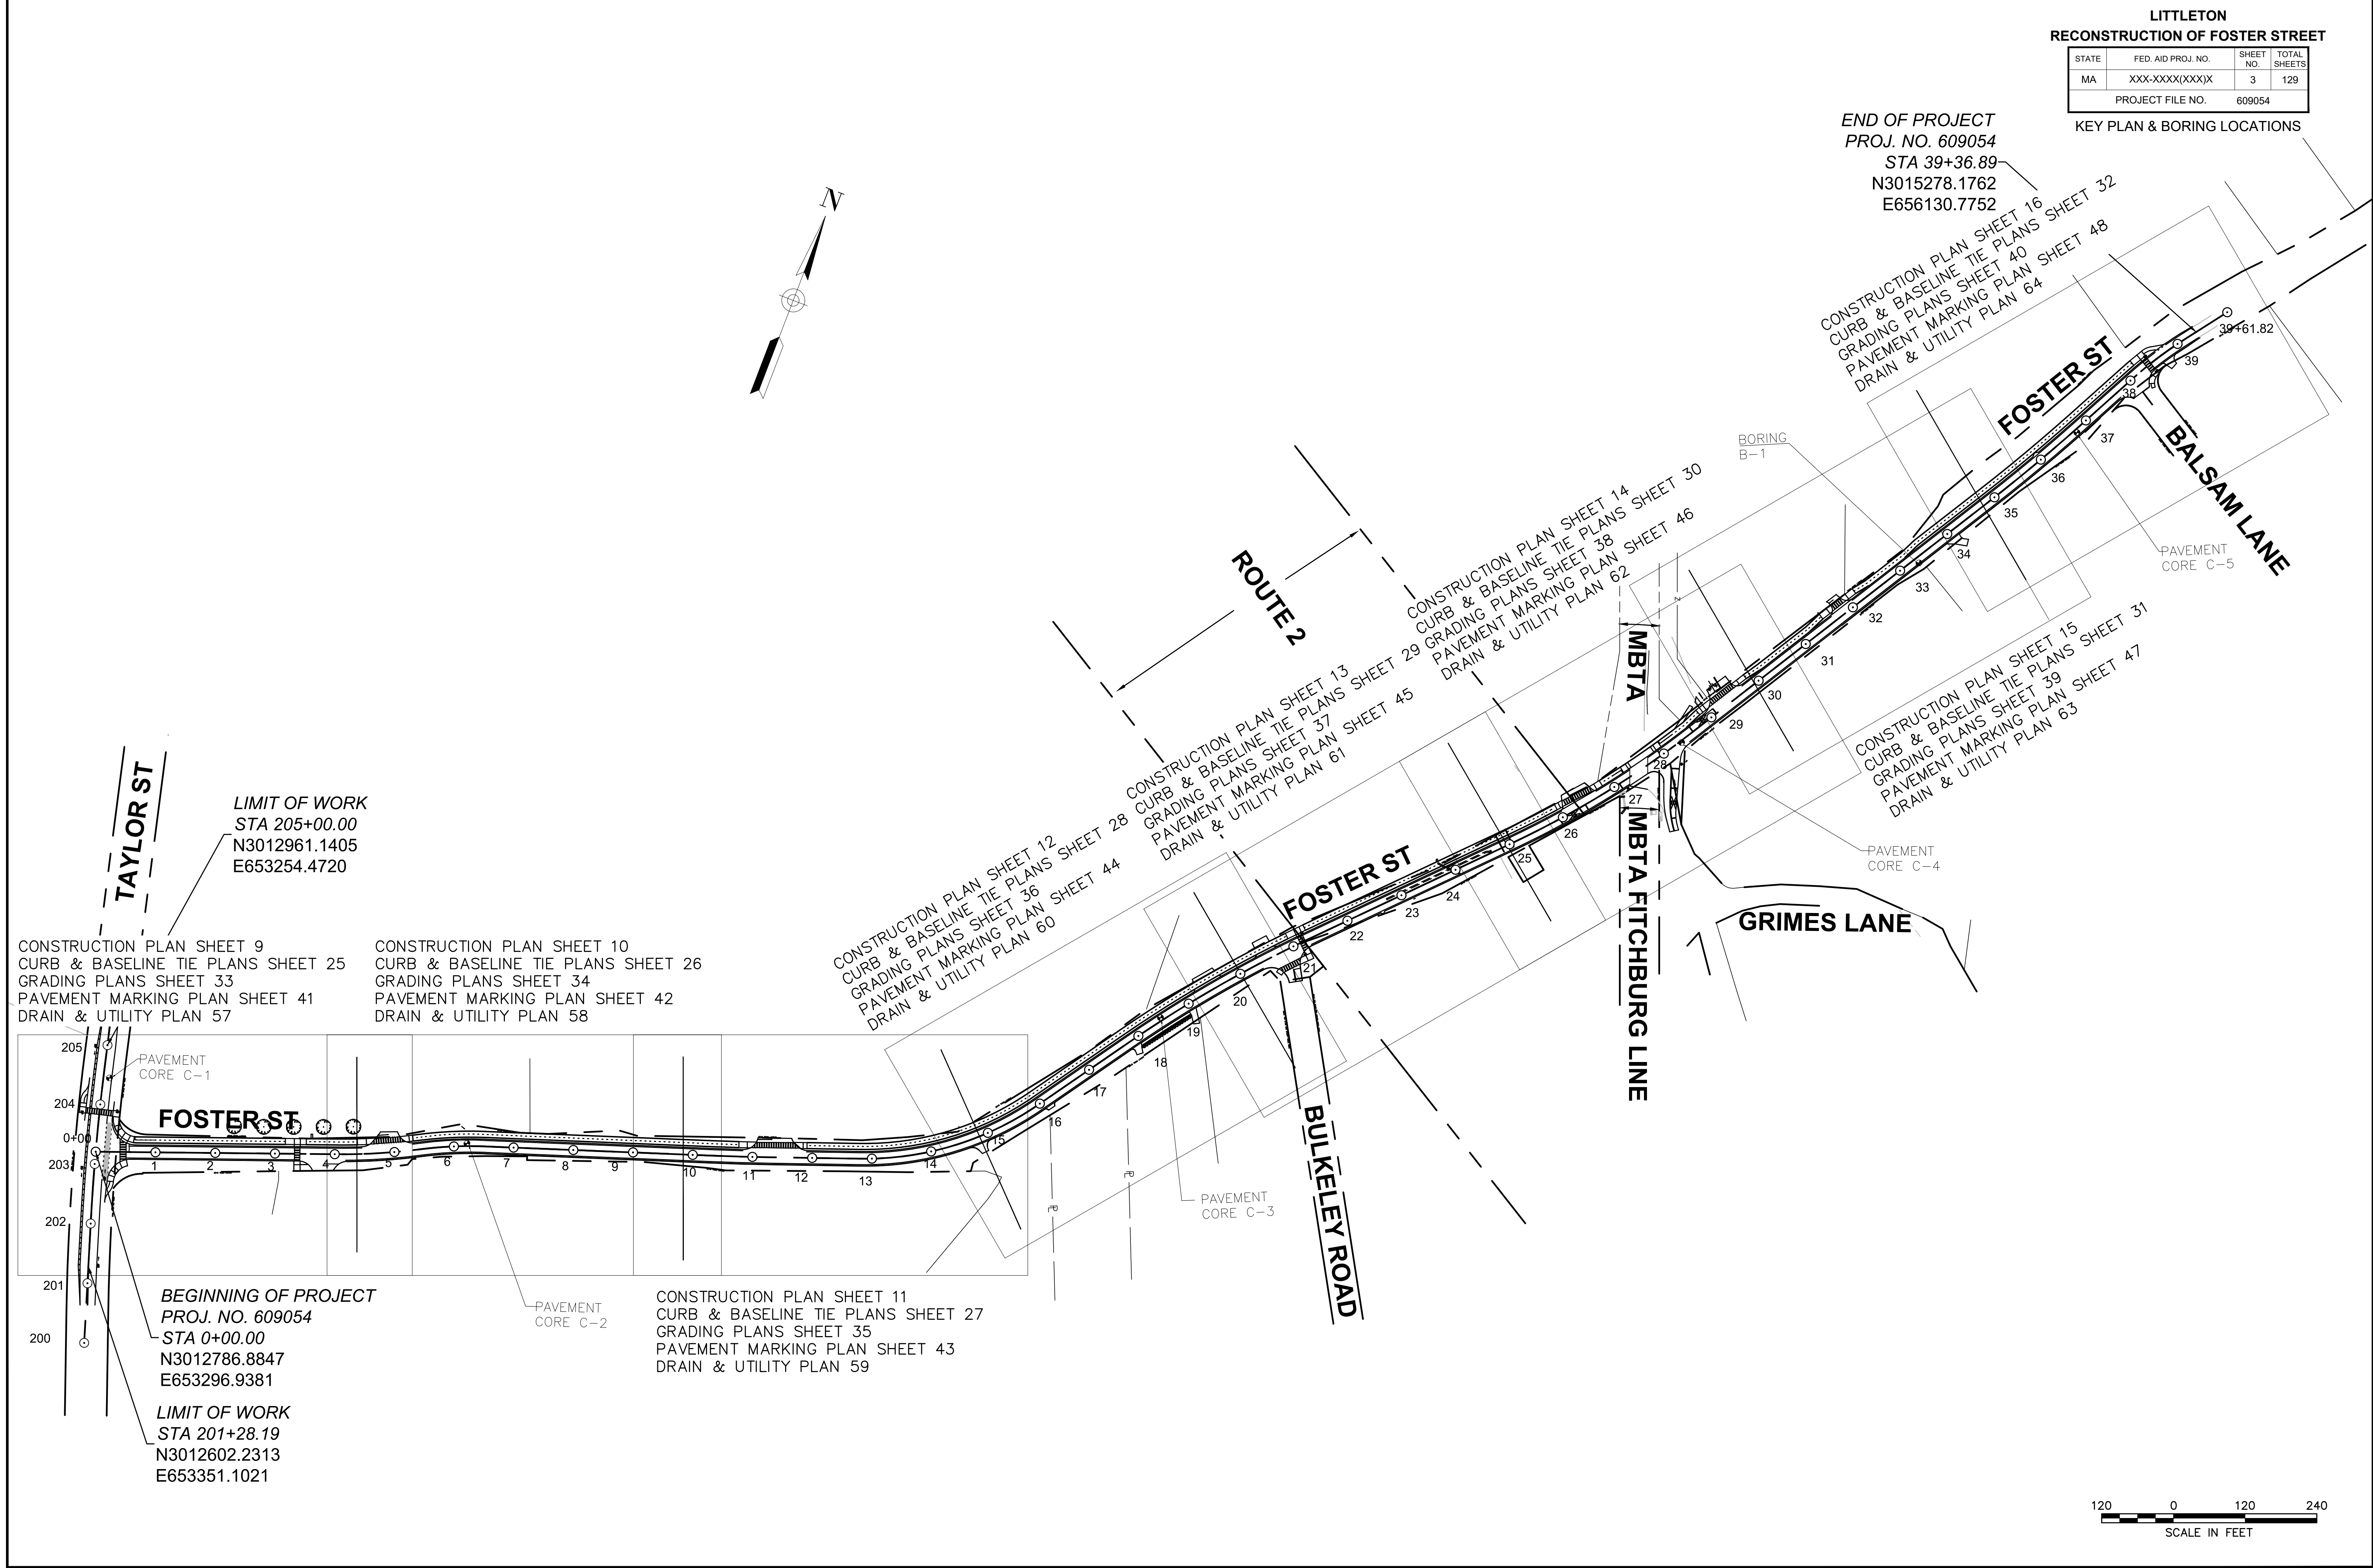

LITTLETON
RECONSTRUCTION OF FOSTER STREET

STATE	FED. AID PROJ. NO.	SHEET NO.	TOTAL SHEETS
MA	XXX-XXX(XXX)X	4	129
PROJECT FILE NO.			609054

TYPICAL SECTIONS - FOSTER ST

PAVEMENT NOTES:

PROPOSED PAVEMENT MILLING AND OVERLAY - FOSTER STREET

1-1/2" PAVEMENT FINE MILLING
1-1/2" SUPERPAVE SURFACE COURSE - 9.5
MILLING TO BE VARIABLE DEPTH (INCREASING) AT PROJECT LIMITS TO MEET EXISTING GRADE ON TAYLOR ST
MILLING TO BE VARIABLE DEPTH (DECREASING) AT SAWCUT TRANSITION ON FOSTER ST EAST OF BALSAM LN

PROPOSED FULL DEPTH PAVEMENT RECONSTRUCTION

SURFACE: 1-1/2" SUPERPAVE SURFACE COURSE - 9.5 (SSC - 9.5) OVER
INTERMEDIATE: 1-3/4" SUPERPAVE INTERMEDIATE COURSE - 12.5 OVER
BASE: 4" SUPERPAVE BASE COURSE - 37.5 OVER
SUBBASE: 4" DENSE GRADED CRUSHED STONE
8" GRAVEL BORROW, TYPE b

PROPOSED SHARED-USE PATH FULL DEPTH PAVEMENT

SURFACE: 1-1/2" SUPERPAVE SURFACE COURSE - 9.5 (SSC - 9.5) OVER
INTERMEDIATE: 2-1/2" SUPERPAVE INTERMEDIATE COURSE- 19.0 OVER
SUBBASE: 8" GRAVEL BORROW, TYPE b

PROPOSED HOT MIX ASPHALT SIDEWALK OR DRIVEWAY

SURFACE: 1-1/2" SUPERPAVE SURFACE COURSE - 9.5 (SSC - 9.5) OVER
2-1/2" SUPERPAVE INTERMEDIATE COURSE - 12.5 (SIC - 12.5)
FOUNDATION: 8" GRAVEL BORROW, TYPE b.

PROPOSED CEMENT CONCRETE SIDEWALK

SURFACE: 4" CEMENT CONCRETE
AIR ENTRAINED 4000psi, 3/4", 610
FOUNDATION: 8" GRAVEL BORROW, TYPE b.



PROPOSED CEMENT CONCRETE PEDESTRIAN CURB RAMP

SURFACE: 6" CEMENT CONCRETE
AIR ENTRAINED 4000psi, 3/4", 610
FOUNDATION: 8" GRAVEL BORROW, TYPE b.

NOTES: ASPHALT EMULSION FOR TACK COAT AND HMA JOINT SEALANT SHALL BE APPLIED PER SECTION 450 QA OF THE SPECIAL PROVISIONS.

HMA FOR PATCHING SHALL BE USED FOR ALL PERMANENT, PARTIAL, AND FULL DEPTH PAVEMENT REPAIRS OF UNSOUND PAVEMENT PER SECTION 450 IN AREAS OUTSIDE OF PROPOSED FULL DEPTH RECLAMATION OR RECONSTRUCTION ROADWAY AREAS.


HMA FOR MISCELLANEOUS WORK SHALL BE USED FOR ALL TEMPORARY CONSTRUCTION, TAPER RAMPS, CURB CUT RAMPS, TEMPORARY TRENCH REPAIR, ETC.

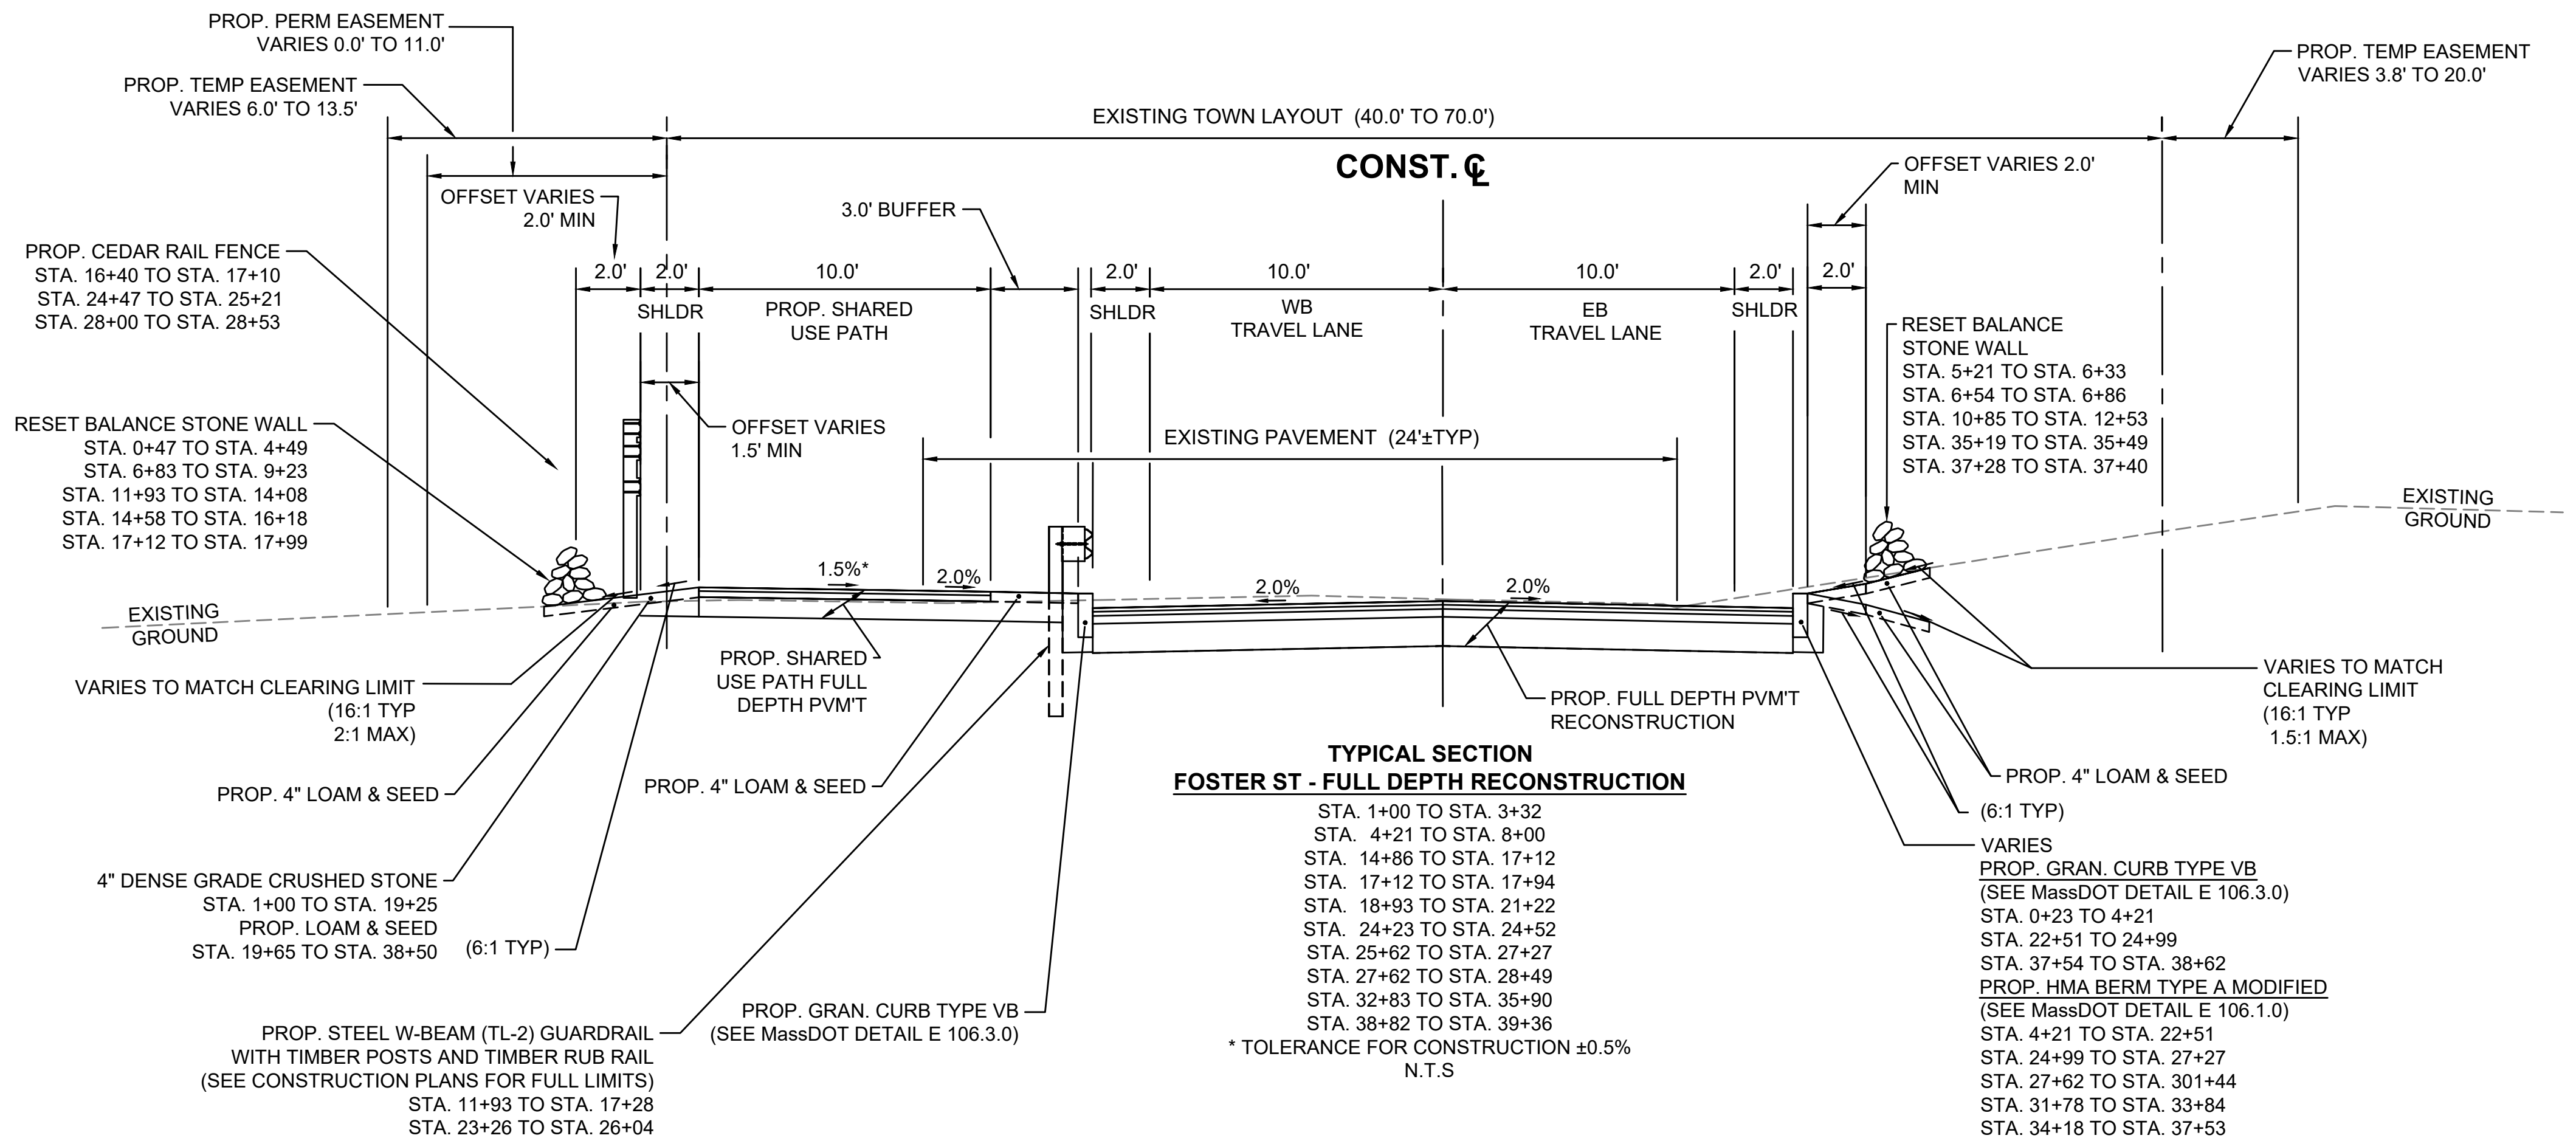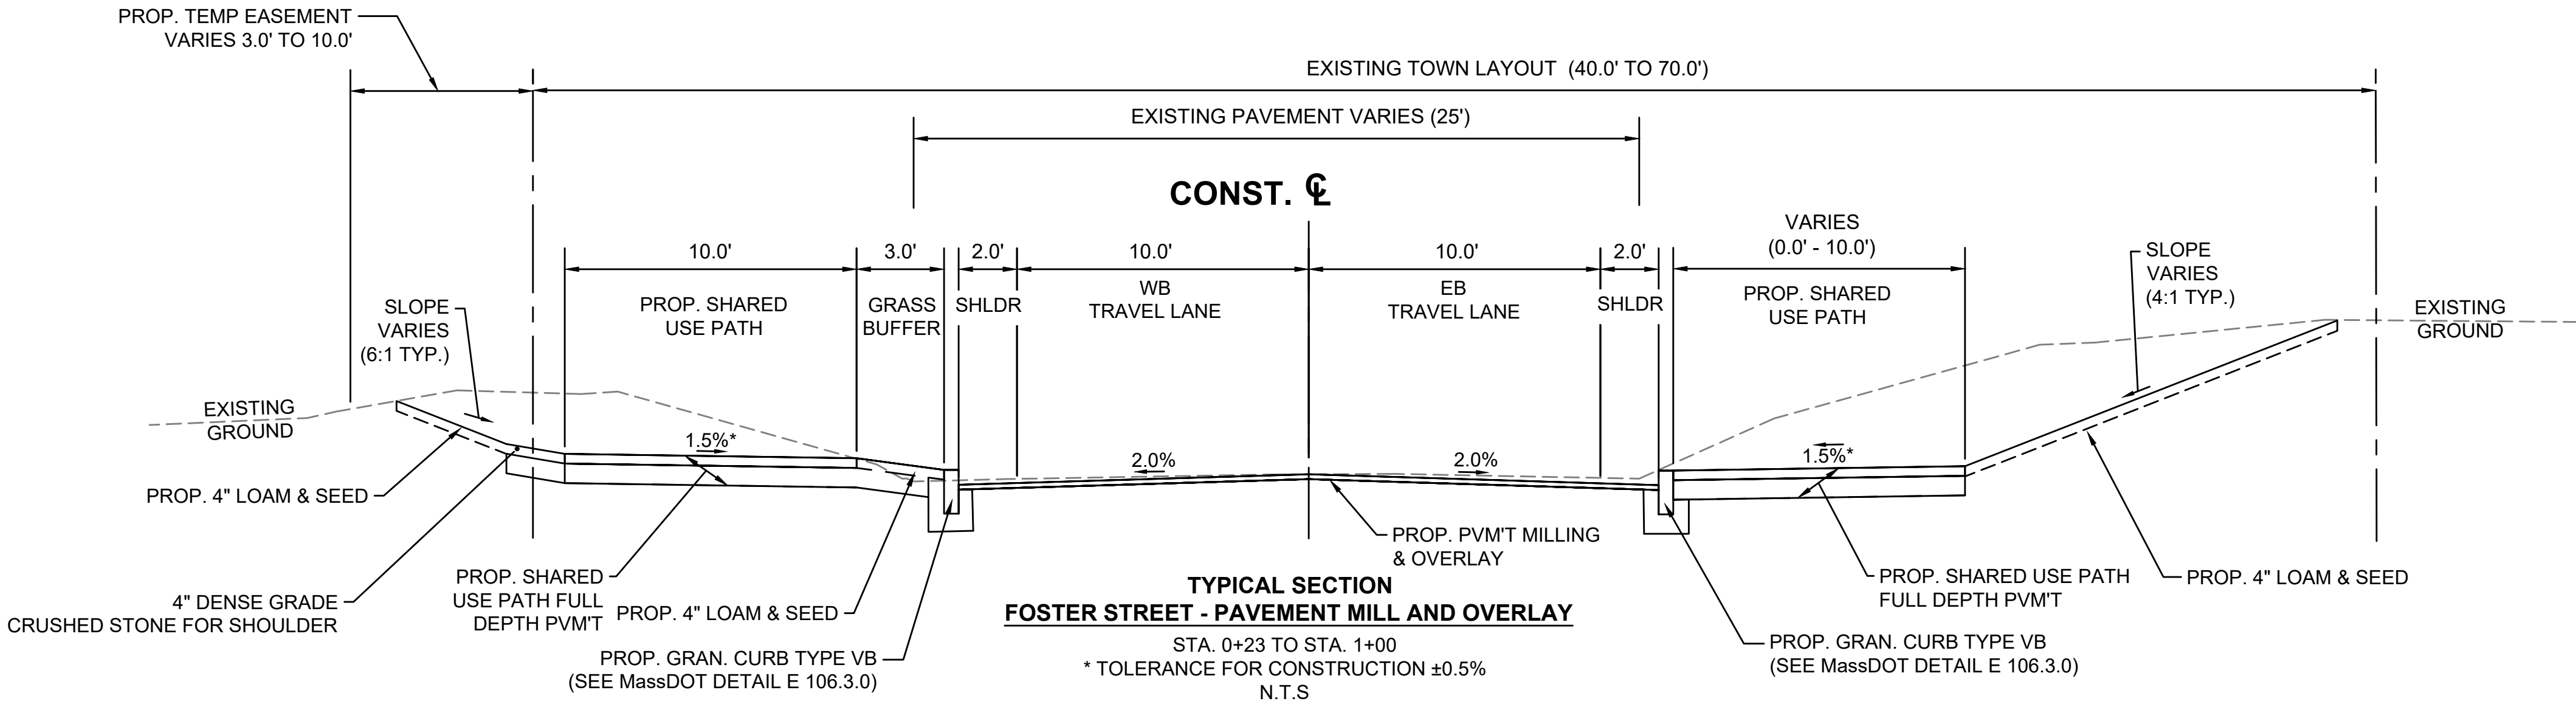

LITTLETON
RECONSTRUCTION OF FOSTER STREET

STATE	FED. AID PROJ. NO.	SHEET NO.	TOTAL SHEETS
MA	XXX-XXXX(XXX)X	5	129
PROJECT FILE NO.		609054	


TYPICAL SECTIONS - FOSTER ST

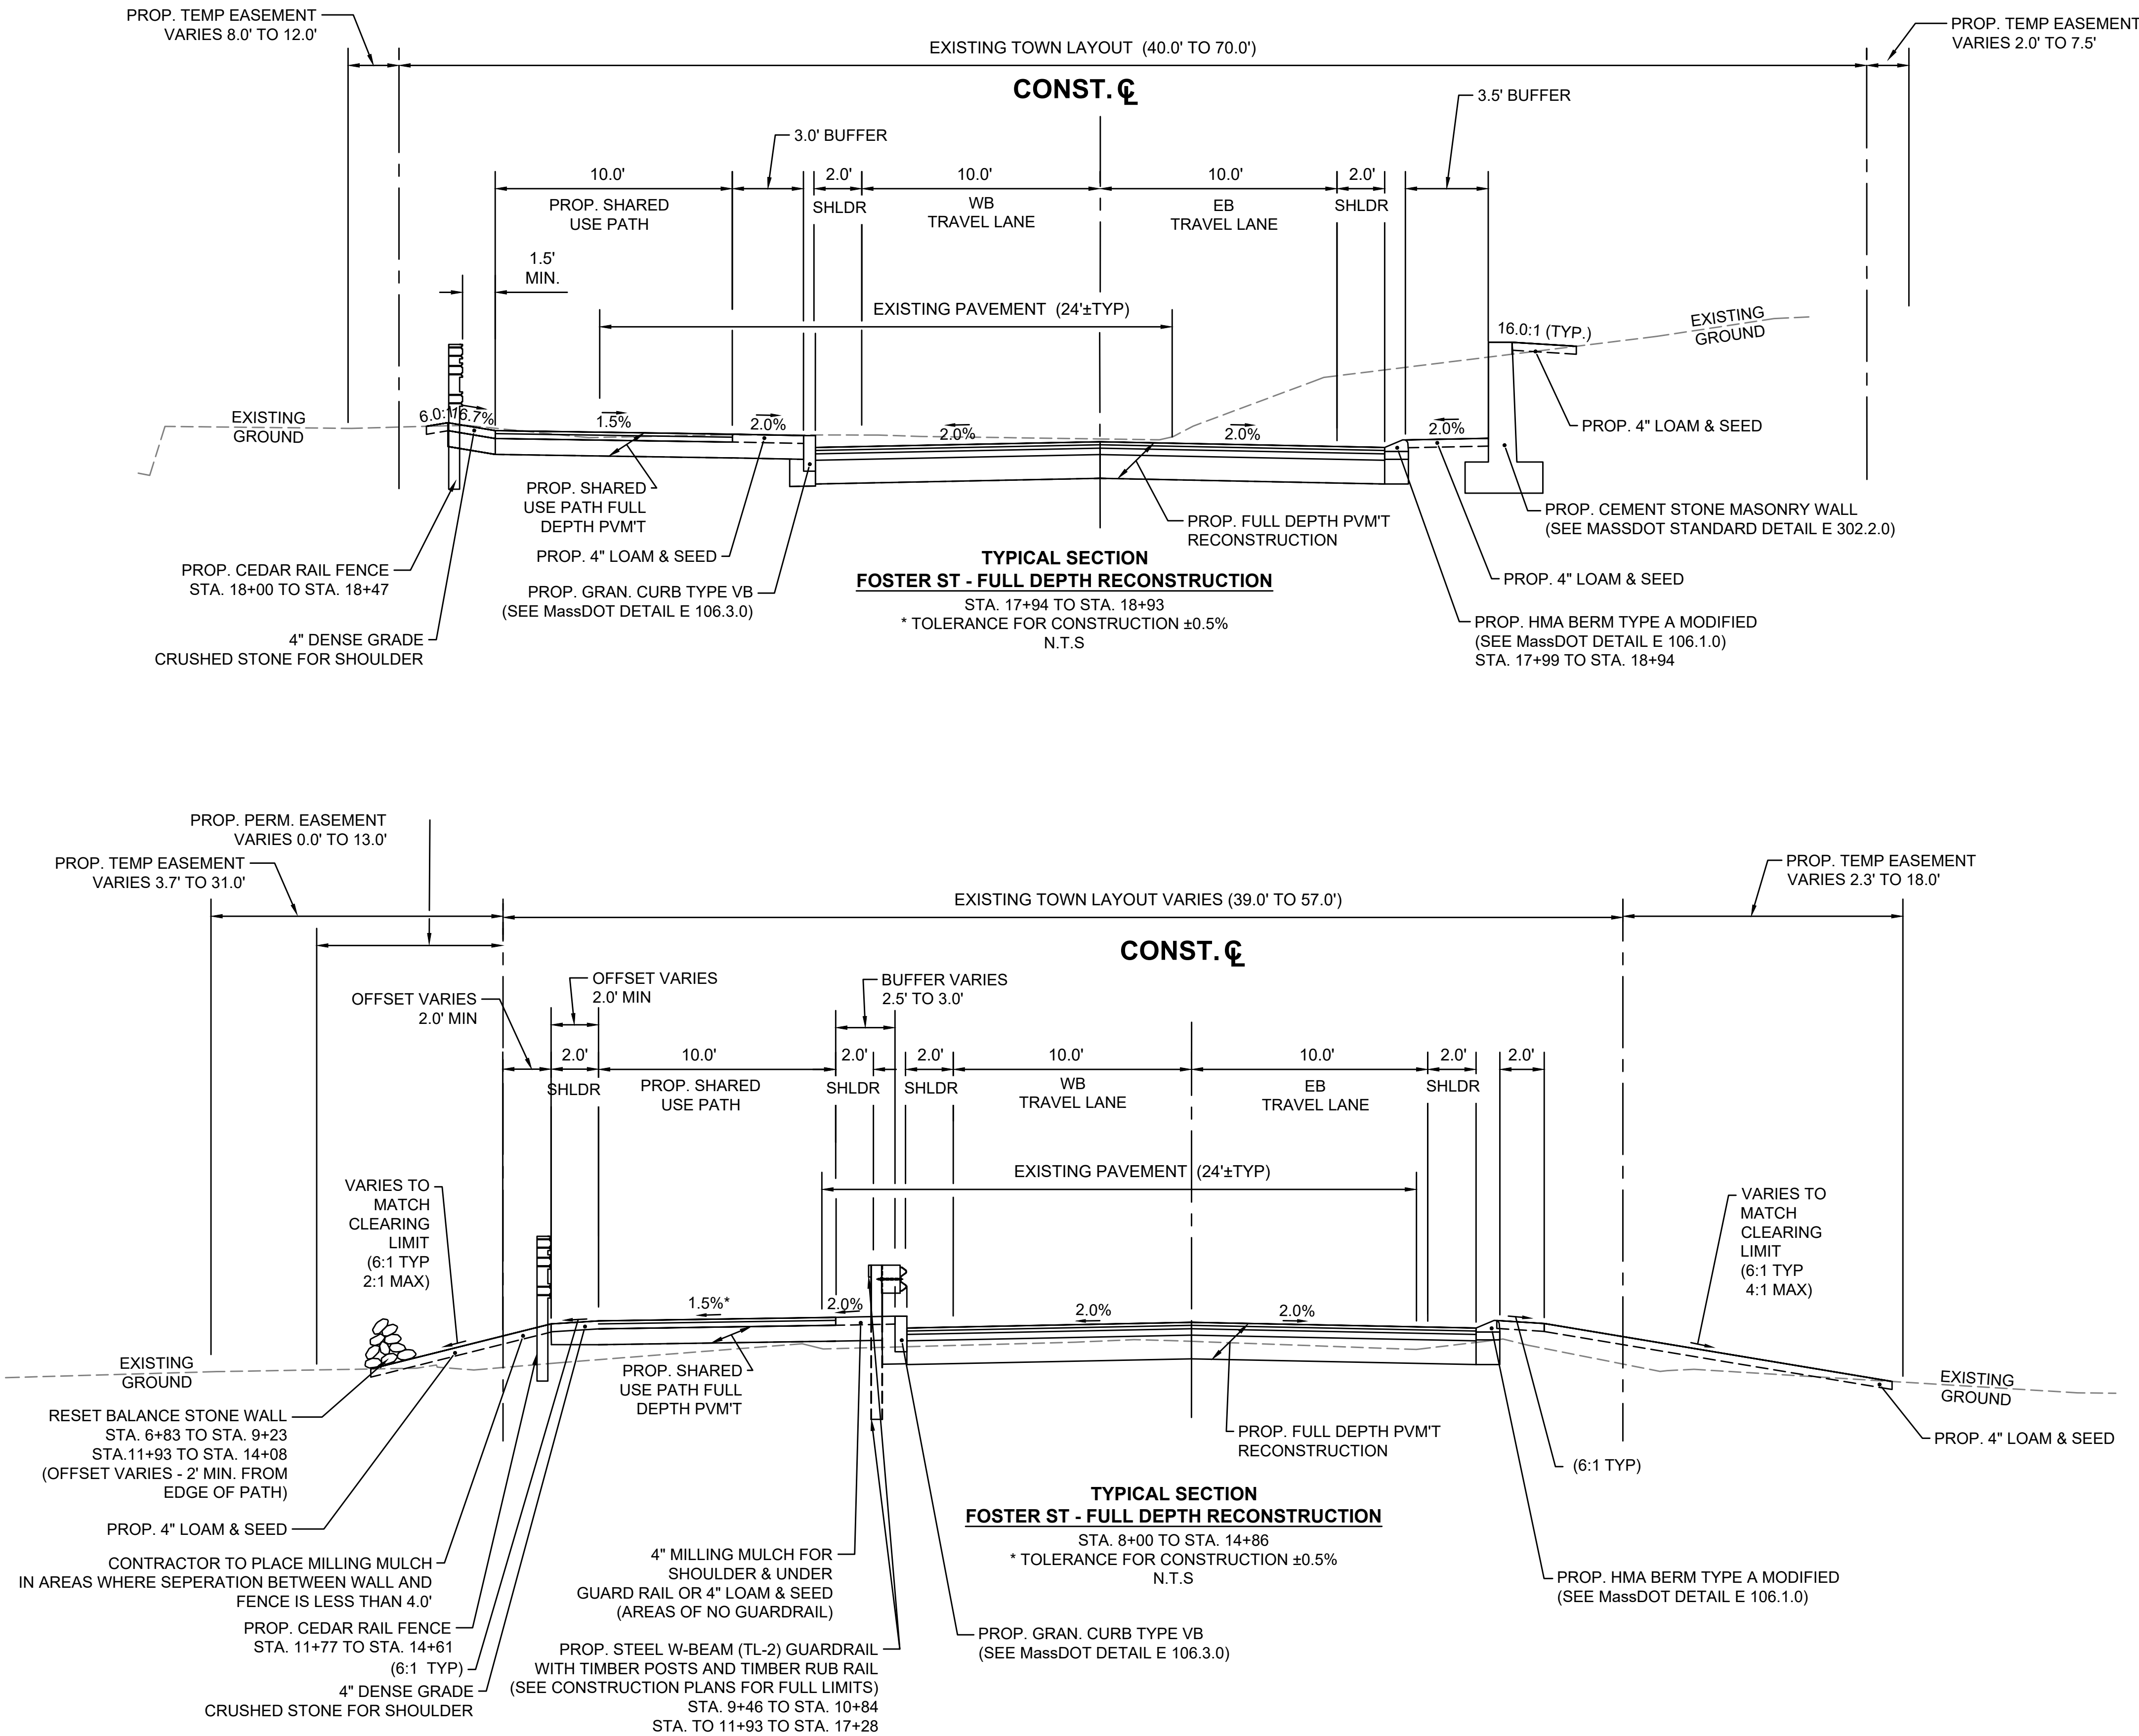

LITTLETON
RECONSTRUCTION OF FOSTER STREET

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MA	XXX-XXXX(XXX)X	6	129
PROJECT FILE NO.		609054	


TYPICAL SECTIONS - FOSTER ST

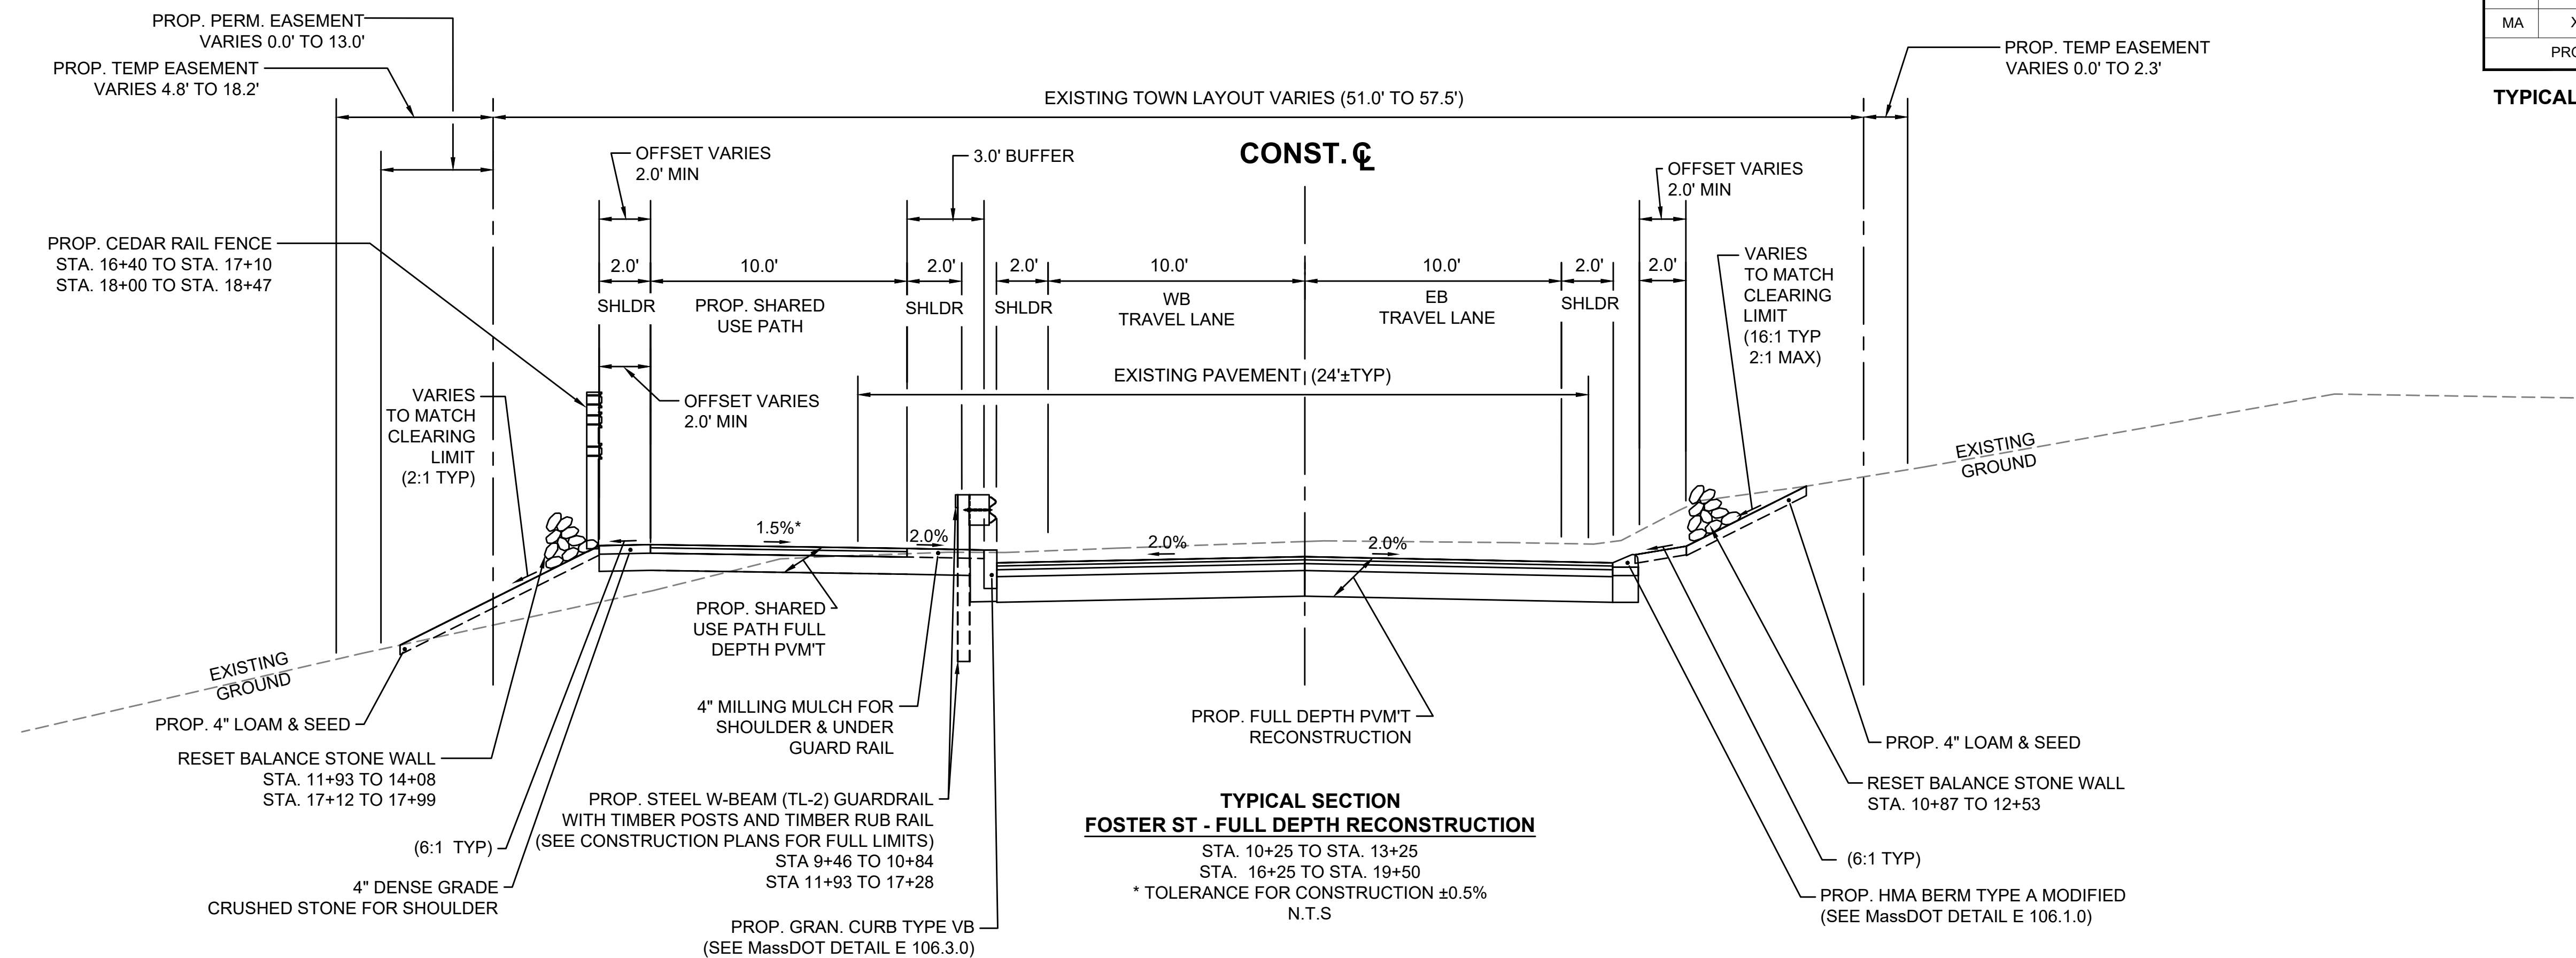

TYPICAL SECTION
FOSTER ST - FULL DEPTH RECONSTRUCTION

STA. 10+25 TO STA. 13+25
STA. 16+25 TO STA. 19+50

* TOLERANCE FOR CONSTRUCTION ±0.5%
N.T.S

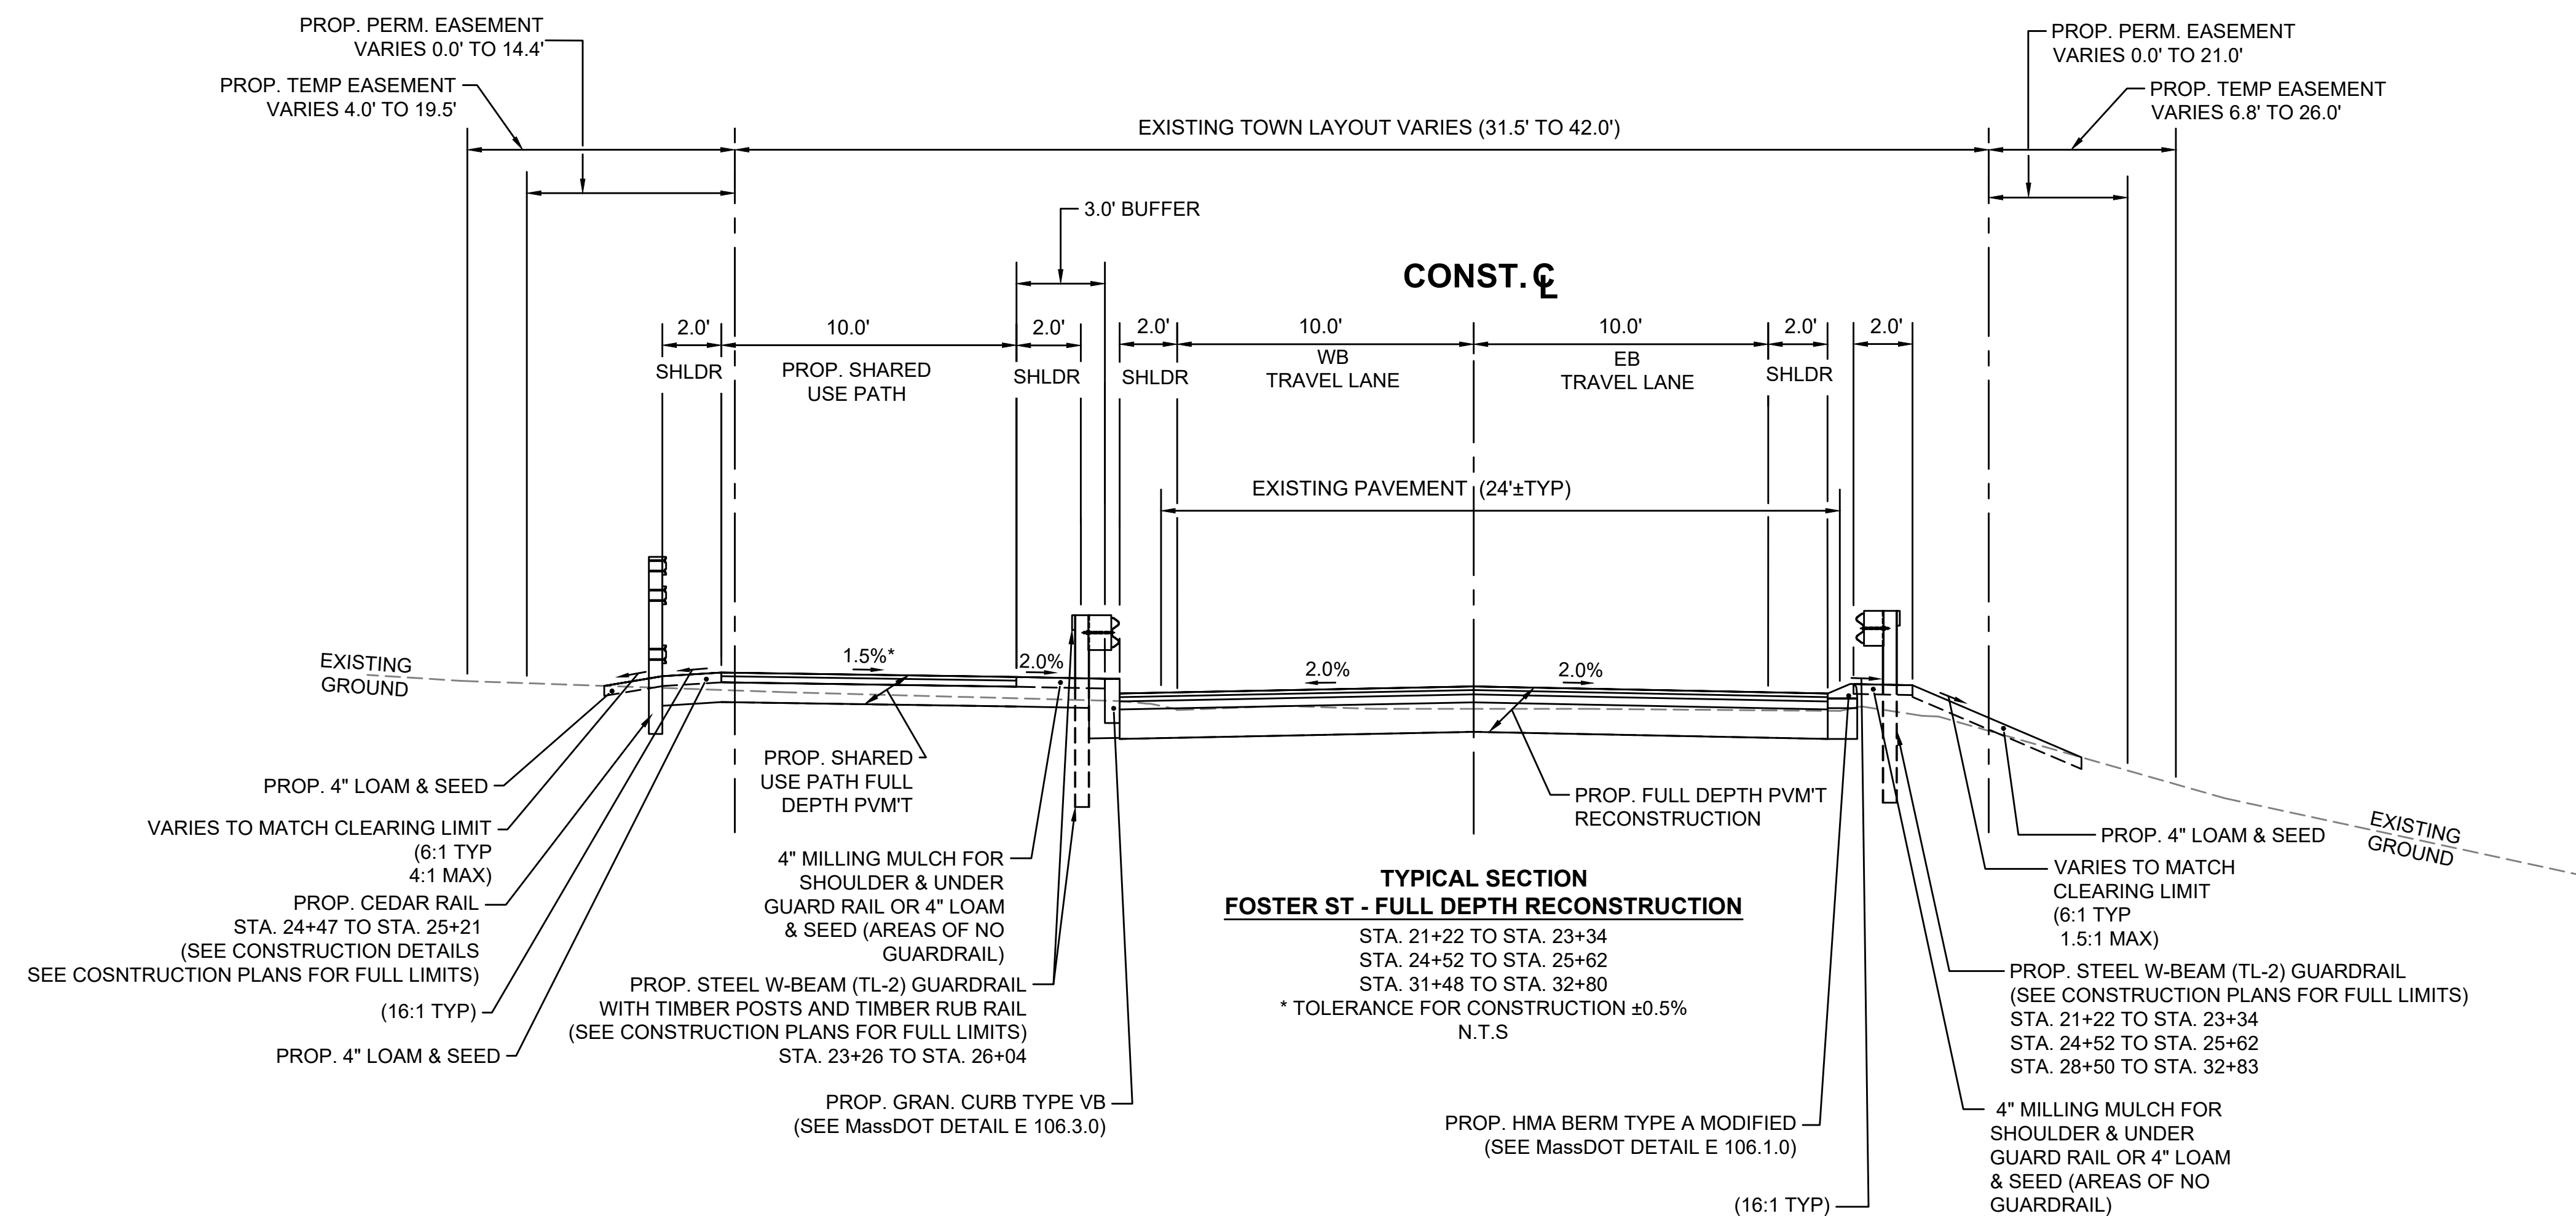

TYPICAL SECTION
FOSTER ST - FULL DEPTH RECONSTRUCTION


STA. 21+22 TO STA. 23+34
STA. 24+52 TO STA. 25+62
STA. 31+48 TO STA. 32+80

* TOLERANCE FOR CONSTRUCTION ±0.5%
N.T.S

LITTLETON
RECONSTRUCTION OF FOSTER STREET

STATE	FED. AID PROJ. NO.	SHEET NO.	TOTAL SHEETS
MA	XXX-XXXX(XXX)X	7	129
PROJECT FILE NO.			609054


TYPICAL SECTIONS - FOSTER ST

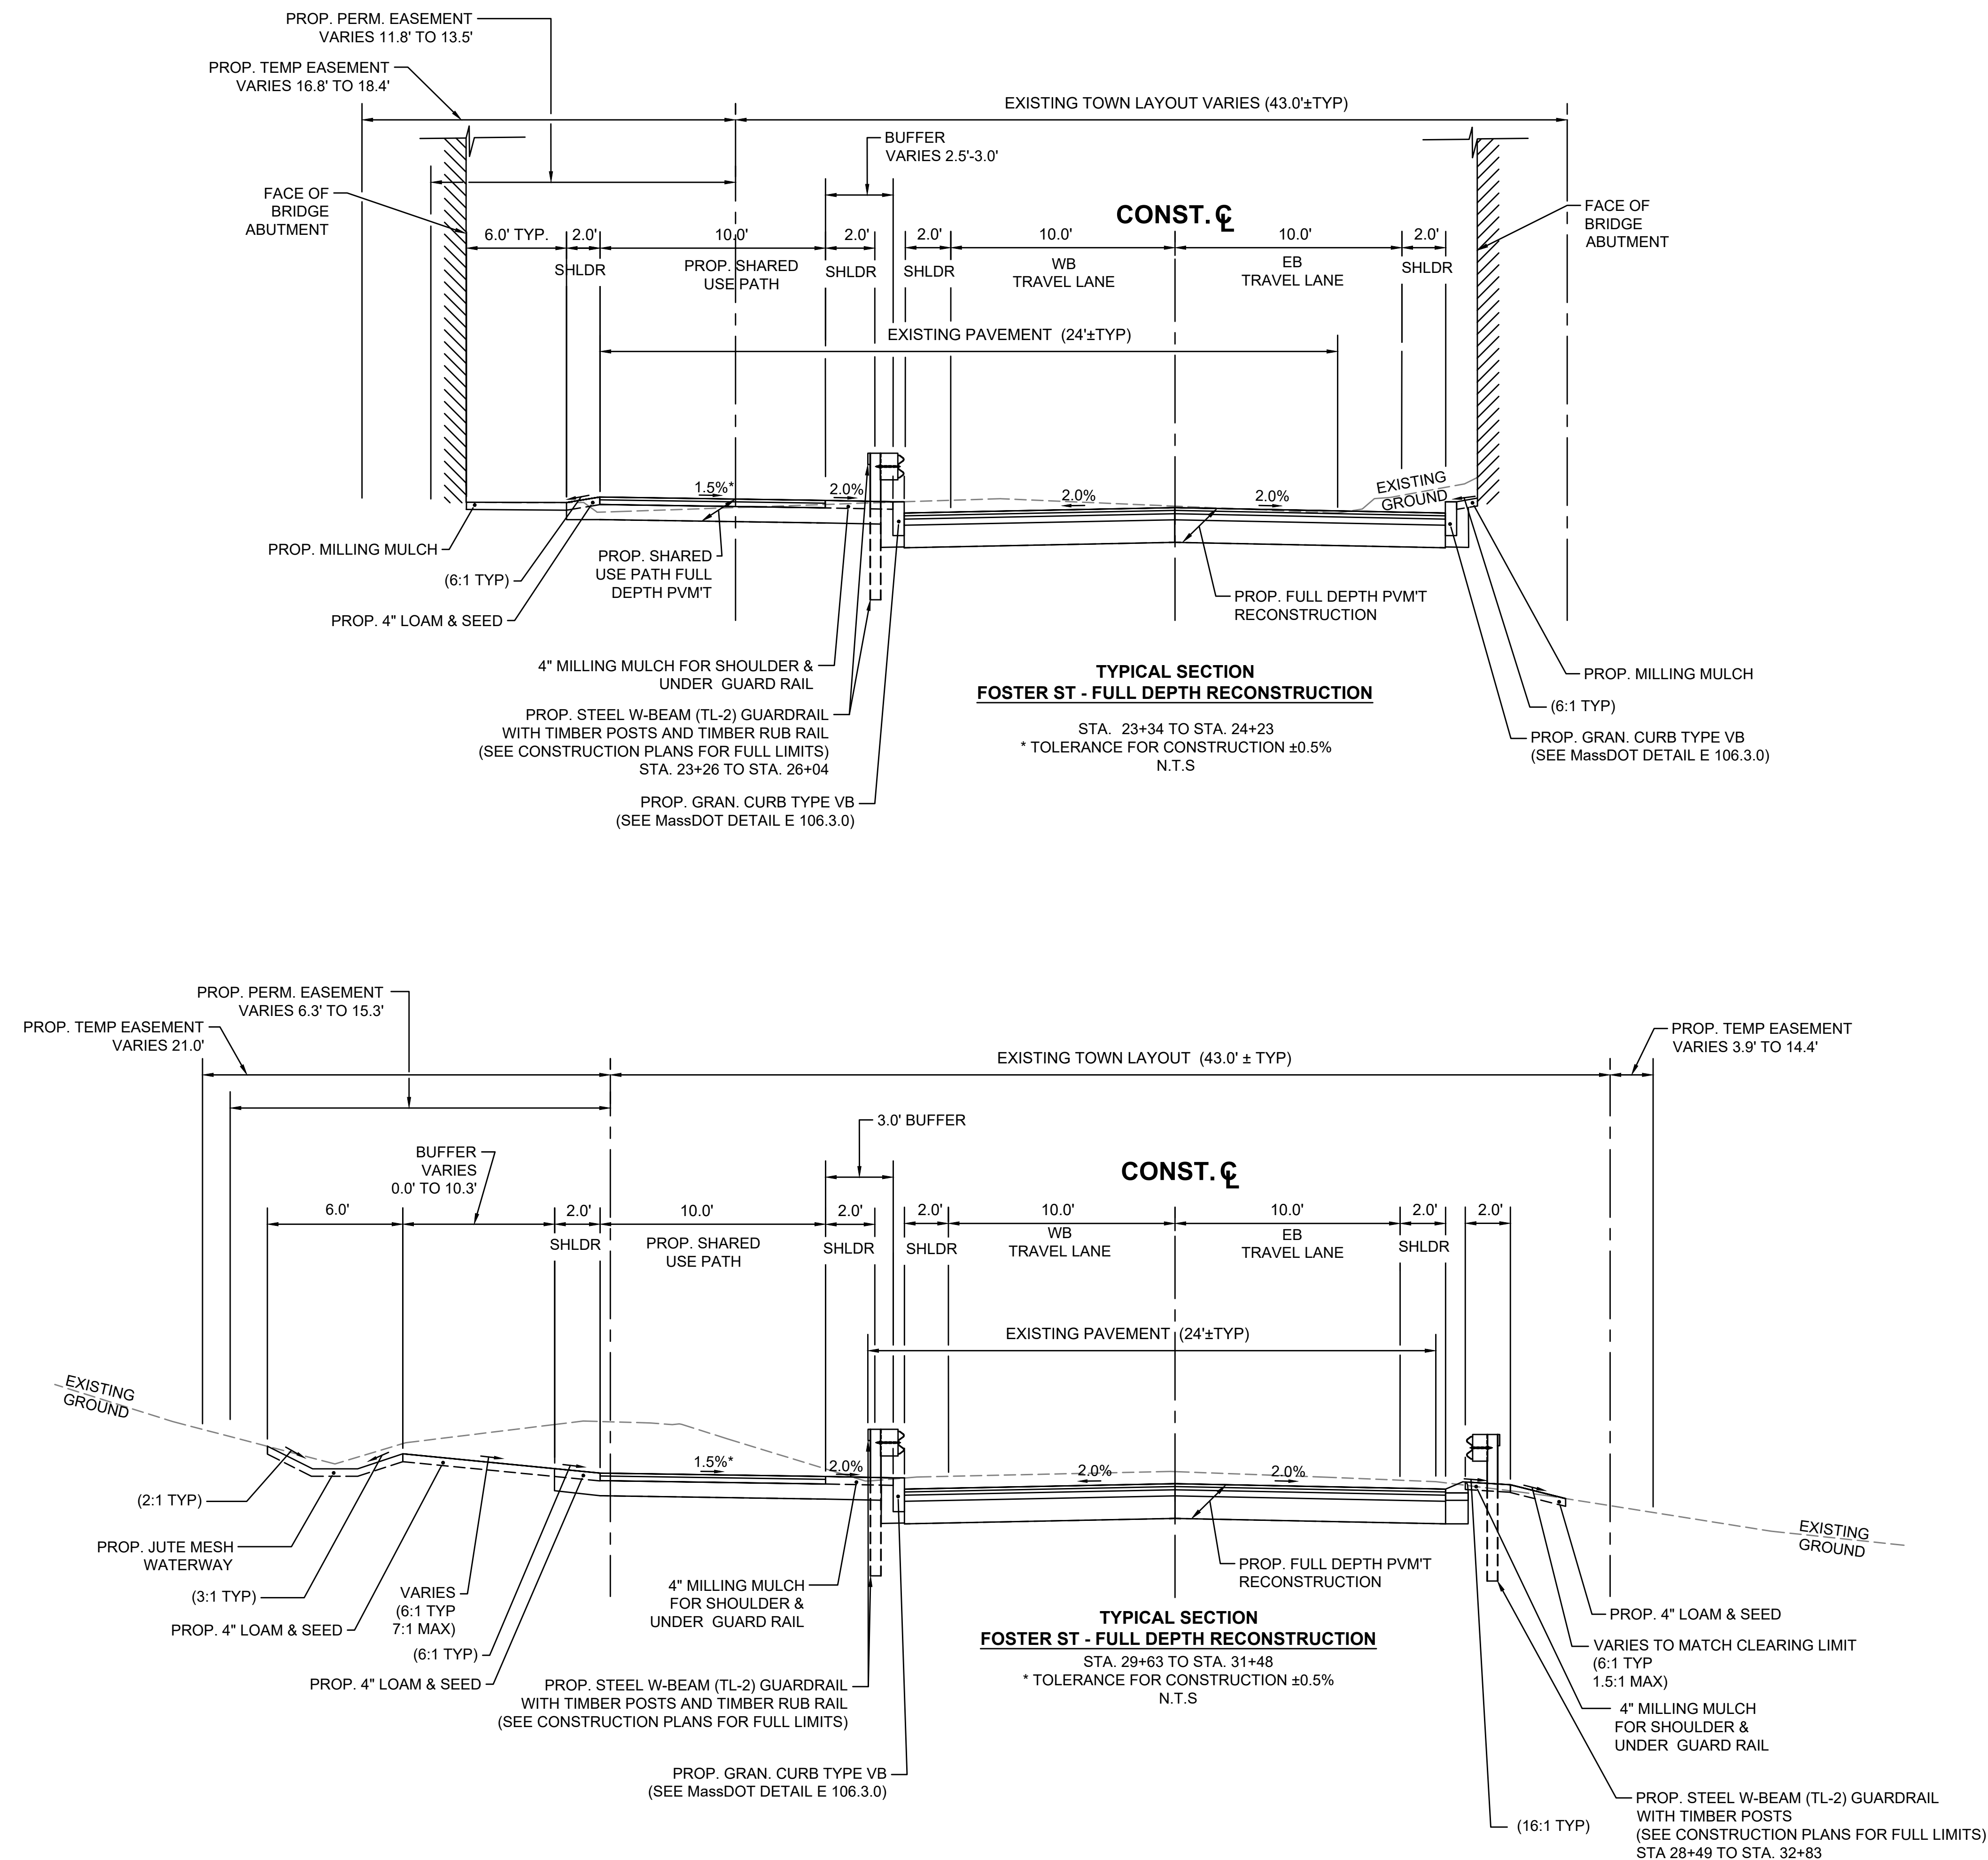


LITTLETON
RECONSTRUCTION OF FOSTER STREET

STATE	FED. AID PROJ. NO.	SHEET NO.	TOTAL SHEETS
MA	XXX-XXXX(XXX)X	8	129
PROJECT FILE NO.		609054	


TYPICAL SECTIONS - FOSTER ST

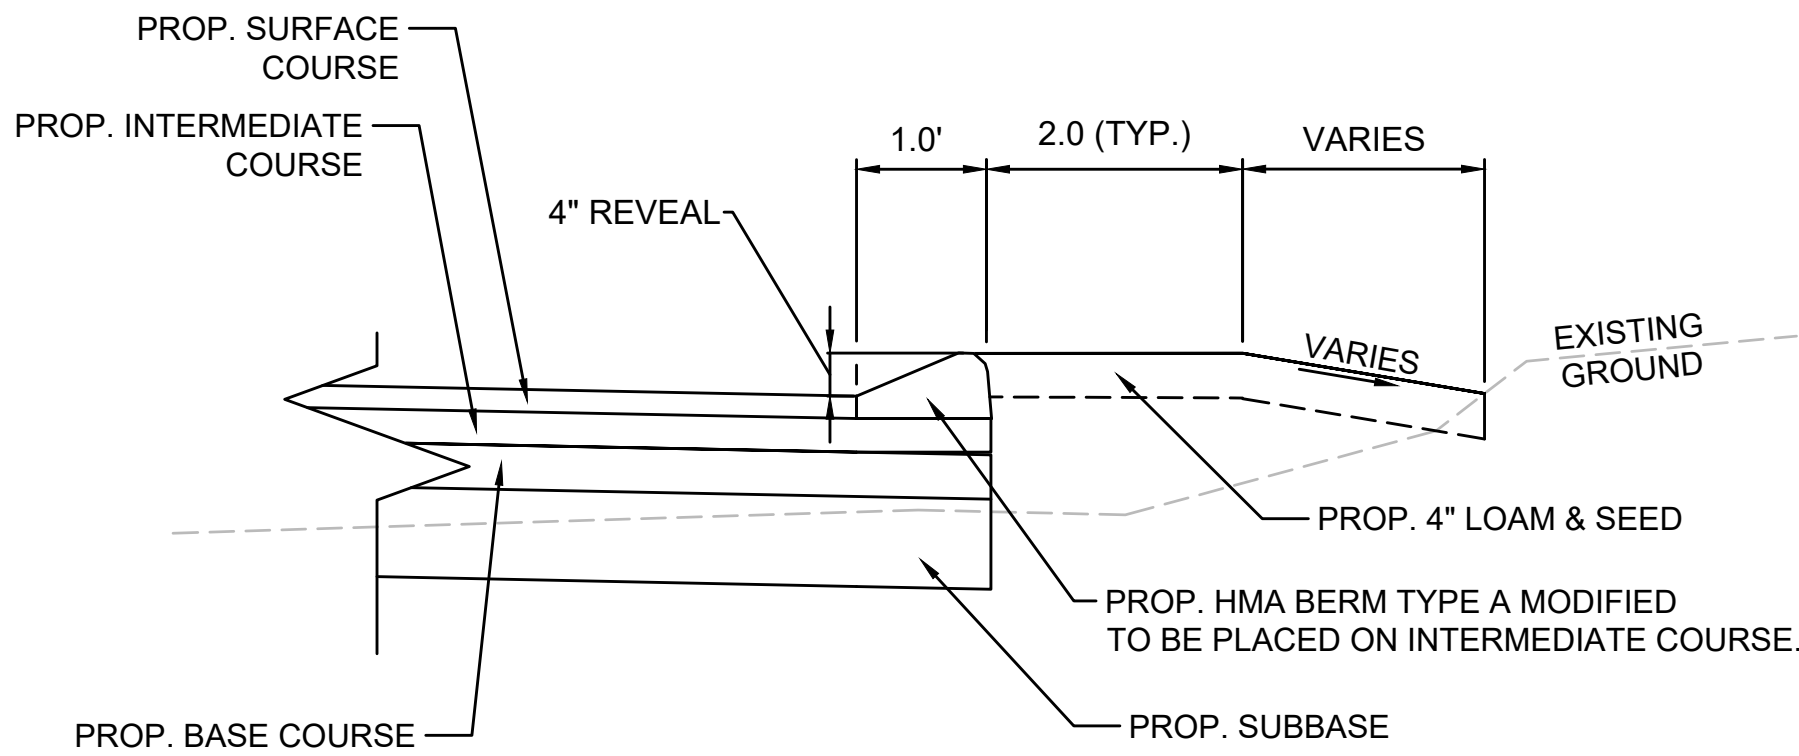


PROP. HMA BERM TYPE A MODIFIED PLACEMENT
SCALE: NTS

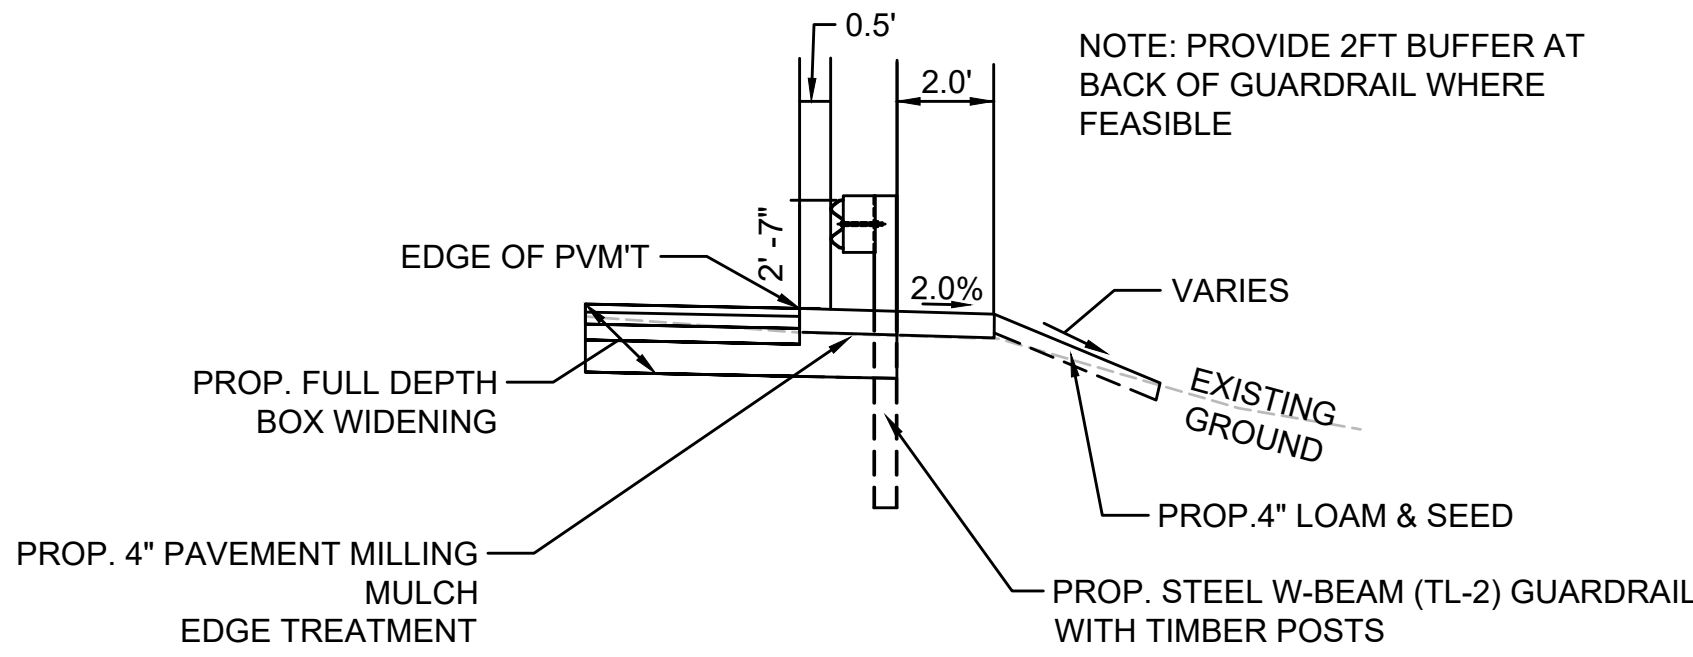


TYPICAL GUARDRAIL PLACEMENT
SCALE: NTS

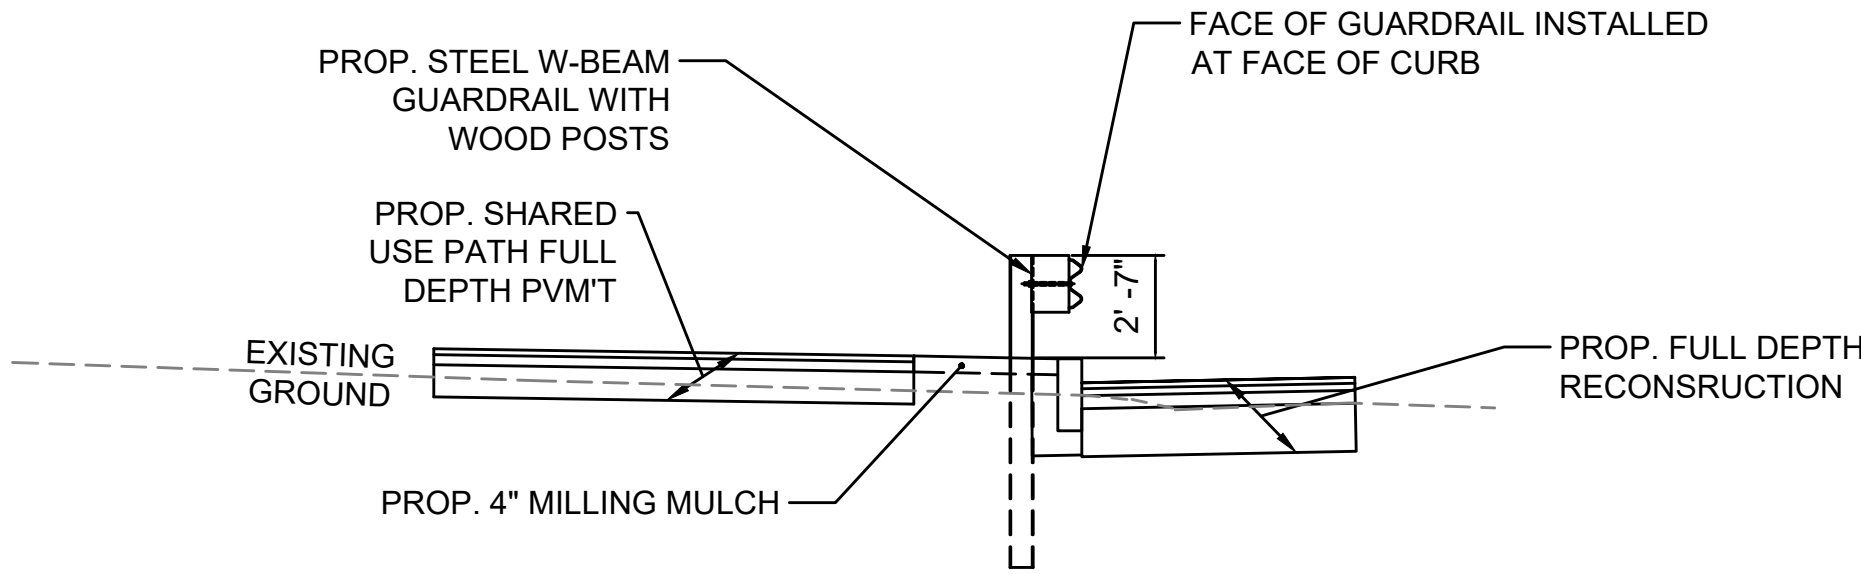

TYPICAL GAURDRAIL PLACEMENT AT GRANITE CURB TYPE VB
SCALE: NTS

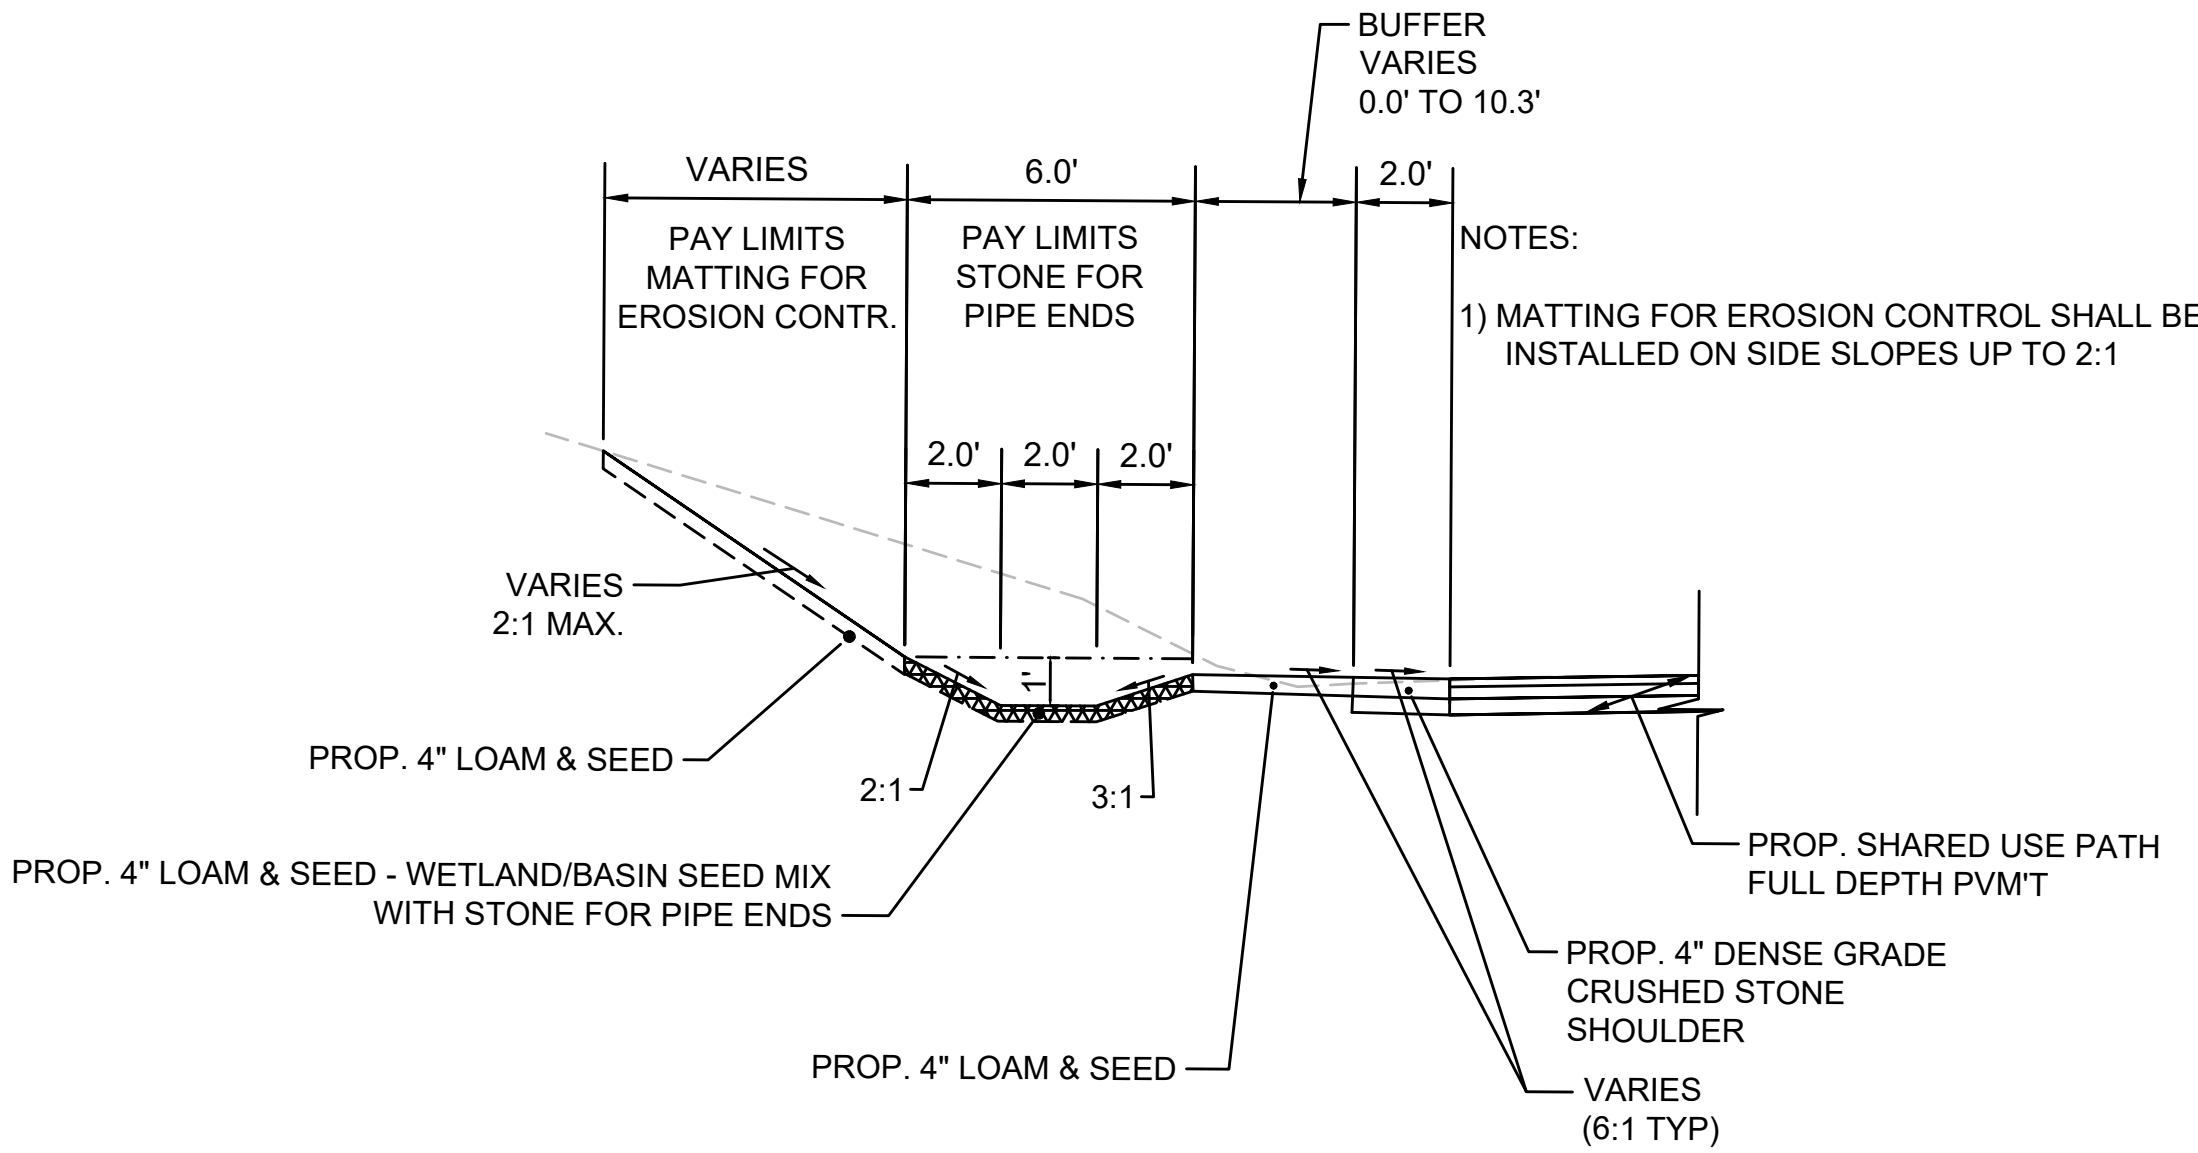

GRASS SWALE WITH MODIFIED ROCK FILL
SCALE: NTS

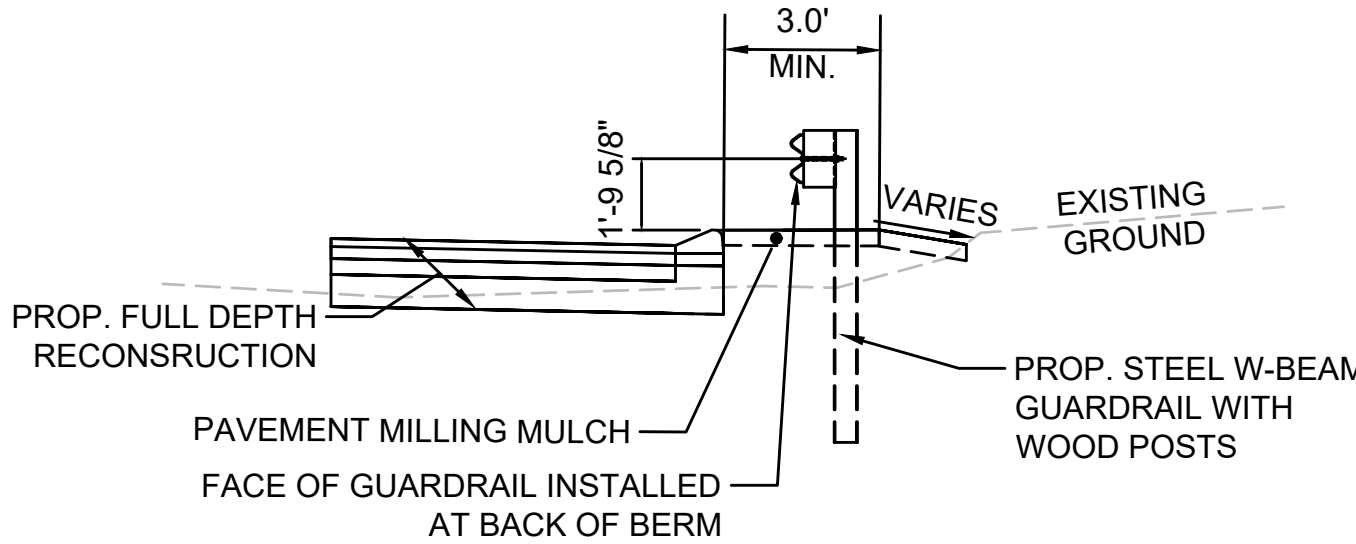

TYPICAL GAURDRAIL PLACEMENT AT HMA BERM TYPE A MODIFIED
SCALE: NTS

STEEL W-BEAM GUARDRAIL (TL-2) W/ WOOD POST & TANGENT END STA. 9+46 LT
TO TANGENT END STA 10+84 LT

NONE

SEE SHEET 57-64


SEE SHEET NOS. 65-67

X#

DR#

STATE	FED. AID PROJ. NO.	SHEET NO.	TOTAL SHEETS
MA	XXX-XXXX(XXX)X	10	129
PROJECT FILE NO.		609054	

20170044A21_HPN01.DWG Plotted on 19-Apr-2023 1:48 AM

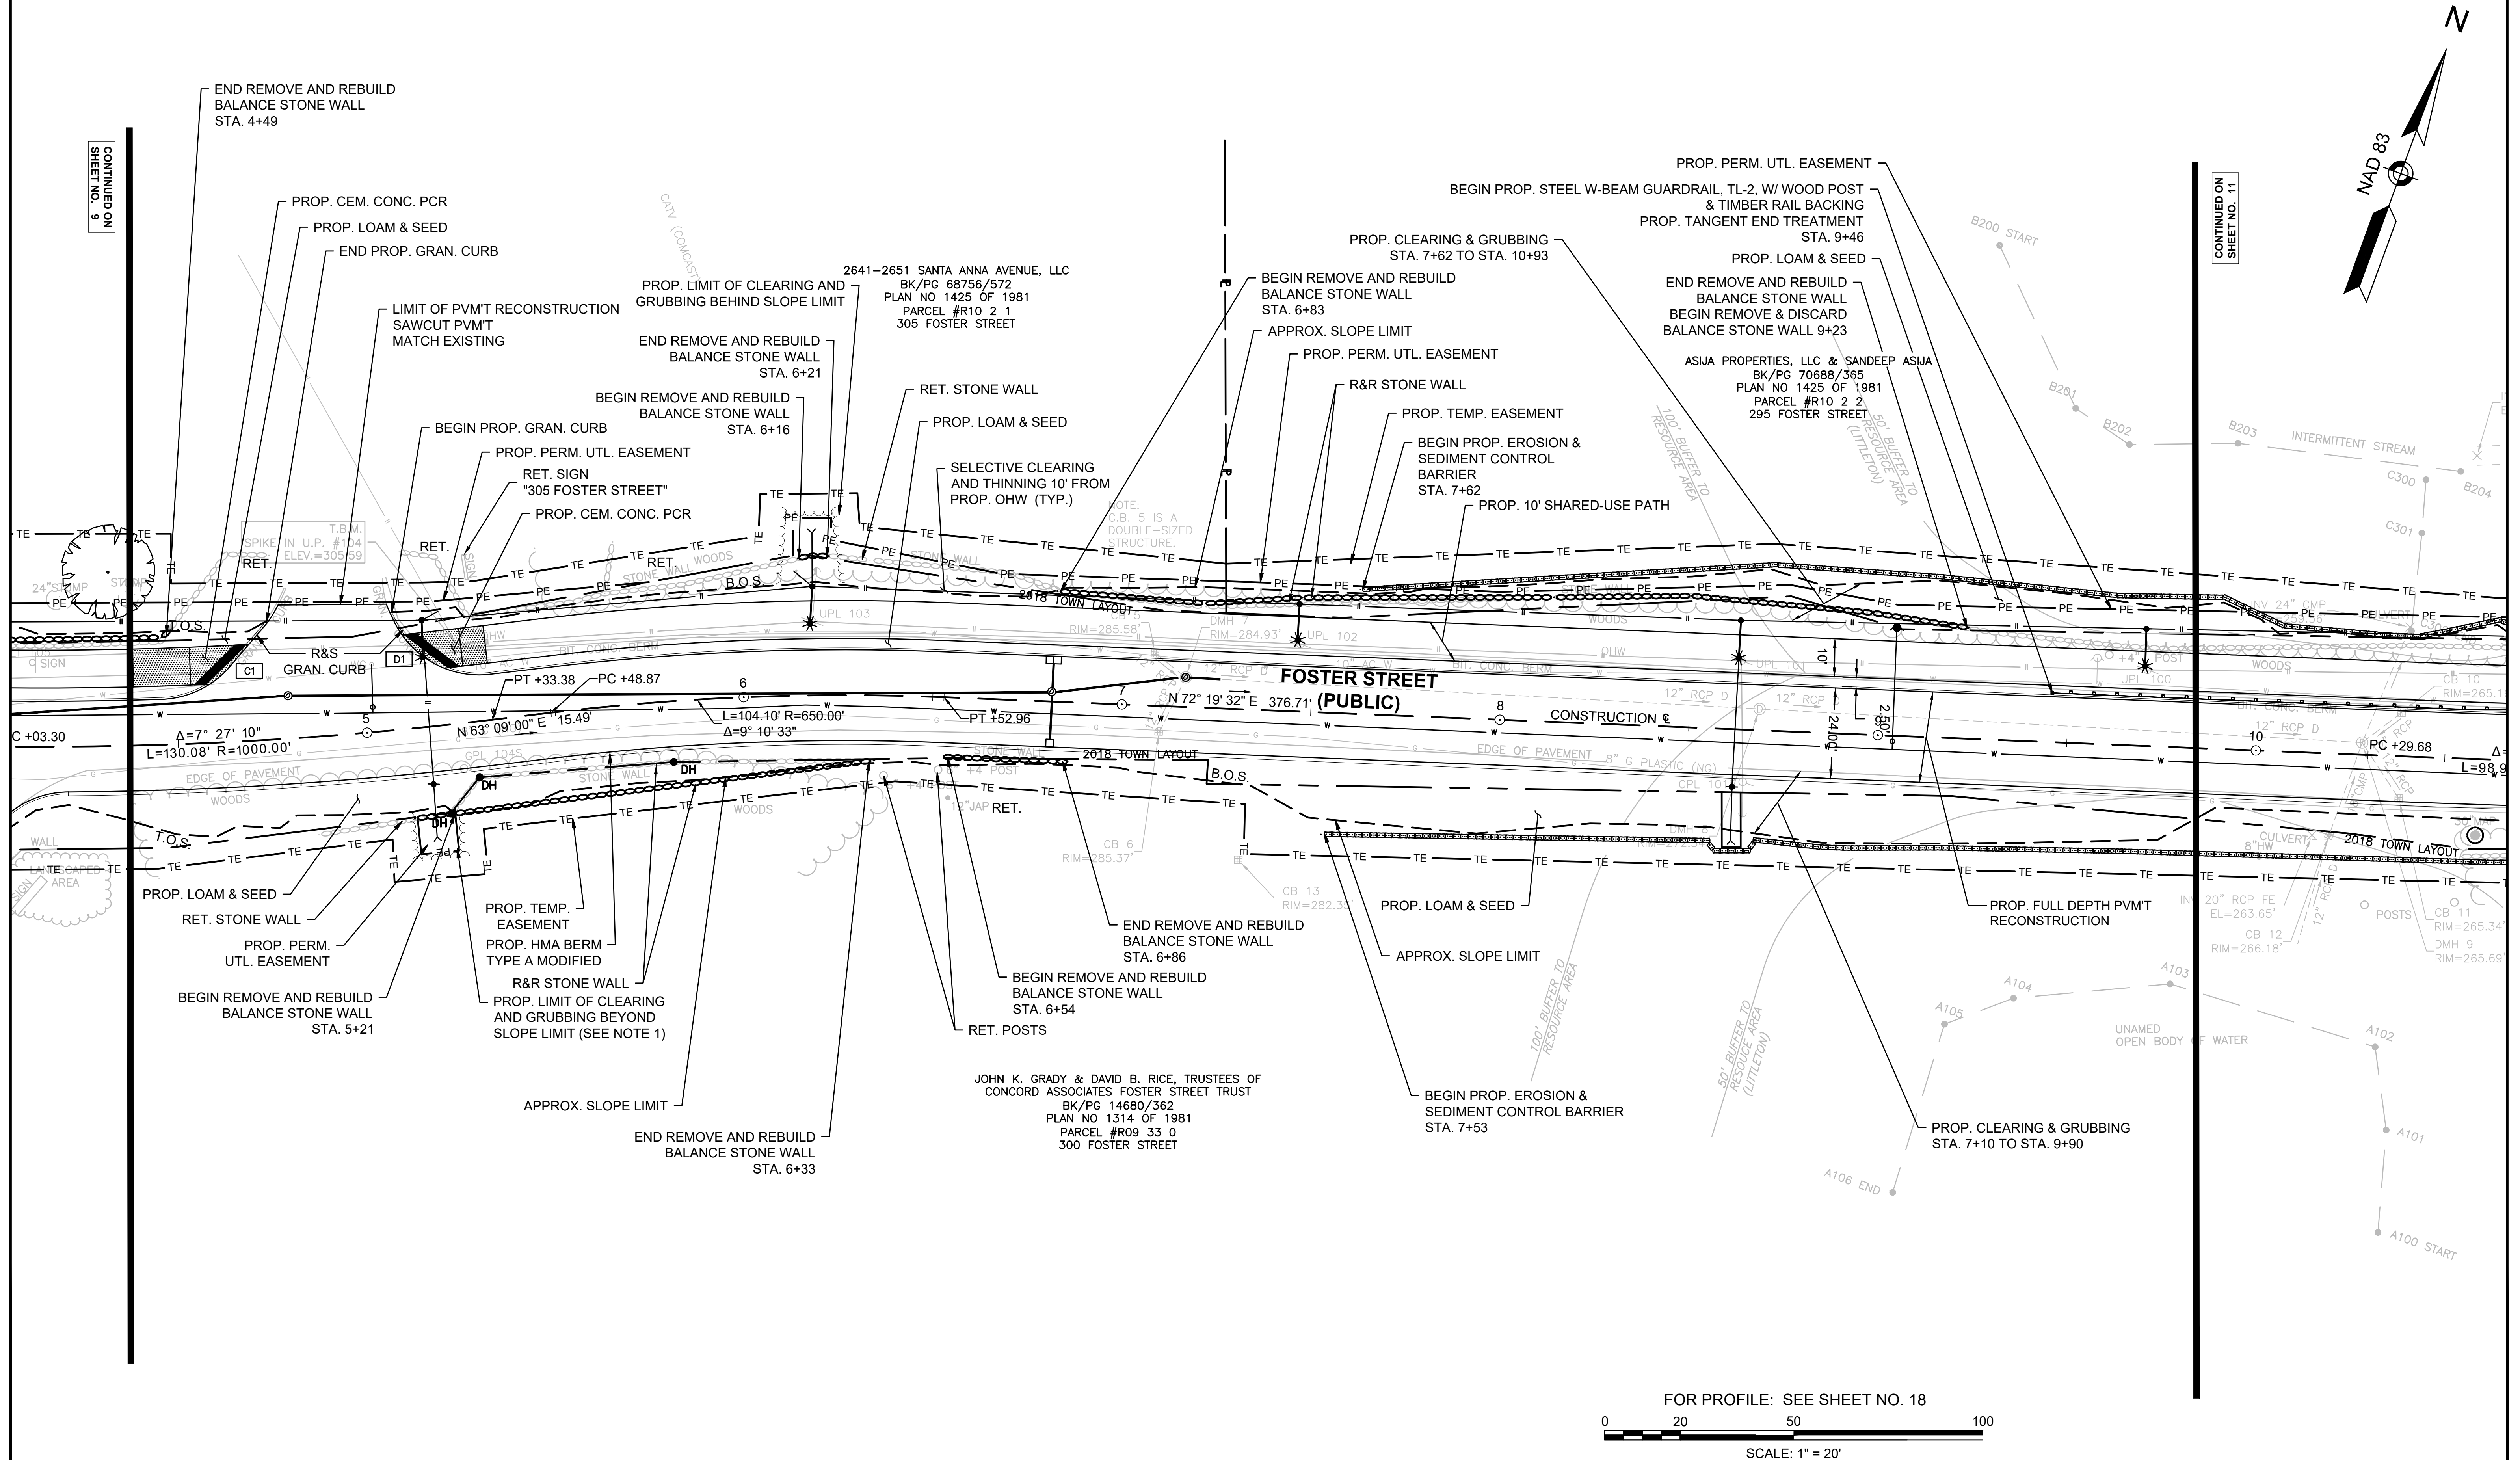

HIGHWAY GUARD DETAILS

STEEL W-BEAM GUARDRAIL (TL-2) W/ WOOD POST & TANGENT END STA. 9+46 LT
TO TANGENT END STA 10+84 LT

STEEL W-BEAM GUARDRAIL (TL-2) W/ WOOD POST & TANGENT END STA. 11+94 LT
TO TANGENT END STA 17+28 LT

TRAFFIC SIGNAL CONDUIT

NONE

WATER SUPPLY ALTERATIONS

SEE SHEET 57-64

DRAINAGE DETAILS

SEE SHEET NOS. 65-67

LEGEND:

PROPOSED PEDESTRIAN CURB
RAMP DETAIL #

X#


PROPOSED DRIVEWAY
TYPE #

DR#

LITTLETON
RECONSTRUCTION OF FOSTER STREET

STATE	FED. AID PROJ. NO.	SHEET NO.	TOTAL SHEETS
MA	XXX-XXX(XXX)X	11	129
PROJECT FILE NO.		609054	

CONSTRUCTION PLANS

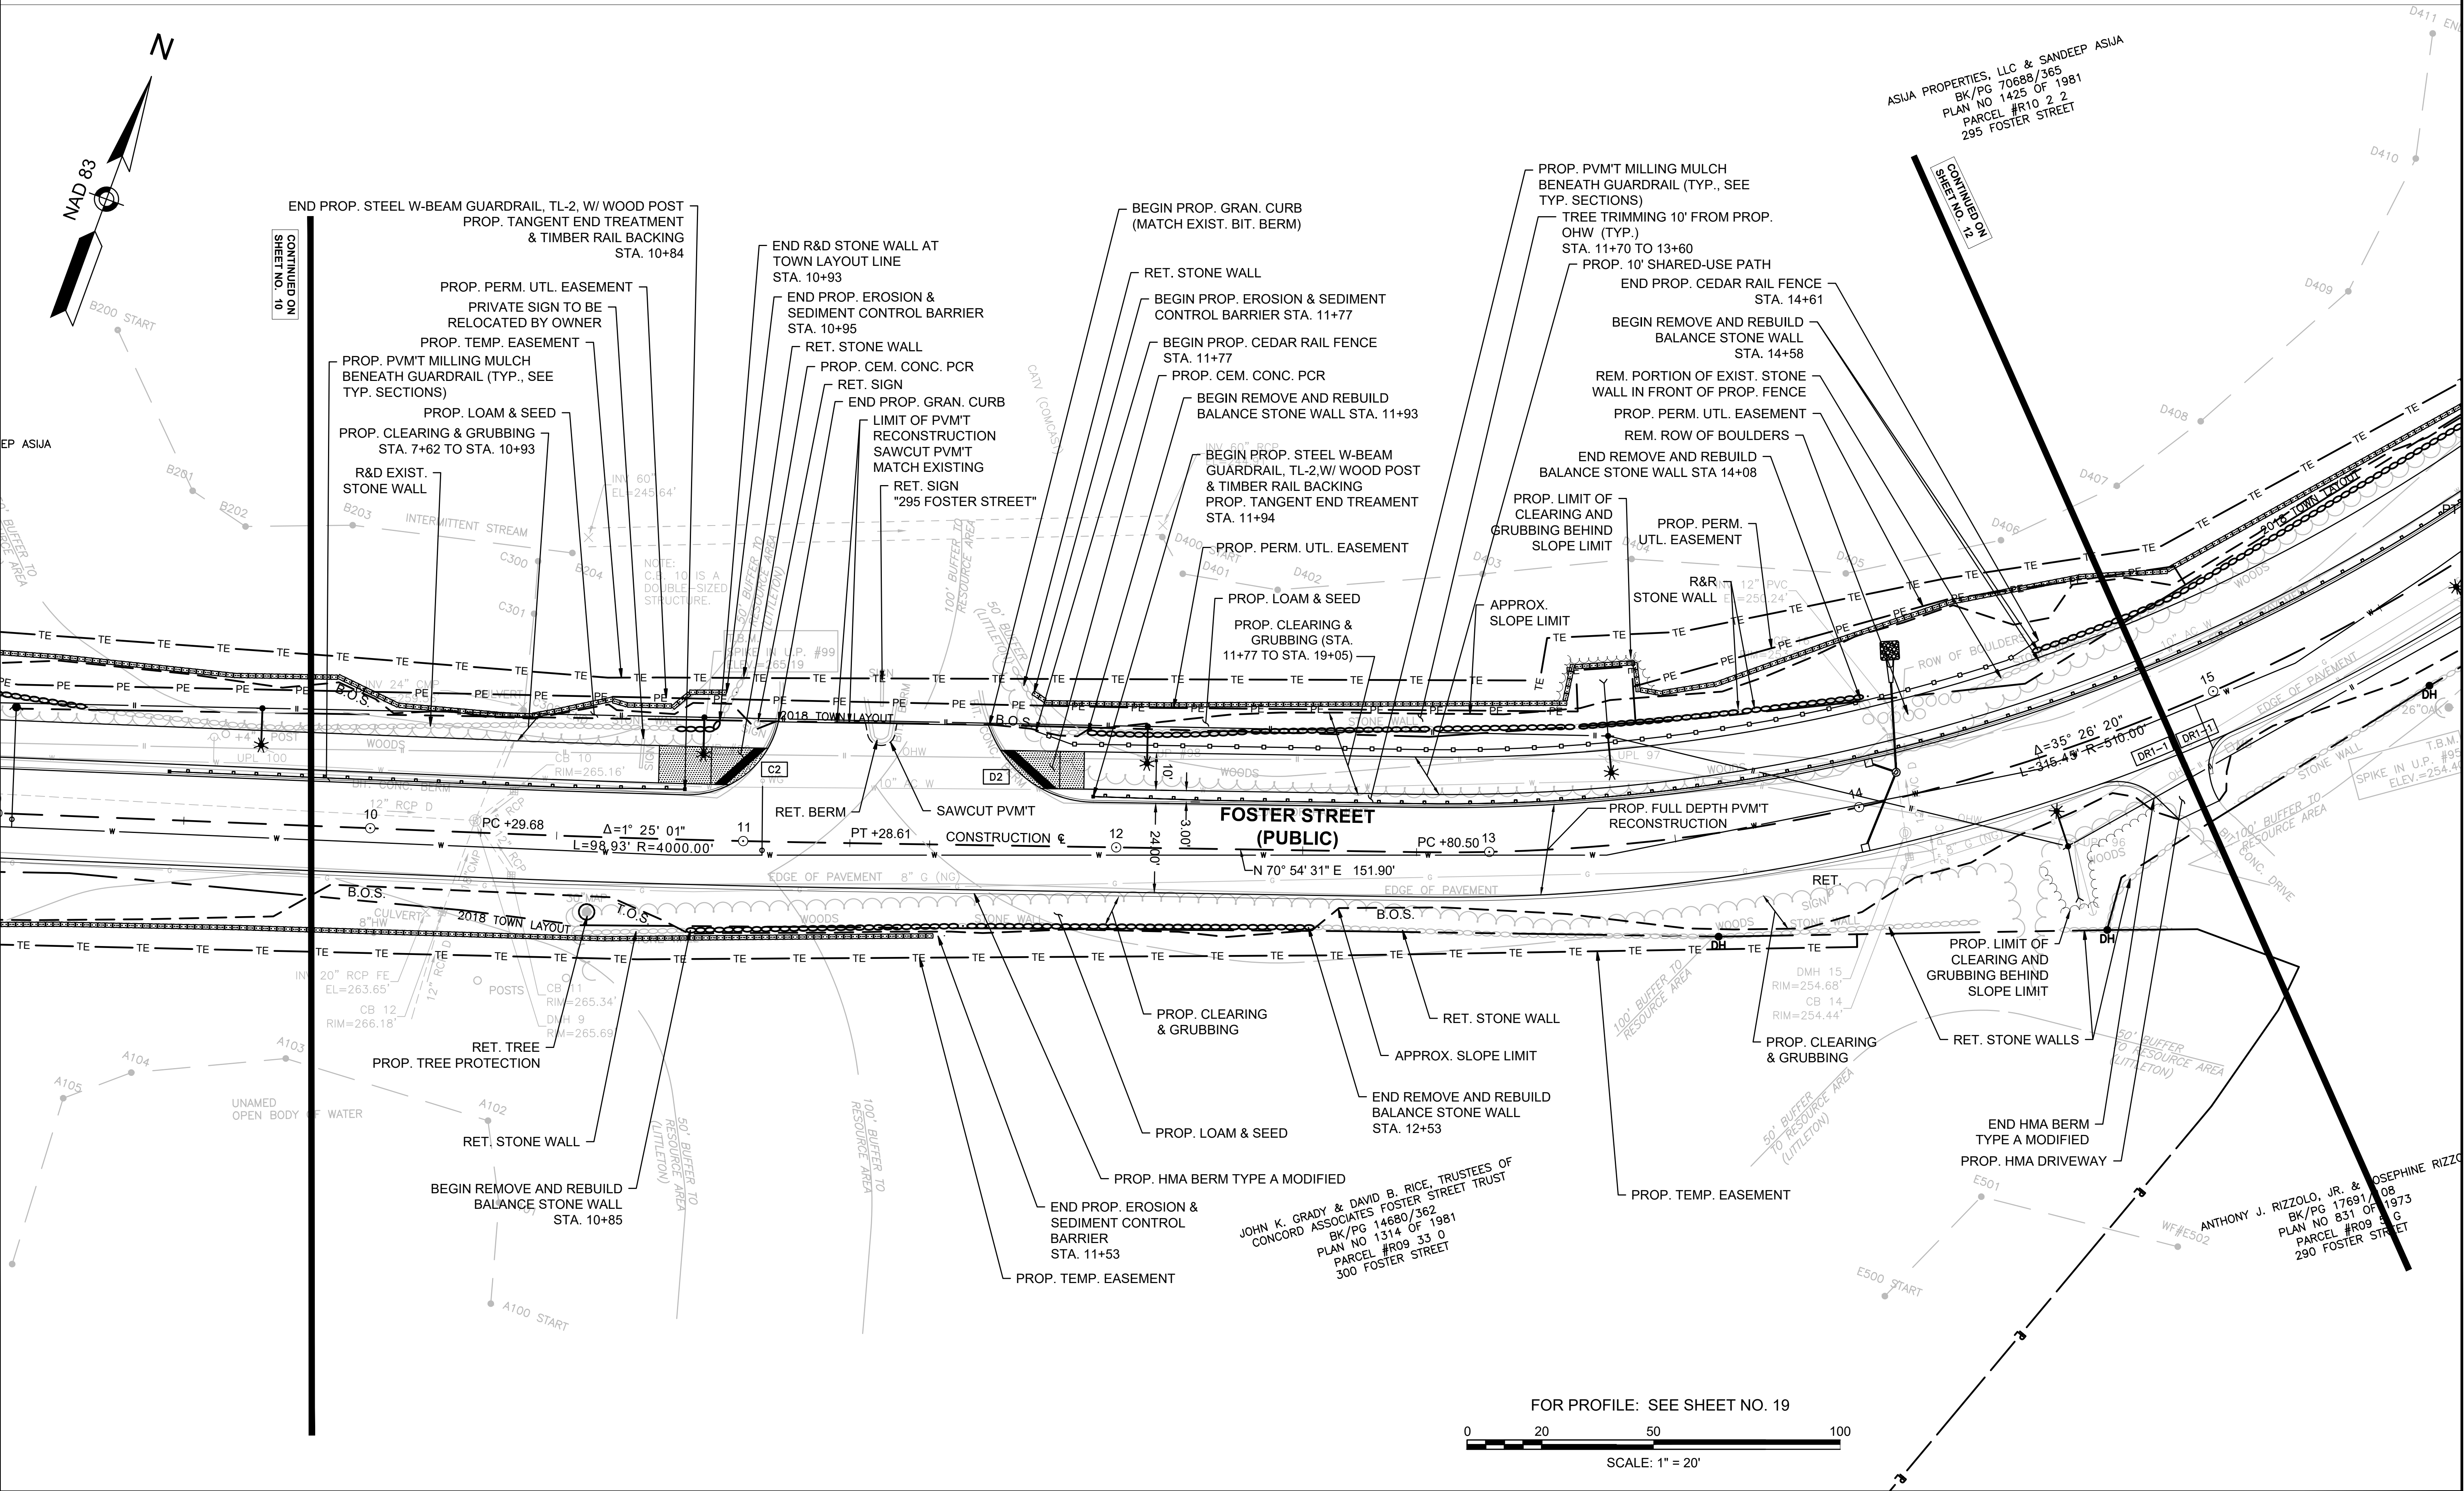

HIGHWAY GUARD DETAILS

STEEL W-BEAM GUARDRAIL (TL-2) W/ WOOD POST & TANGENT END STA. 11+94 TO TANGENT END STA 17+28

TRAFFIC SIGNAL CONDUIT

NONE

WATER SUPPLY ALTERATIONS

SEE SHEET 57-64

DRAINAGE DETAILS

SEE SHEET NOS. 65-67

LEGEND:

PROPOSED PEDESTRIAN CURB RAMP DETAIL #

X#

PROPOSED DRIVEWAY TYPE #


DR#

LITTLETON

RECONSTRUCTION OF FOSTER STREET

STATE	FED. AID PROJ. NO.	SHEET NO.	TOTAL SHEETS
MA	XXX-XXXX(XXX)X	12	129
PROJECT FILE NO. 609054			

CONSTRUCTION PLANS

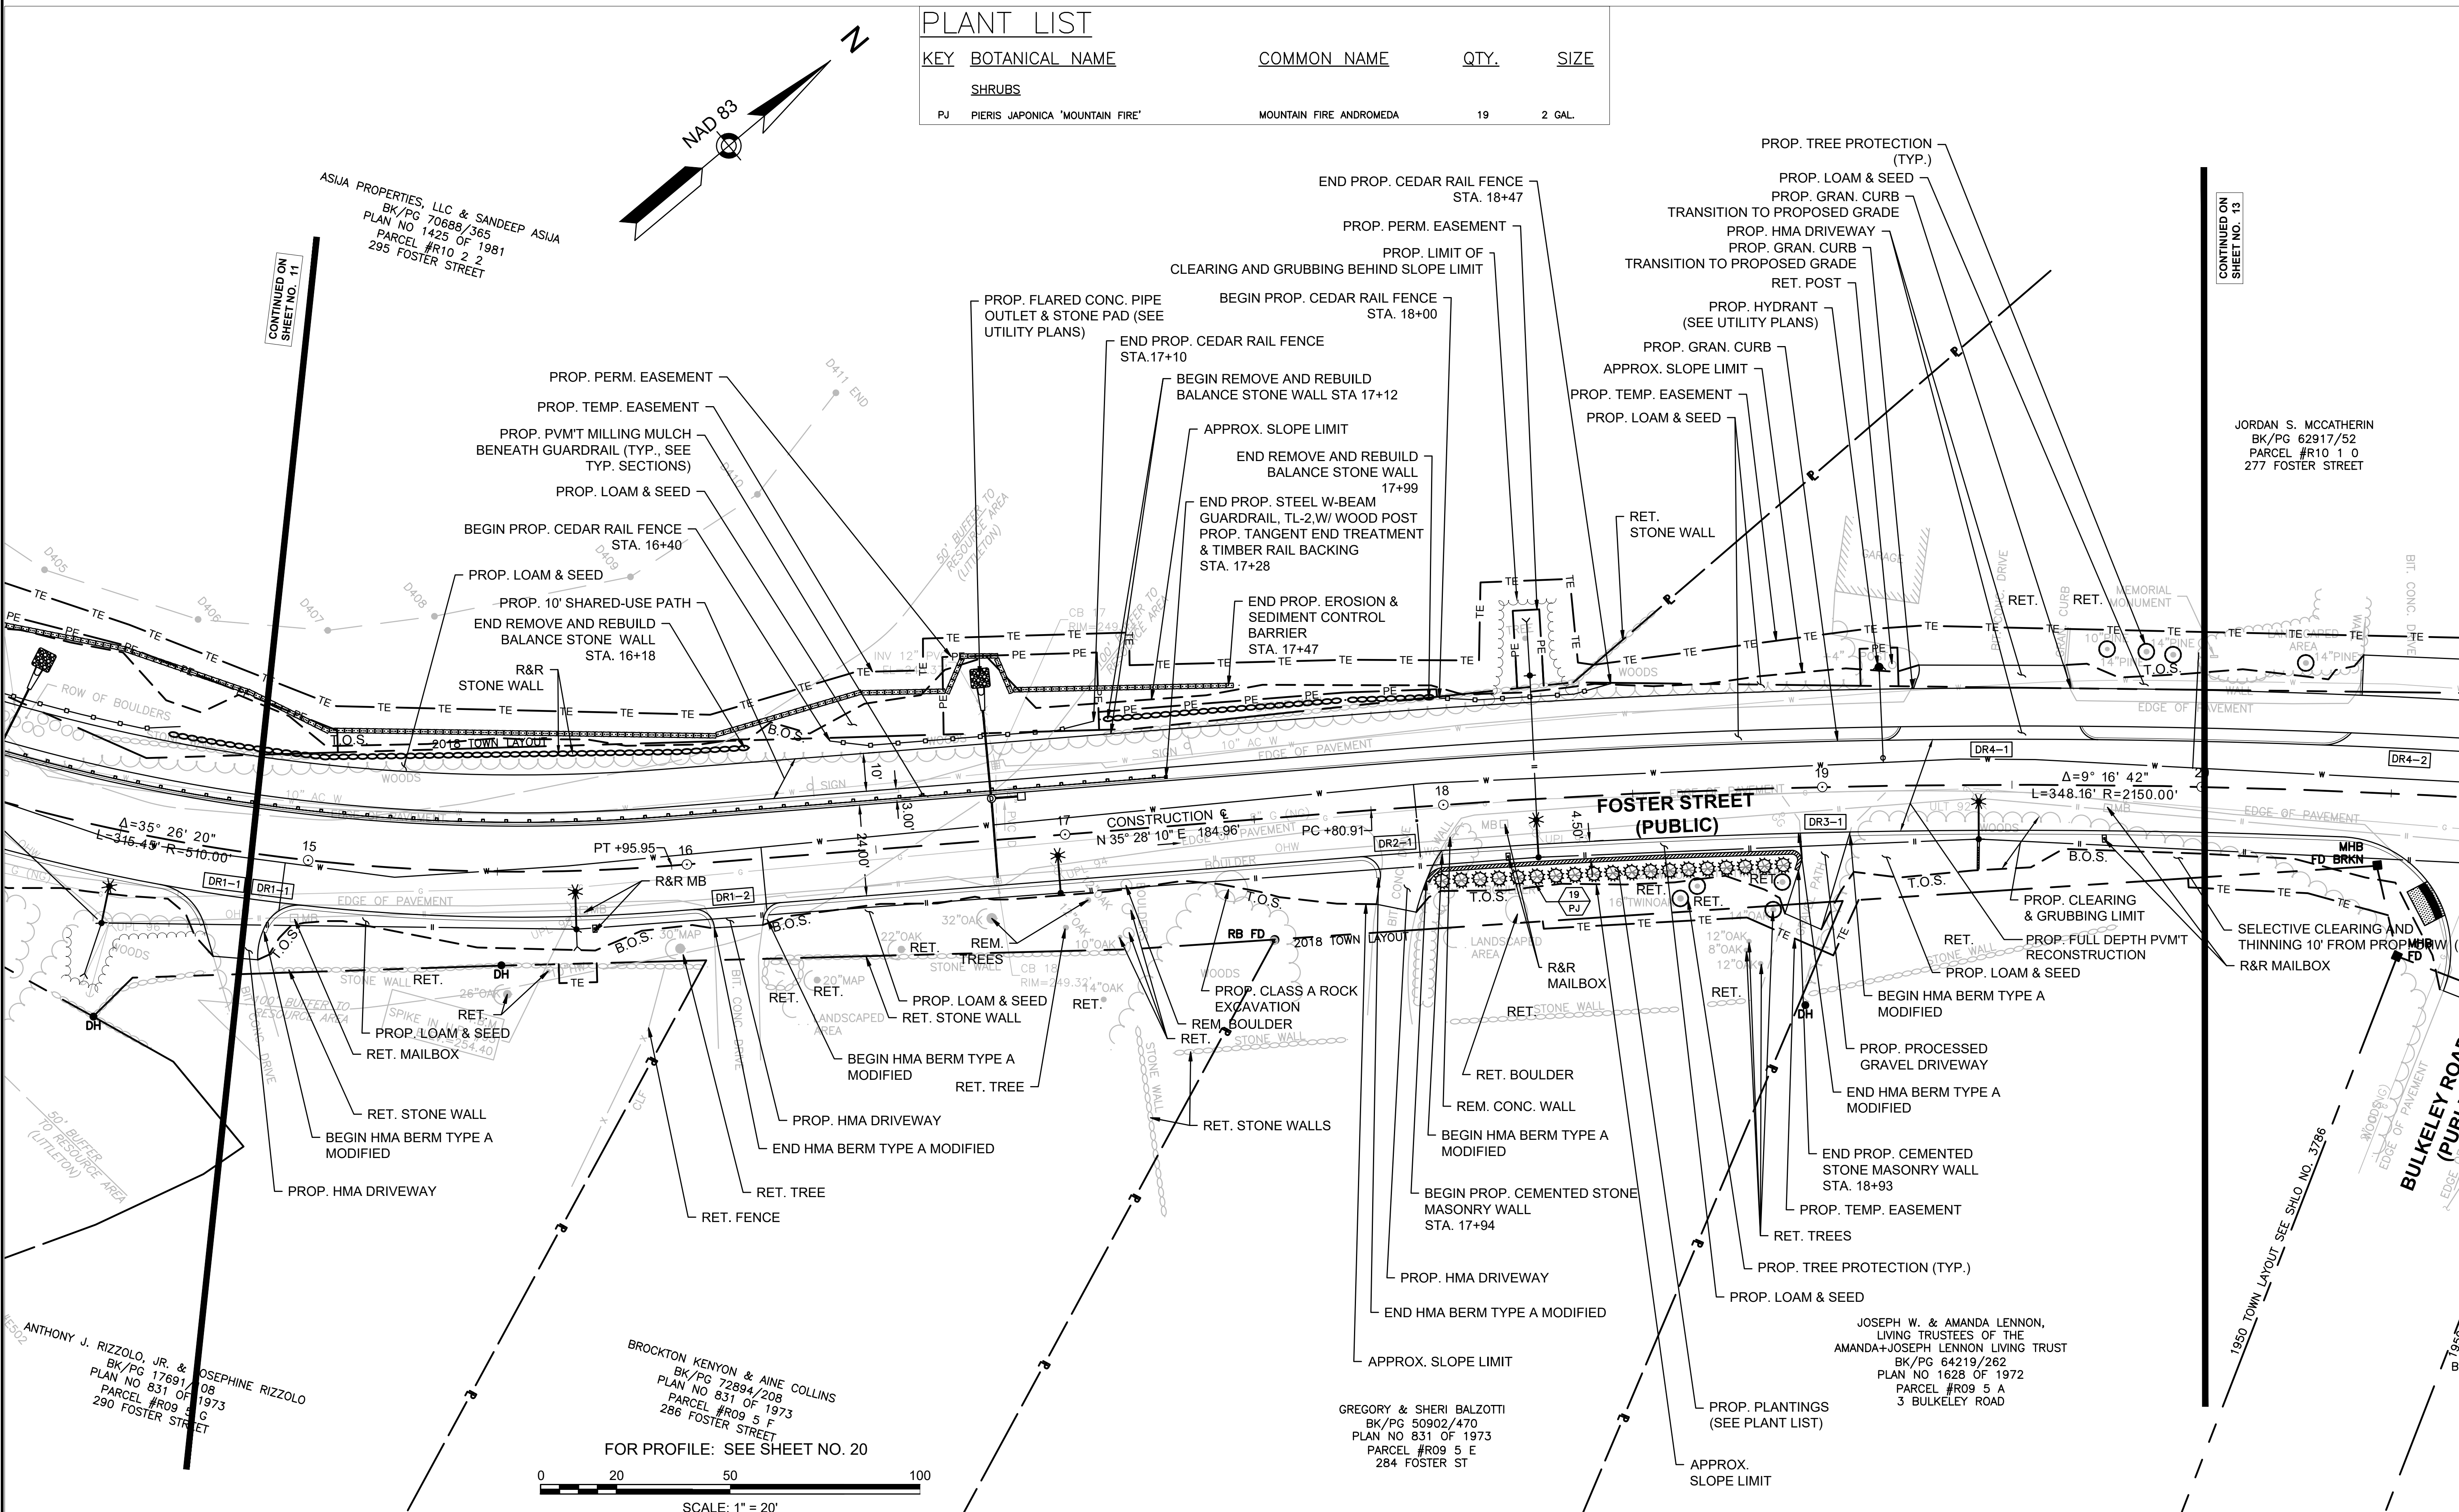

PLANT LIST			
KEY	BOTANICAL NAME	COMMON NAME	QTY. SIZE
SHRUBS			
PJ	PIERIS JAPONICA 'MOUNTAIN FIRE'	MOUNTAIN FIRE ANDROMEDA	19 2 GAL.

JORDAN S. MCCATHERIN
BK/PG 62917/52
PARCEL #R10 1 0
277 FOSTER STREET


JOSEPH W. & AMANDA LENNON,
LIVING TRUSTEES OF THE
AMANDA+JOSEPH LENNON LIVING TRUST
BK/PG 64219/262
PLAN NO 1628 OF 1972
PARCEL #R09 5 A
3 BULKELEY ROAD

GREGORY & SHERI BALZOTTI
BK/PG 50902/470
PLAN NO 831 OF 1973
PARCEL #R09 5 E
284 FOSTER ST

BROCKTON KENYON & AINE COLLINS
BK/PG 72894/208
PLAN NO 831 OF 1973
PARCEL #R09 5 F
286 FOSTER STREET

ANTHONY J. RIZZOLO, JR. & JOSEPHINE RIZZOLO
BK/PG 17691/08
PLAN NO 831 OF 1973
PARCEL #R09 5 G
290 FOSTER STREET

ASJA PROPERTIES, LLC & SANDEEP ASJA
BK/PG 70688/365
PLAN NO 1425 OF 1981
PARCEL #R10 2 2
295 FOSTER STREET

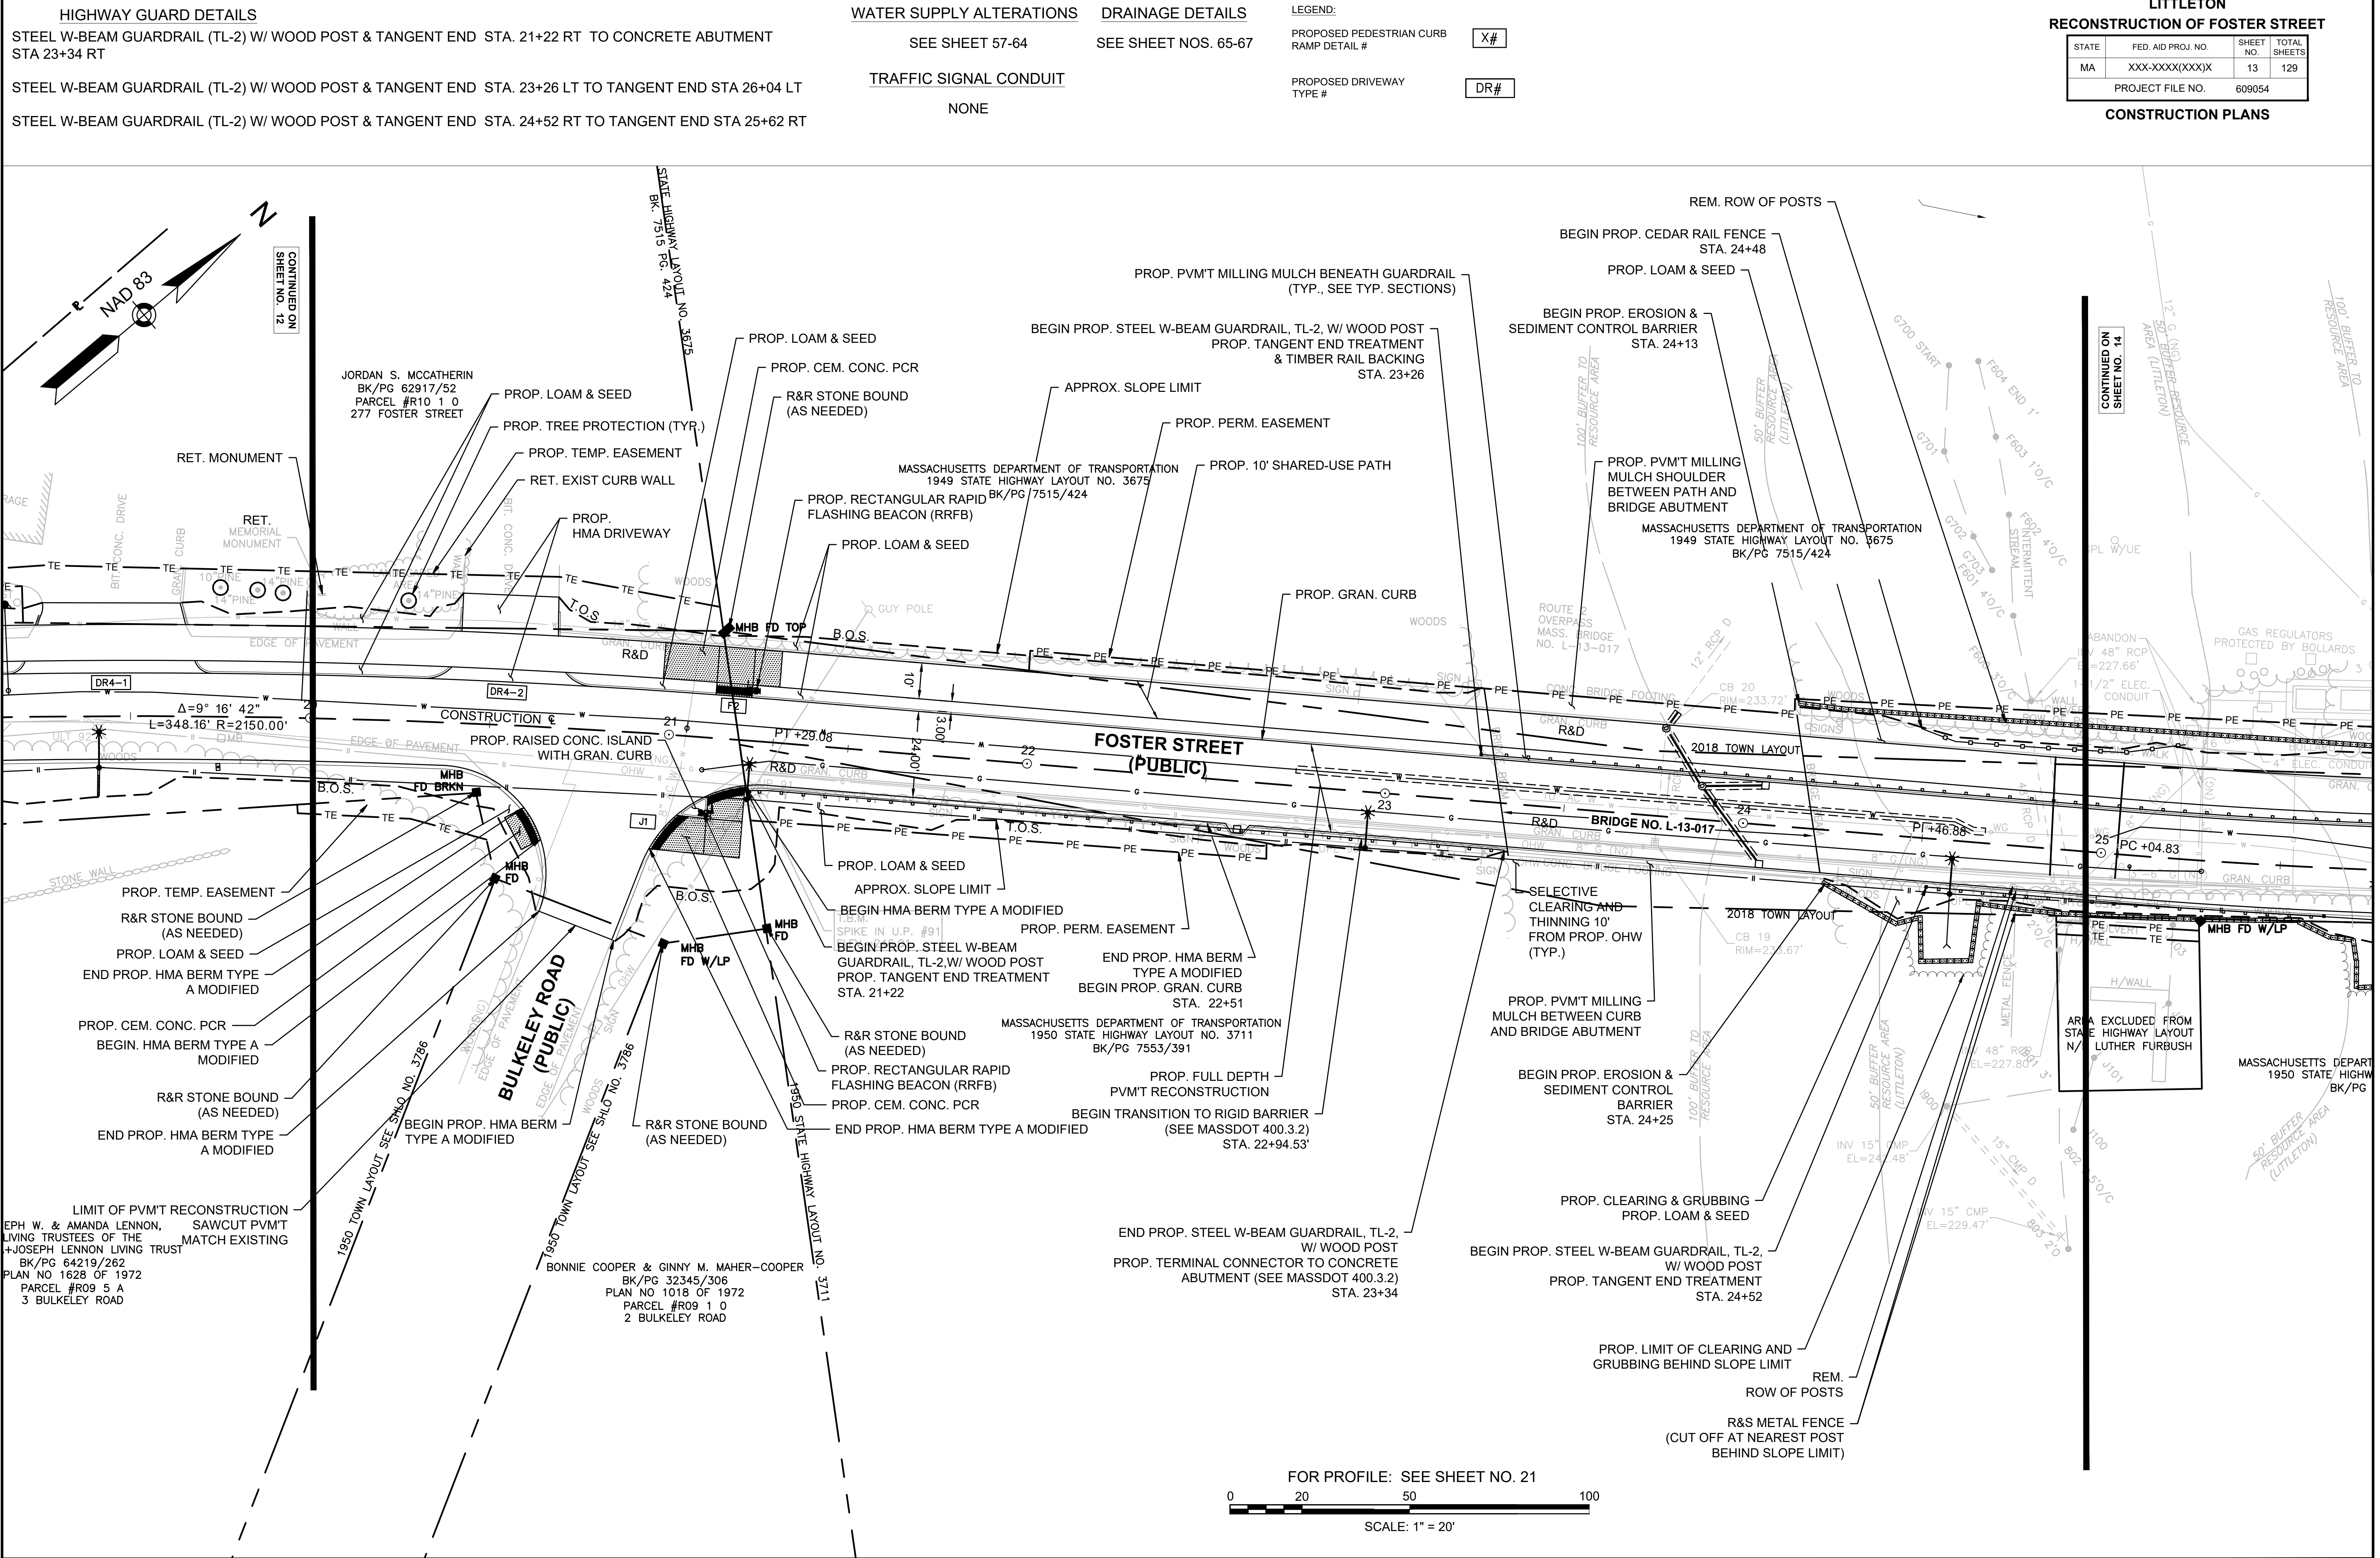

HIGHWAY GUARD DETAILS

STEEL W-BEAM GUARDRAIL (TL-2) W/ WOOD POST & TANGENT END STA. 23+26 LT TO TANGENT END STA 26+04 LT
STEEL W-BEAM GUARDRAIL (TL-2) W/ WOOD POST & TANGENT END STA. 24+52 RT TO TANGENT END STA 25+62 RT
STEEL W-BEAM GUARDRAIL (TL-2) W/ WOOD POST & TANGENT END STA. 28+49 RT TO FLARED END STA 32+83 RT
STEEL W-BEAM GUARDRAIL (TL-2) W/ WOOD POST & TANGENT END STA. 301+41 LT TO TANGENT END STA 300+48 LT

WATER SUPPLY ALTERATIONS

SEE SHEET 57-64

DRAINAGE DETAILS

SEE SHEET NOS. 65-67

TRAFFIC SIGNAL CONDUIT

NONE

LEGEND:

PROPOSED PEDESTRIAN CURB
RAMP DETAIL #

X#


PROPOSED DRIVEWAY
TYPE #

DR#

LITTLETON
RECONSTRUCTION OF FOSTER STREET

STATE	FED. AID PROJ. NO.	SHEET NO.	TOTAL SHEETS
MA	XXX-XXX(XXX)X	14	129
PROJECT FILE NO.		609054	

CONSTRUCTION PLANS

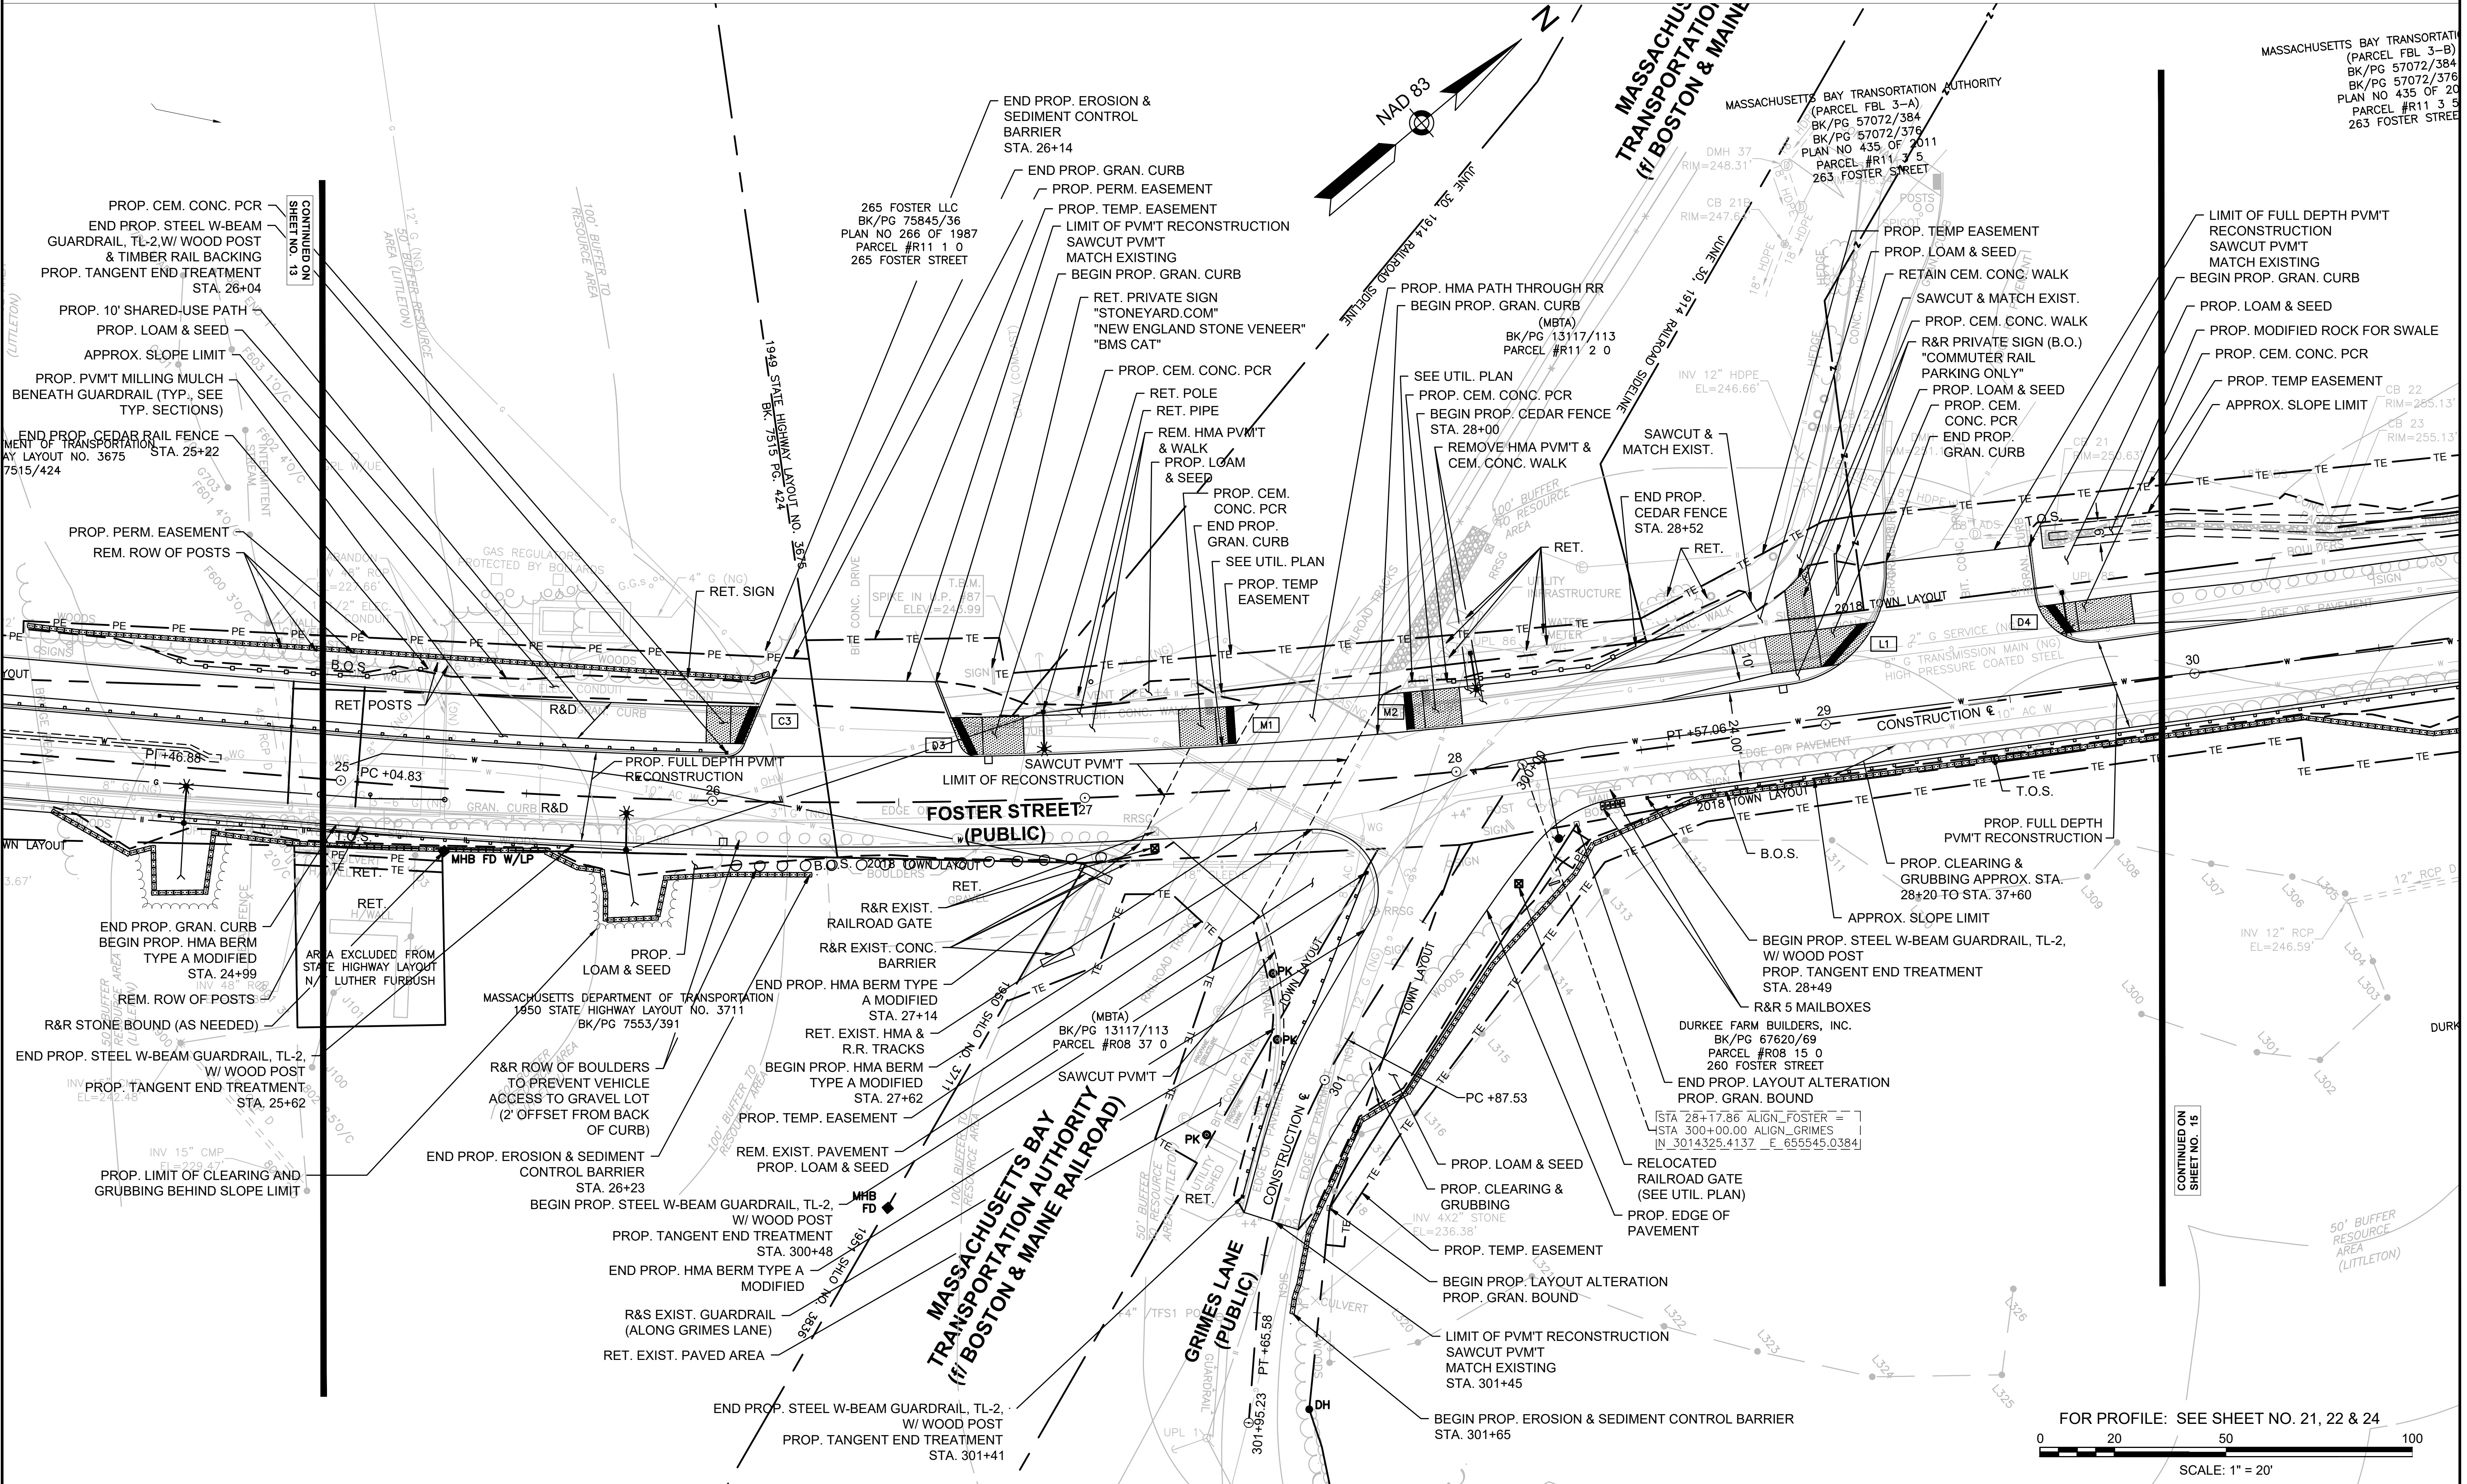

FOR PROFILE: SEE SHEET NO. 21, 22 & 24

0 20 50 100

SCALE: 1" = 20'

HIGHWAY GUARD DETAILS

STEEL W-BEAM GUARDRAIL (TL-2) W/ WOOD POST & TANGENT END STA. 28+49 RT TO FLARED END STA 32+83 RT

WATER SUPPLY ALTERATIONS

SEE SHEET 57-64

TRAFFIC SIGNAL CONDUIT

NONE

DRAINAGE DETAILS

SEE SHEET NOS. 65-67

LEGEND:

PROPOSED PEDESTRIAN CURB
RAMP DETAIL #

X#


PROPOSED DRIVEWAY
TYPE #

DR#


LITTLETON
RECONSTRUCTION OF FOSTER STREET

STATE	FED. AID PROJ. NO.	SHEET NO.	TOTAL SHEETS
MA	XXX-XXXX(XXX)X	15	129
PROJECT FILE NO.		609054	

CONSTRUCTION PLANS

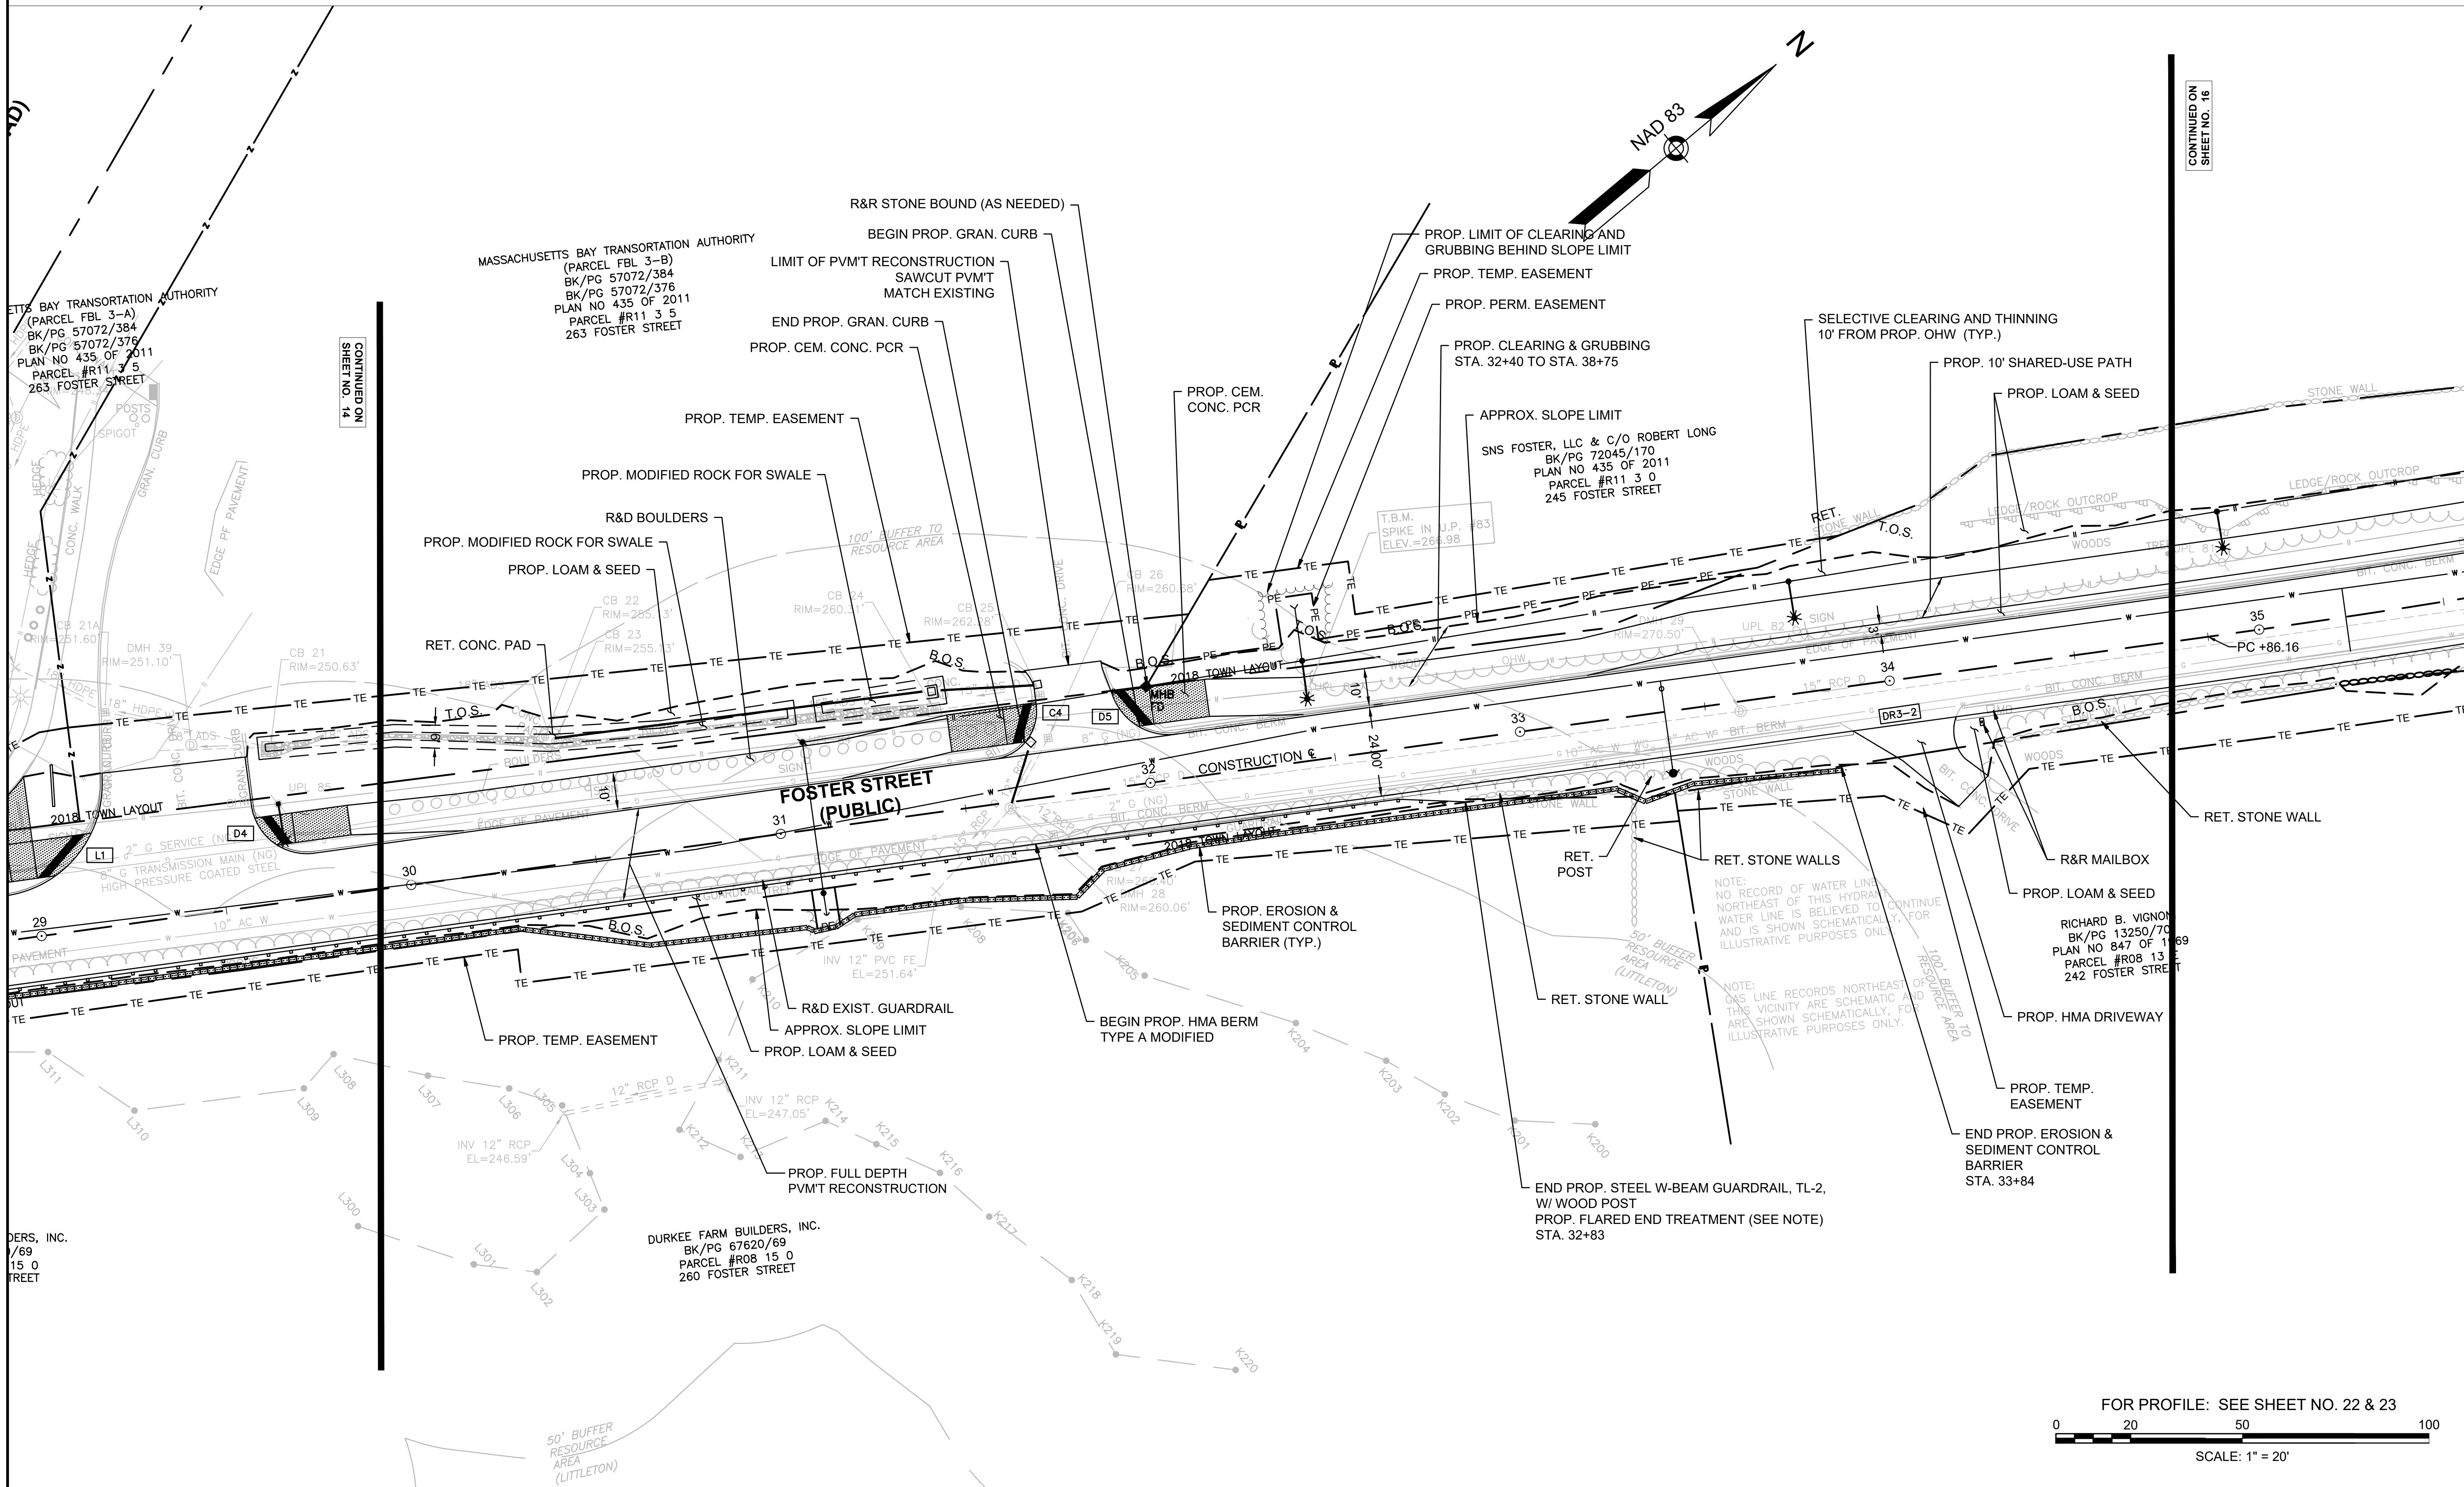

FOR PROFILE: SEE SHEET NO. 22 & 23

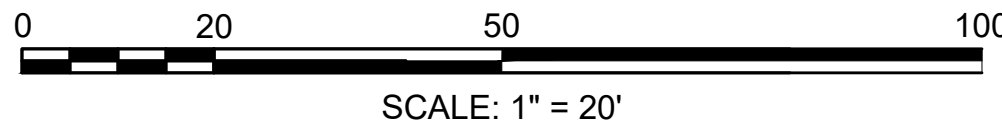

STEEL W-BEAM GUARDRAIL (TL-2) W/ WOOD POST & TANGENT END STA. 35+90 RT

NONE

SEE SHEET 57-64

SEE SHEET NOS. 65-67

PROPOSED PEDESTRIAN CURB
RAMP DETAIL #

X#

PROPOSED DRIVEWAY
TYPE #

DR#

STATE	FED. AID PROJ. NO.	SHEET NO.	TOTAL SHEETS
MA	XXX-XXXX(XXX)X	16	12
PROJECT FILE NO.		609054	

CONSTRUCTION PLANS

PATRICIA A. NARGIZIAN
BK/PG 70735/467
PARCEL #R11 5 4
237 FOSTER STREET

END OF PROJECT
PROJ. NO. 609054
STA. 39+36.15
N 3015278.1762
E 656130.7752

FOR PROFILE: SEE SHEET NO. 23

0 20 50 100

SCALE: 1" = 20'

SCALE: 1" = 20'

20170044A21 HPN01 DWIG Plotted on 19-Apr-2023 1:49 AM

20170044A21 HPN01 DWG

PROJECT SUMMARY PLANT LIST

KEY	BOTANICAL NAME	COMMON NAME	HT.	QTY.	SIZE
TREES					
AC	ACER RUBRUM	MAPLE-RED-"OCTOBER GLORY"	50	5	2"-2.5" CAL.
PJ	PIERIS JAPONICA 'MOUNTAIN FIRE'	MOUNTAIN FIRE ANDROMEDA	19	2 GAL.	

ENVIRONMENTAL PLANS LEGEND

- EXISTING TREE LINE
- PROPOSED TREE LINE
- BORDERING VEGETATED WETLANDS
- BANK/LAND UNDER WATER
- 100FT BUFFER from BVW or BANK
- 50FT NO DISTURB LIMIT from BVW or BANK
- EROSION CONTROLS
- LIMIT OF WORK

- PERM IMPACT TO BUFFER ZONE
- TEMP IMPACT TO BUFFER ZONE
- PERM IMPACT TO 50-FT NO DISTURB
- TEMP IMPACT TO 50-FT NO DISTURB
- IMPERVIOUS REMOVED FROM 50-FT NO DISTURB
- IMPERVIOUS REMOVED FROM BUFFER ZONE


2641-2651 SANTA ANNA AVENUE, LLC
BK/PG 68756/572
PLAN NO 1425 OF 1981
PARCEL #R10 2 1
305 FOSTER STREET

PLANT LIST


KEY	BOTANICAL NAME	COMMON NAME	HT.	QTY.	SIZE
TREES					
AC	ACER RUBRUM	MAPLE-RED-"OCTOBER GLORY"	50	5	2"-2.5" CAL.

JOHN K. GRADY & DAVID B. RICE, TRUSTEES OF
CONCORD ASSOCIATES FOSTER STREET TRUST
BK/PG 14680/362
PLAN NO 1314 OF 1981
PARCEL #R09 33 0
300 FOSTER STREET


FOR PROFILE: SEE SHEET NO. 17

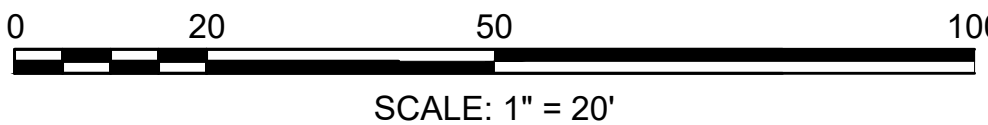

PLANTING LEGEND

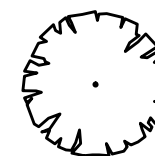

PROPOSED TREE PLANTING

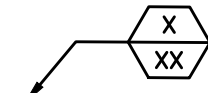

PLANT QUANTITY AND SPECIES

GUTIERREZ ARTURO+CATALDO CLASS B TRUST
SWEENEY D CLASS A TRUST
BK/PG 32096/213
PARCEL #R10 6 0
TAYLOR STREET

BEGINNING OF PROJECT
PROJ. NO. 609054
STA 0+00.00
N3012786.8847
E653296.9381

STA 203+20.63 ALIGN TAYLOR
STA 0+00.00 ALIGN FOSTER
N 3012786.8847 E 653296.9381

GUTIERREZ ARTURO+CATALDO CLASS B TRUST
SWEENEY D CLASS A TRUST
BK/PG 32096/215
PARCEL #R10 7 0
225 TAYLOR STREET


JOHN K. GRADY, TRUSTEE OF THE
FOSTER/TAYLOR REALTY TRUST
BK/PG 25198/143
PLAN NO 228 OF 1992
PARCEL #R09 32 0
230 TAYLOR STREET

ENVIRONMENTAL PLANS LEGEND

- EXISTING TREE LINE
- PROPOSED TREE LINE
- BORDERING VEGETATED WETLANDS
- BANK/LAND UNDER WATER
- 100FT BUFFER from BVW or BANK
- 50FT NO DISTURB LIMIT from BVW or BANK
- EROSION CONTROLS
- LIMIT OF WORK
- PERM IMPACT TO BUFFER ZONE
- TEMP IMPACT TO BUFFER ZONE
- PERM IMPACT TO 50-FT NO DISTURB
- TEMP IMPACT TO 50-FT NO DISTURB
- IMPERVIOUS REMOVED FROM 50-FT NO DISTURB
- IMPERVIOUS REMOVED FROM BUFFER ZONE

LITTLETON RECONSTRUCTION OF FOSTER STREET			
STATE	FED. AID PROJ. NO.	SHEET NO.	TOTAL SHEETS
MA	XXX-XXX(XXX)X	E2	129
PROJECT FILE NO.		609054	

ENVIRONMENTAL PLANS

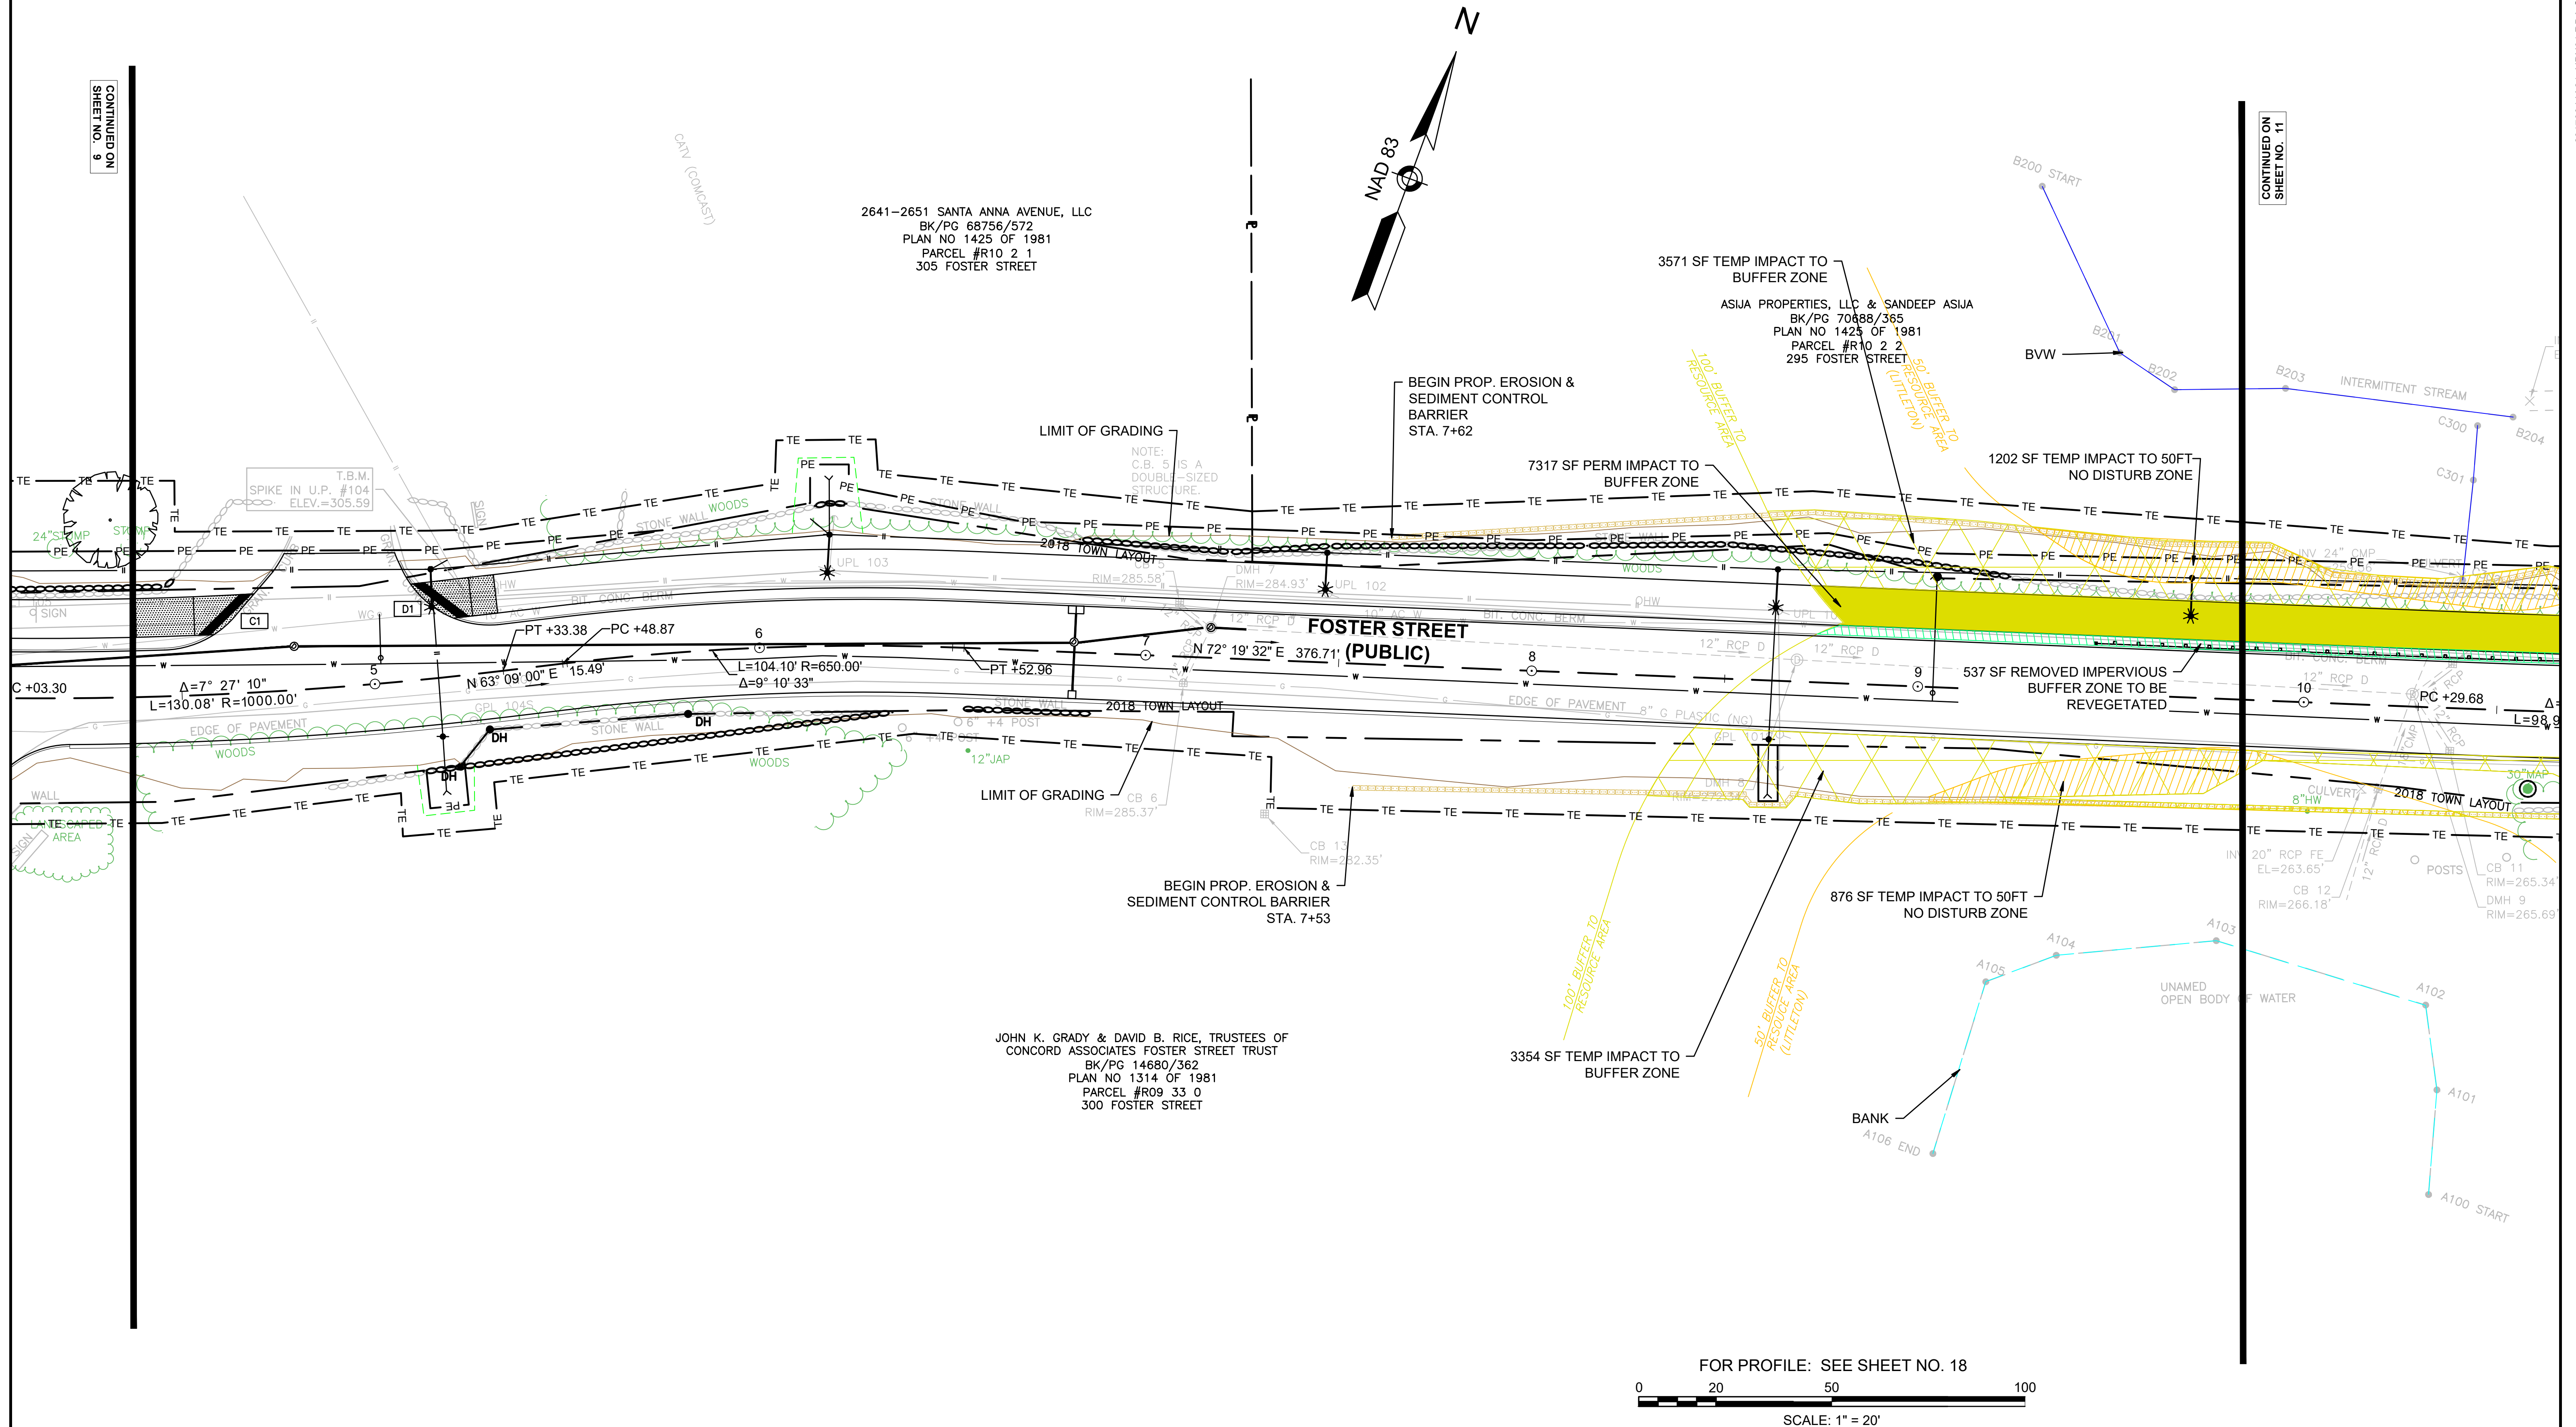

FOR PROFILE: SEE SHEET NO. 18
0 20 50 100
SCALE: 1" = 20'

ENVIRONMENTAL PLANS LEGEND


- EXISTING TREE LINE
- PROPOSED TREE LINE
- BORDERING VEGETATED WETLANDS
- BANK/LAND UNDER WATER
- 100FT BUFFER from BVW or BANK
- 50FT NO DISTURB LIMIT from BVW or BANK
- EROSION CONTROLS
- LIMIT OF WORK
- PERM IMPACT TO BUFFER ZONE
- TEMP IMPACT TO BUFFER ZONE
- PERM IMPACT TO 50-FT NO DISTURB
- TEMP IMPACT TO 50-FT NO DISTURB
- IMPERVIOUS REMOVED FROM 50-FT NO DISTURB
- IMPERVIOUS REMOVED FROM BUFFER ZONE

LITTLETON

RECONSTRUCTION OF FOSTER STREET

STATE	FED. AID PROJ. NO.	SHEET NO.	TOTAL SHEETS
MA	XXX-XXX(XXX)X	E3	129
PROJECT FILE NO.		609054	

ENVIRONMENTAL PLANS

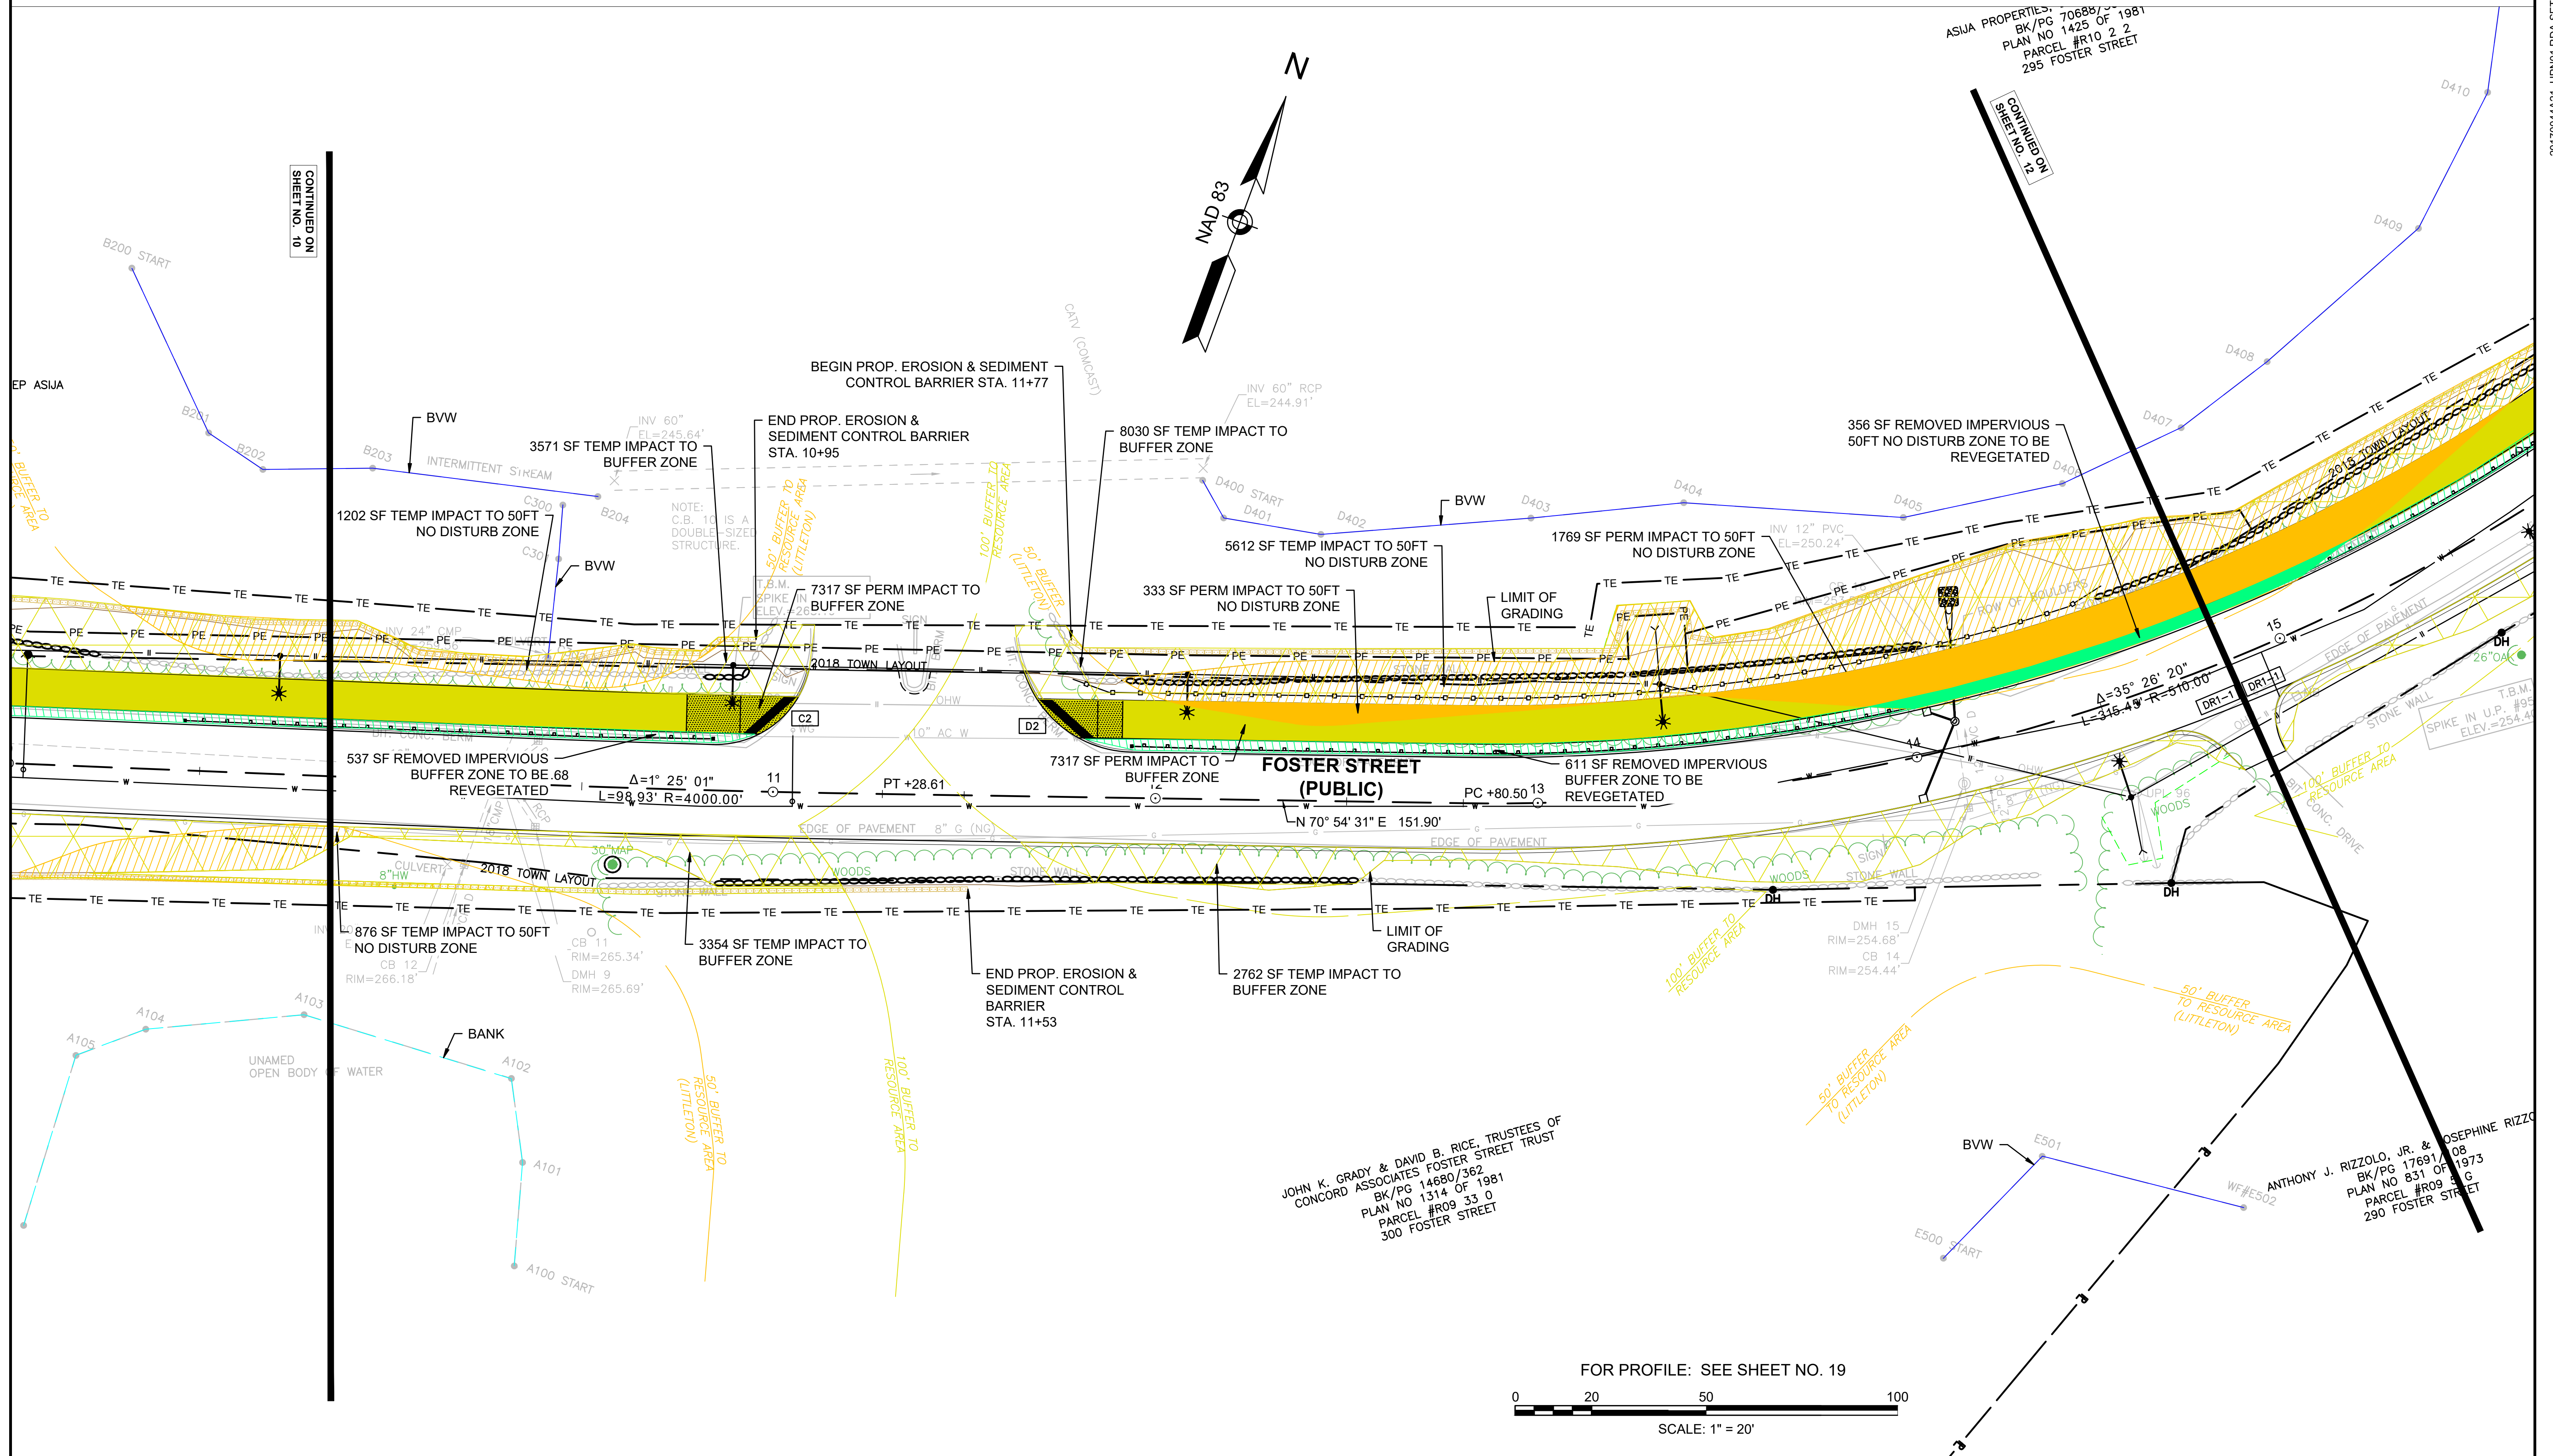

Legend:

- EXISTING TREE LINE
- PROPOSED TREE LINE
- BORDERING VEGETATED WETLANDS
- BANK/LAND UNDER WATER
- 100FT BUFFER from BVW or BANK
- 50FT NO DISTURB LIMIT from BVW or BANK
- EROSION CONTROLS
- LIMIT OF WORK
- PERM IMPACT TO BUFFER ZONE
- TEMP IMPACT TO BUFFER ZONE
- PERM IMPACT TO 50-FT NO DISTURB
- TEMP IMPACT TO 50-FT NO DISTURB
- IMPERVIOUS REMOVED FROM 50-FT NO DISTURB
- IMPERVIOUS REMOVED FROM BUFFER ZONE

ENVIRONMENTAL PLANS

<u>KEY</u>	<u>BOTANICAL NAME</u>	<u>COMMON NAME</u>	<u>QTY.</u>	<u>SIZE</u>
<u>SHRUBS</u>				
PJ	PIERIS JAPONICA 'MOUNTAIN FIRE'	MOUNTAIN FIRE ANDROMEDA	19	2 GAL.




ENVIRONMENTAL PLANS LEGEND

- EXISTING TREE LINE
- PROPOSED TREE LINE
- BORDERING VEGETATED WETLANDS
- BANK/LAND UNDER WATER
- 100FT BUFFER from BVW or BANK
- 50FT NO DISTURB LIMIT from BVW or BANK
- EROSION CONTROLS
- LIMIT OF WORK
- PERM IMPACT TO BUFFER ZONE
- TEMP IMPACT TO BUFFER ZONE
- PERM IMPACT TO 50-FT NO DISTURB
- TEMP IMPACT TO 50-FT NO DISTURB
- IMPERVIOUS REMOVED FROM 50-FT NO DISTURB
- IMPERVIOUS REMOVED FROM BUFFER ZONE

LITTLETON RECONSTRUCTION OF FOSTER STREET

STATE	FED. AID PROJ. NO.	SHEET NO.	TOTAL SHEETS
MA	XXX-XXX(XXX)X	E5	129
PROJECT FILE NO.		609054	

ENVIRONMENTAL PLANS

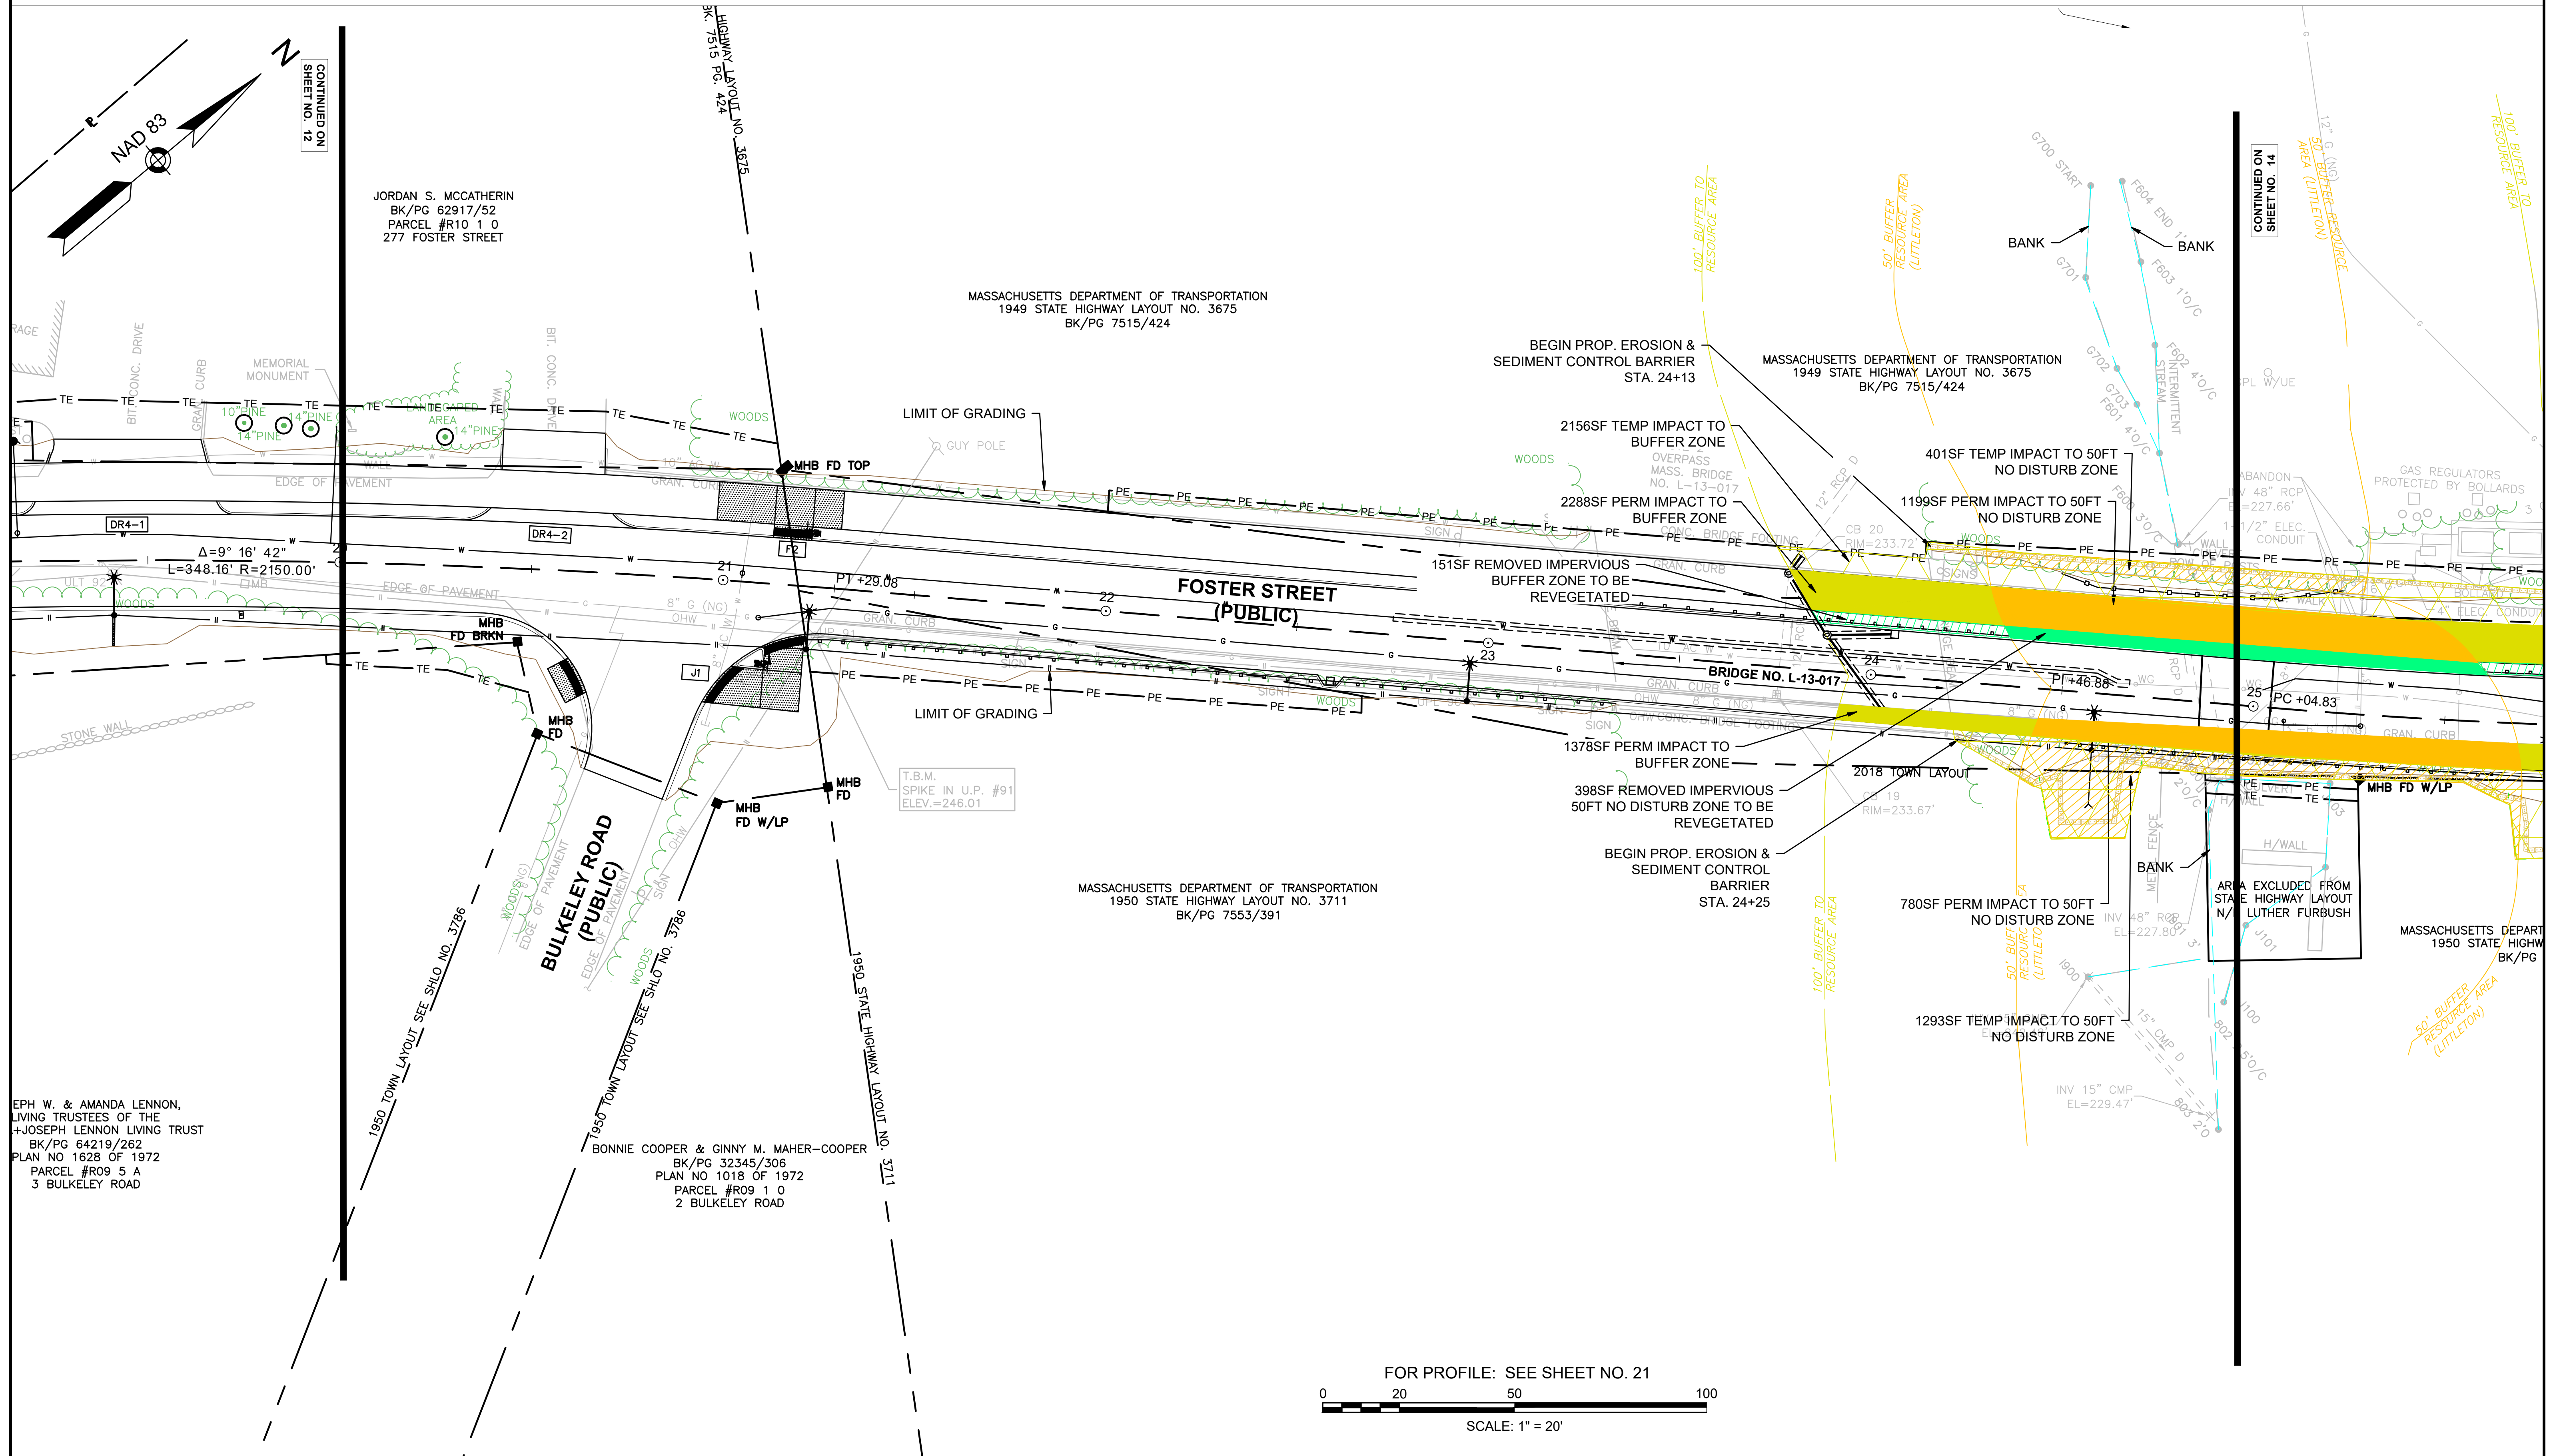


ENVIRONMENTAL PLANS LEGEND

- EXISTING TREE LINE
- PROPOSED TREE LINE
- BORDERING VEGETATED WETLANDS
- BANK/LAND UNDER WATER
- 100FT BUFFER from BVW or BANK
- 50FT NO DISTURB LIMIT from BVW or BANK
- EROSION CONTROLS
- LIMIT OF WORK
- PERM IMPACT TO BUFFER ZONE
- TEMP IMPACT TO BUFFER ZONE
- PERM IMPACT TO 50-FT NO DISTURB
- TEMP IMPACT TO 50-FT NO DISTURB
- IMPERVIOUS REMOVED FROM 50-FT NO DISTURB
- IMPERVIOUS REMOVED FROM BUFFER ZONE

LITTLETON RECONSTRUCTION OF FOSTER STREET

STATE	FED. AID PROJ. NO.	SHEET NO.	TOTAL SHEETS
MA	XXX-XXX(XXX)X	E6	129
PROJECT FILE NO. 609054			

ENVIRONMENTAL PLANS

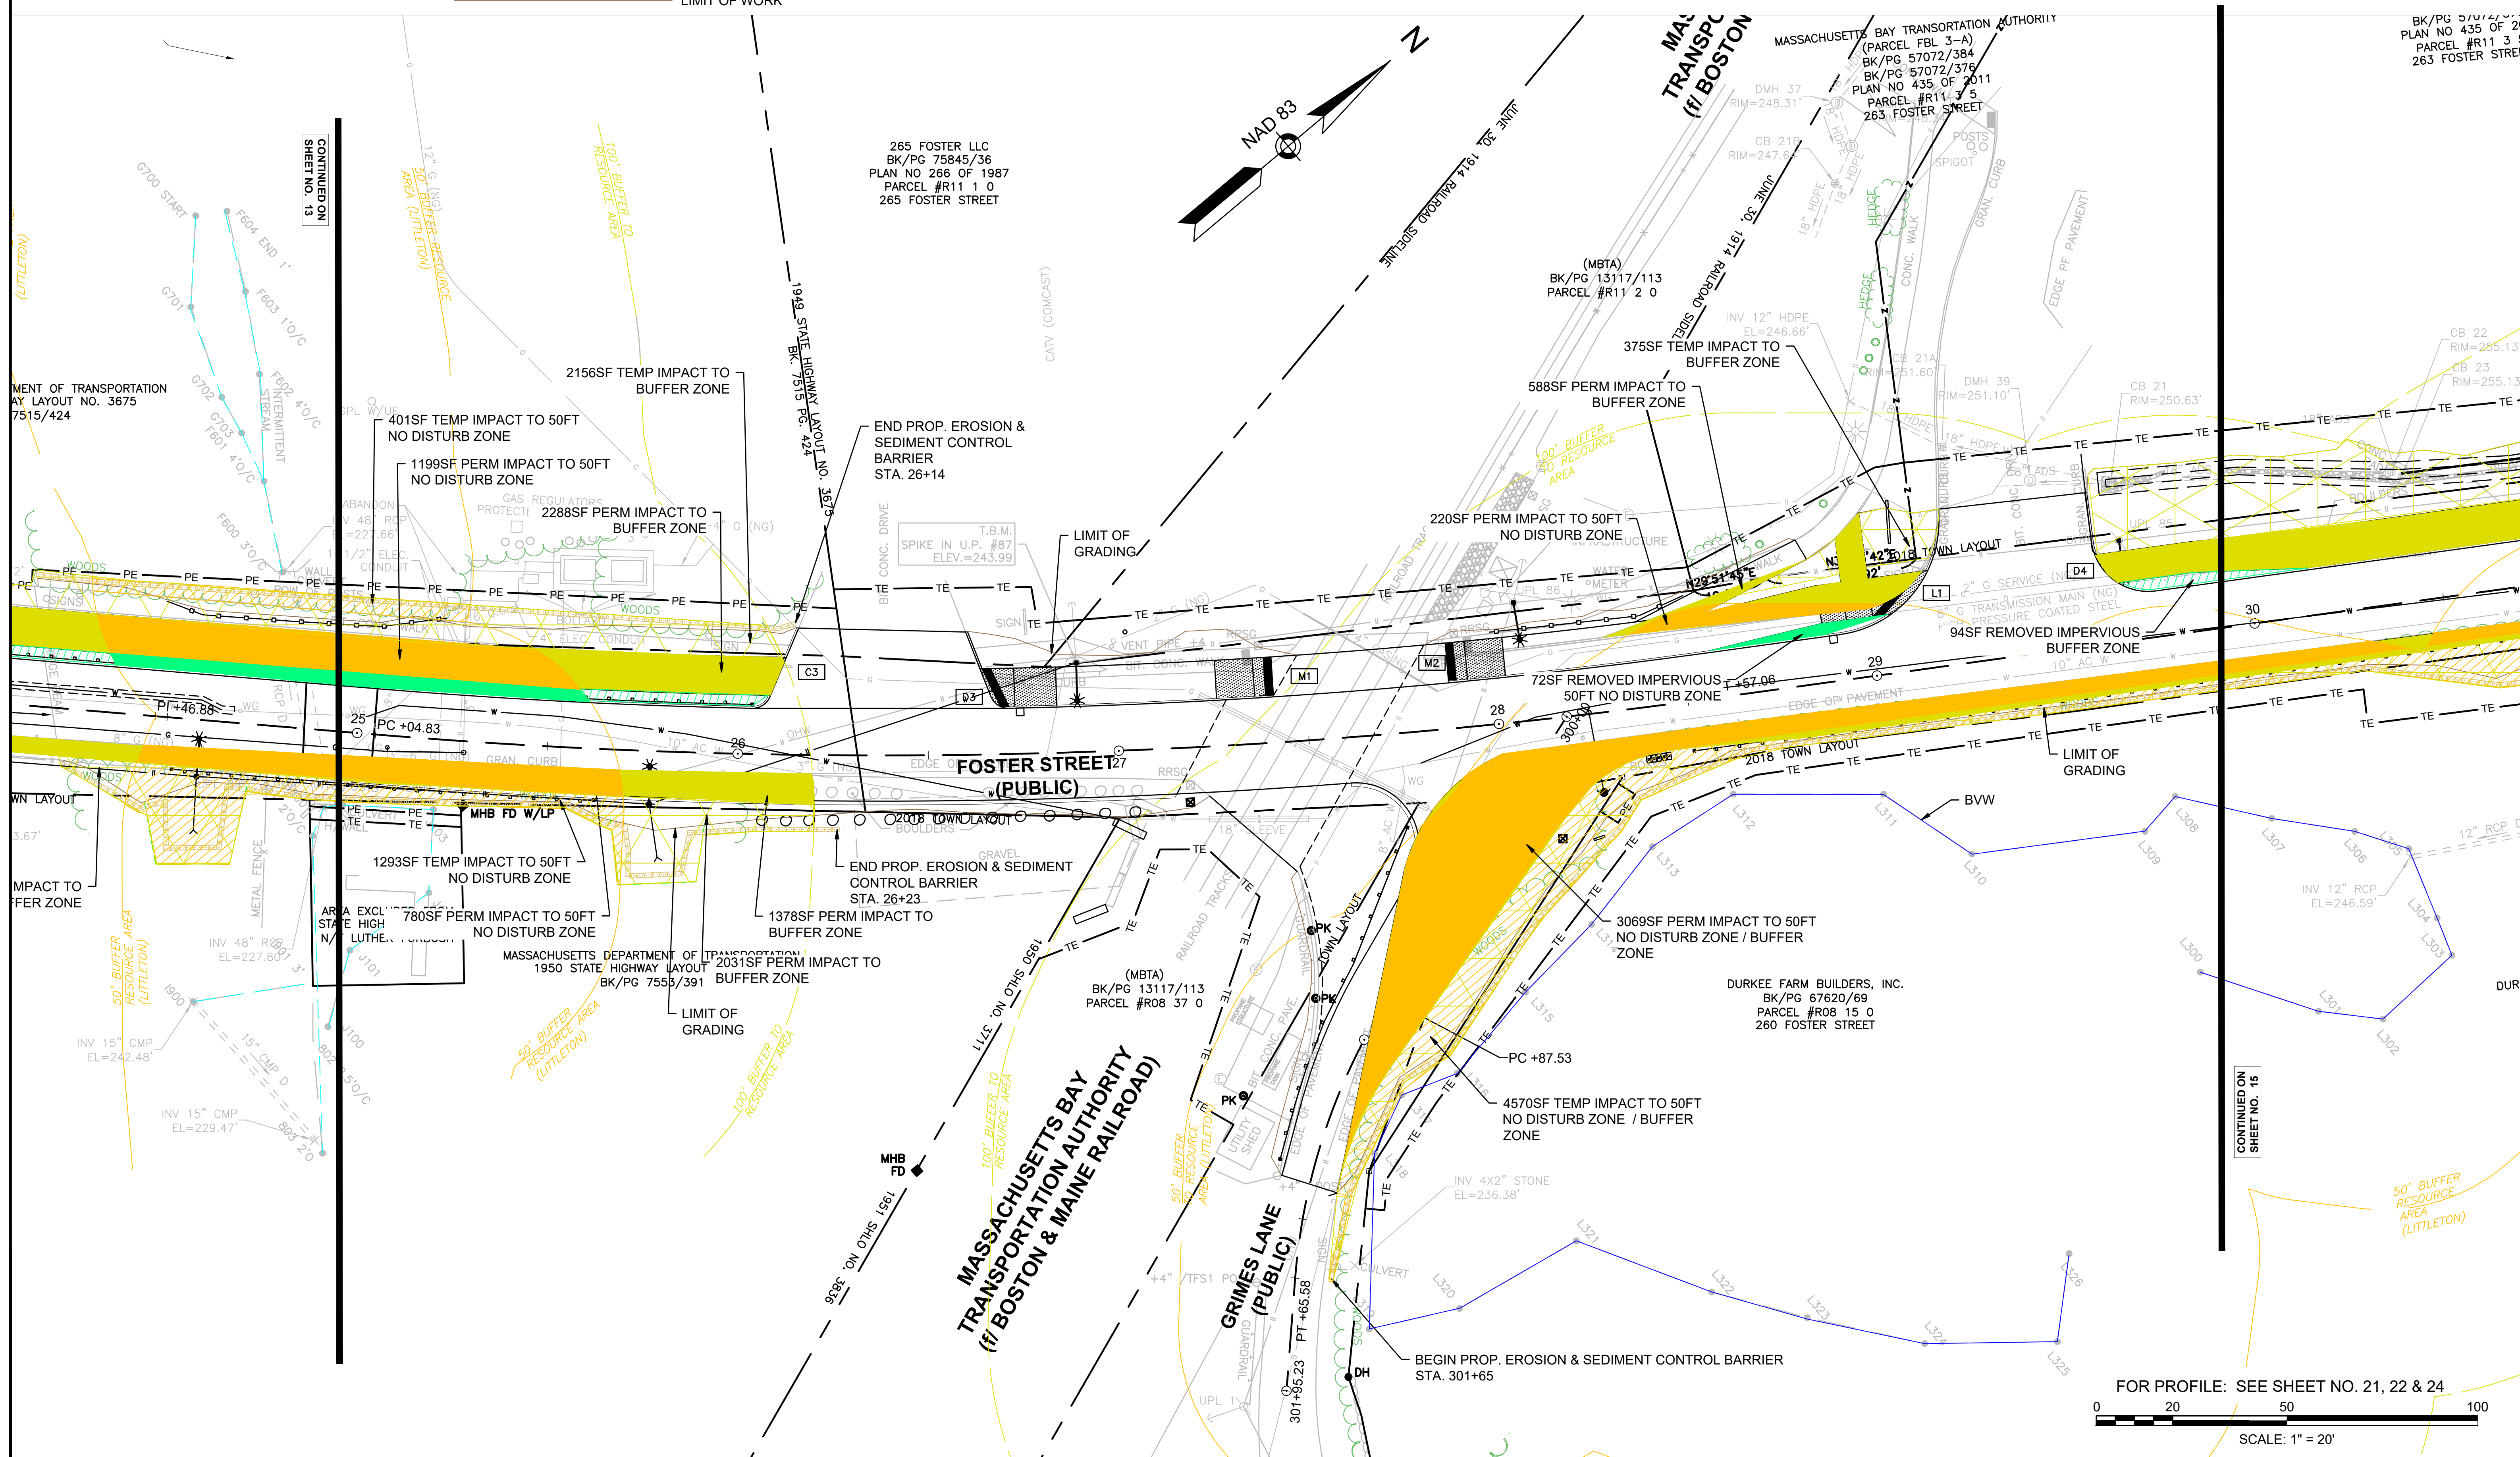

FOR PROFILE: SEE SHEET NO. 21, 22 & 24
SCALE: 1" = 20'


ENVIRONMENTAL PLANS LEGEND

- EXISTING TREE LINE
- PROPOSED TREE LINE
- BORDERING VEGETATED WETLANDS
- BANK/LAND UNDER WATER
- 100FT BUFFER from BVW or BANK
- 50FT NO DISTURB LIMIT from BVW or BANK
- EROSION CONTROLS
- LIMIT OF WORK
- PERM IMPACT TO BUFFER ZONE
- TEMP IMPACT TO BUFFER ZONE
- PERM IMPACT TO 50-FT NO DISTURB
- TEMP IMPACT TO 50-FT NO DISTURB
- IMPERVIOUS REMOVED FROM 50-FT NO DISTURB
- IMPERVIOUS REMOVED FROM BUFFER ZONE

LITTLETON RECONSTRUCTION OF FOSTER STREET

STATE	FED. AID PROJ. NO.	SHEET NO.	TOTAL SHEETS
MA	XXX-XXX(XXX)X	E7	129
PROJECT FILE NO.		609054	

ENVIRONMENTAL PLANS

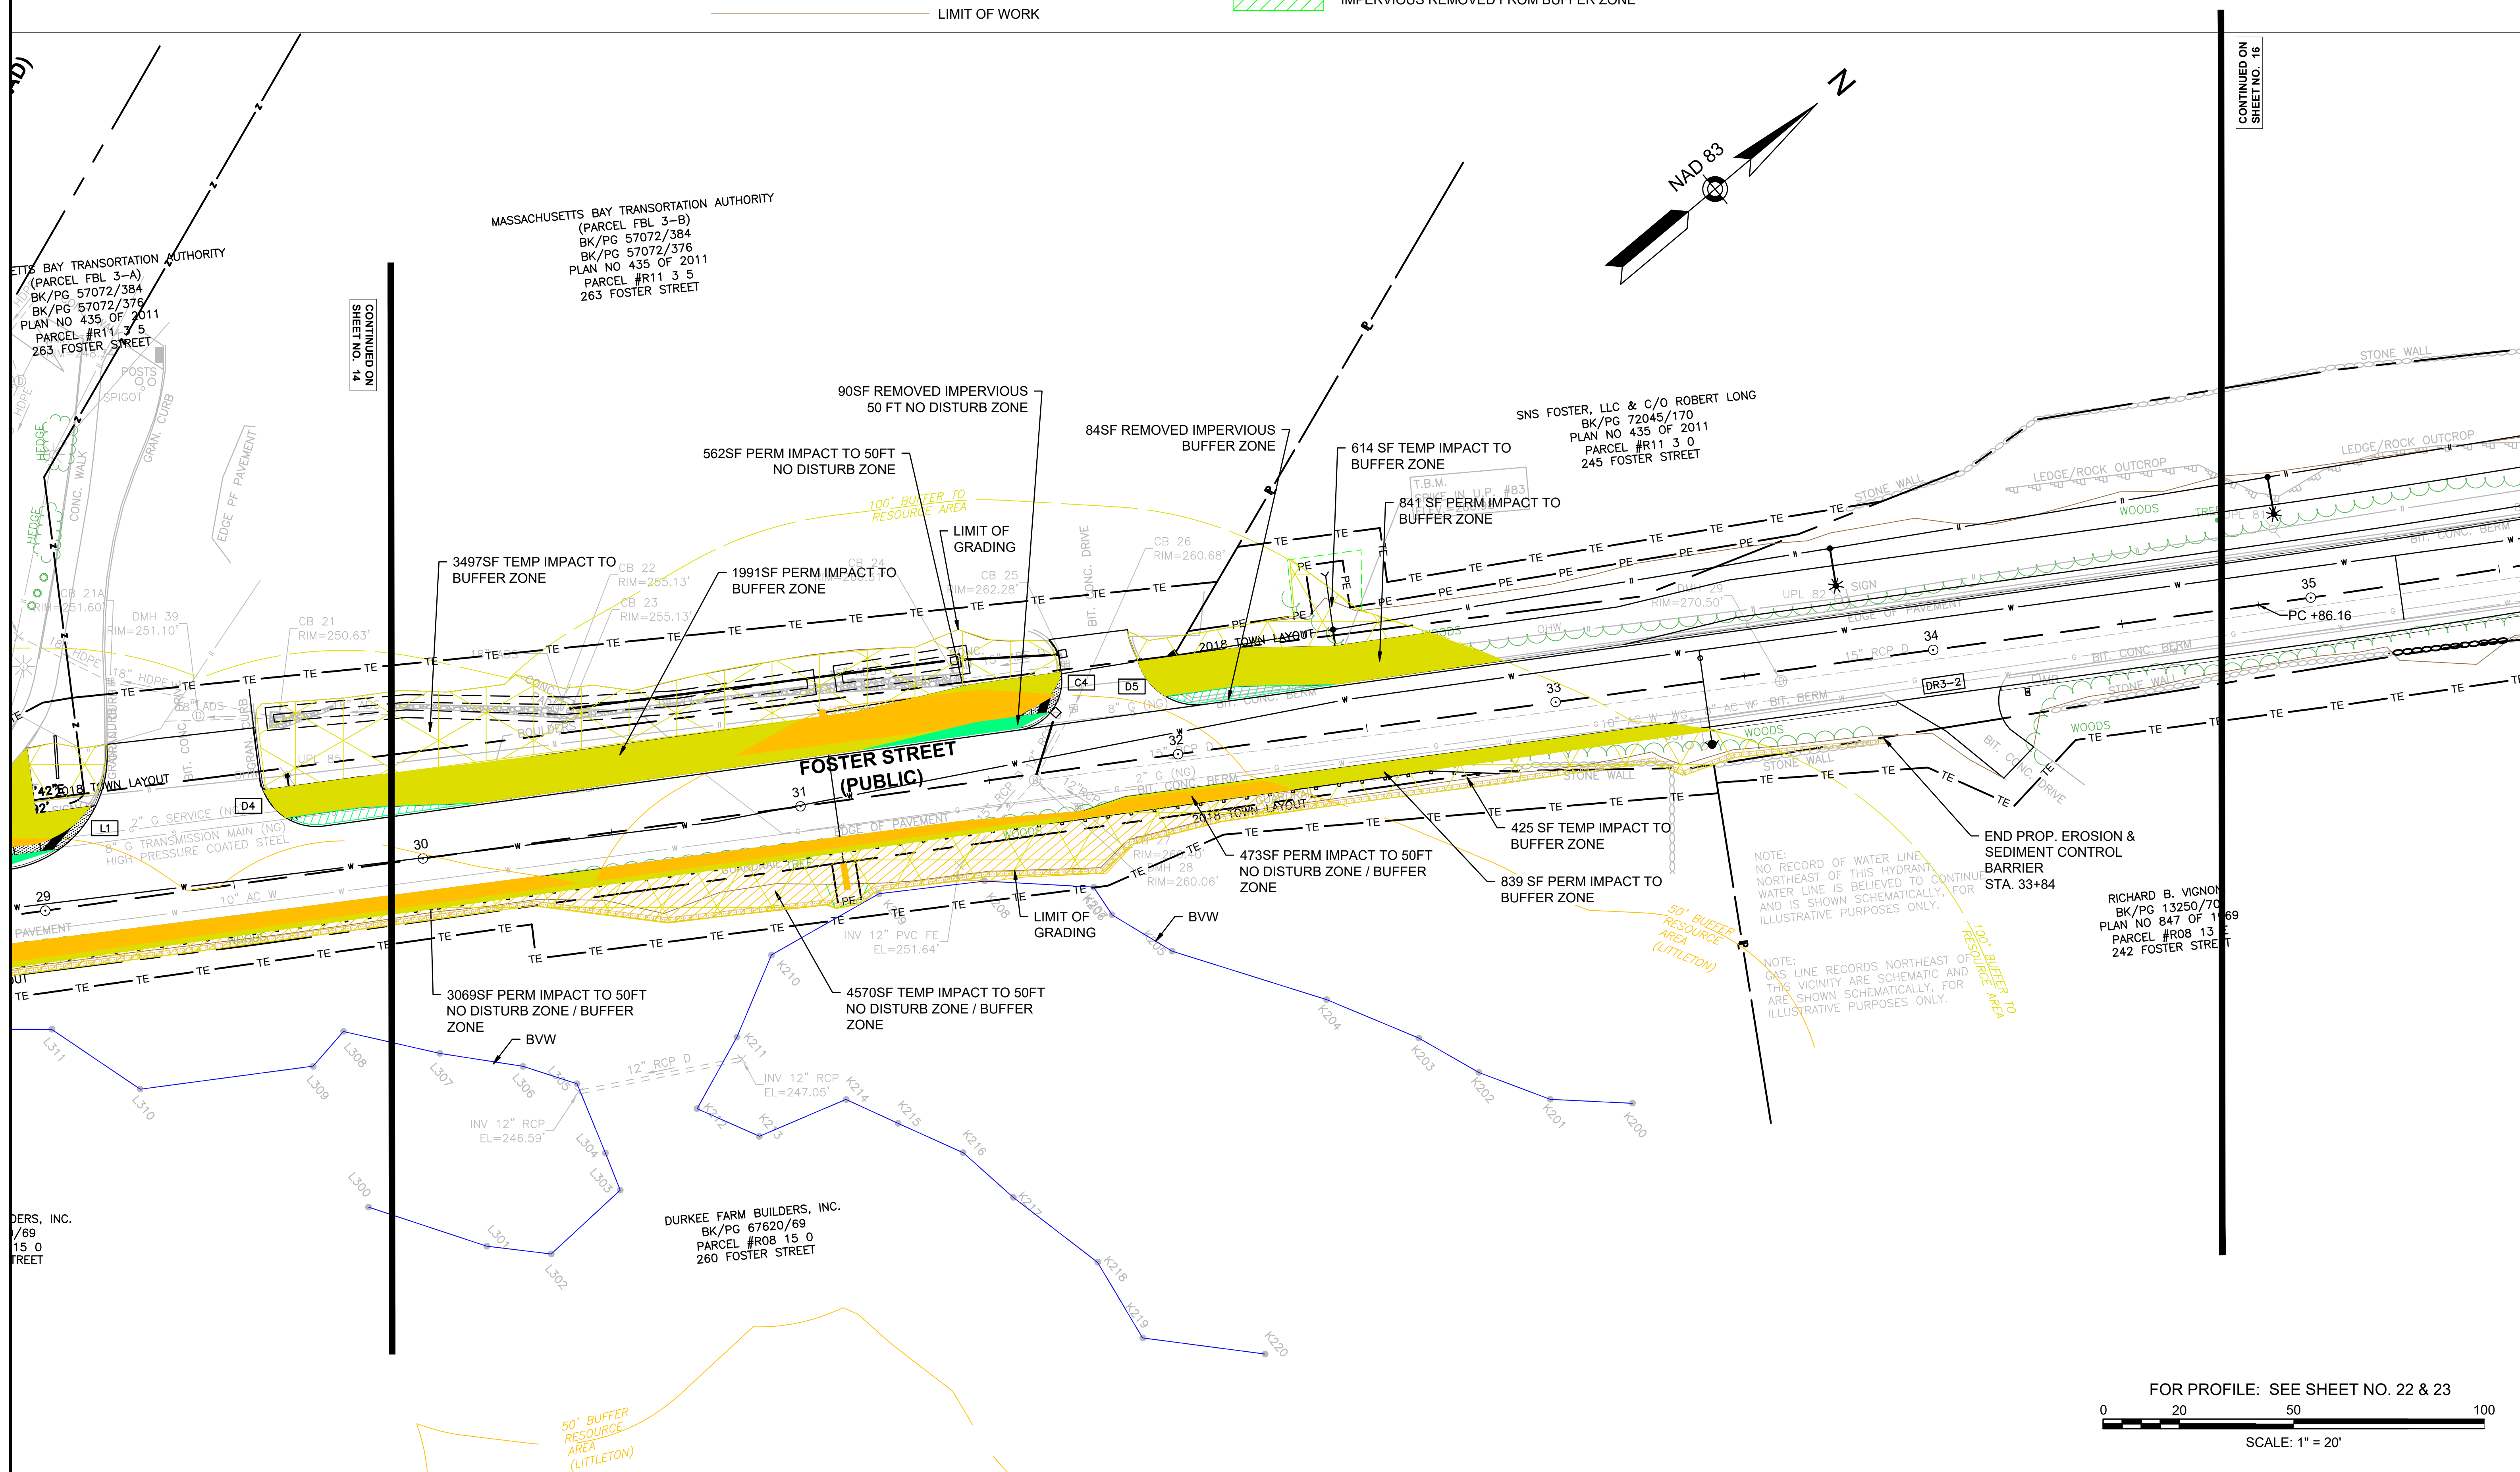

ENVIRONMENTAL PLANS LEGEND

EXISTING TREE LINE

PROPOSED TREE LINE

BORDERING VEGETATED WETLANDS

BANK/LAND UNDER WATER

100FT BUFFER from BVW or BANK

50FT NO DISTURB LIMIT from BVW or BANK

EROSION CONTROLS

LIMIT OF WORK

PERM IMPACT TO BUFFER ZONE

TEMP IMPACT TO BUFFER ZONE

PERM IMPACT TO 50-FT NO DISTURB

TEMP IMPACT TO 50-FT NO DISTURB

IMPERVIOUS REMOVED FROM 50-FT NO DISTURB

IMPERVIOUS REMOVED FROM BUFFER ZONE

LITTLETON
RECONSTRUCTION OF FOSTER STREET

STATE	FED. AID PROJ. NO.	SHEET NO.	TOTAL SHEETS
MA	XXX-XXX(XXX)X	E8	129
PROJECT FILE NO. 609054			

ENVIRONMENTAL PLANS

The plan view shows Foster Street (Public) running horizontally across the middle. To the north (top) are property lots with owners: SNS FOSTER, LLC & C/O ROBERT LONG (Parcel #R11 3 0, 245 Foster Street), PATRICIA A. NARGIZIAN (Parcel #R11 5 4, 237 Foster Street), and QUINN E. & JENNIFER A. CANFIELD (Parcel #R08 13 D, 238 Foster Street). To the south (bottom) is Richard B. Vignoni (Parcel #R08 13 E, 242 Foster Street). The plan includes various features: stone walls, ledge/rock outcrops, bit. conc. berms, and erosion controls. Environmental features include existing and proposed tree lines, wooded areas, and a landscaped area. Engineering notes specify limits of grading and work. Stationing is marked along the street, including PC+86.16, PT+90.37, PC+06.15, and STA. 39+36.15. A north arrow points towards the top right. A scale bar at the bottom right indicates 1" = 20'.



20170044A21_LHPN01 RDA SET.DWG Plotted on 19-Apr-2023 2:50 AM

LITTLETON
RECONSTRUCTION OF FOSTER STREET

STATE	FED. AID PROJ. NO.	SHEET NO.	TOTAL SHEETS
MA	XXX-XXXX(XXX)X	17	129
PROJECT FILE NO.			609054

PROFILE - FOSTER STREET


FOR CONSTRUCTION PLANS:
SEE SHEET NOS. 9-16

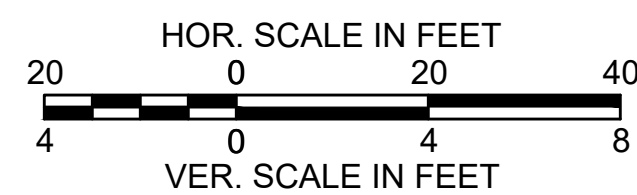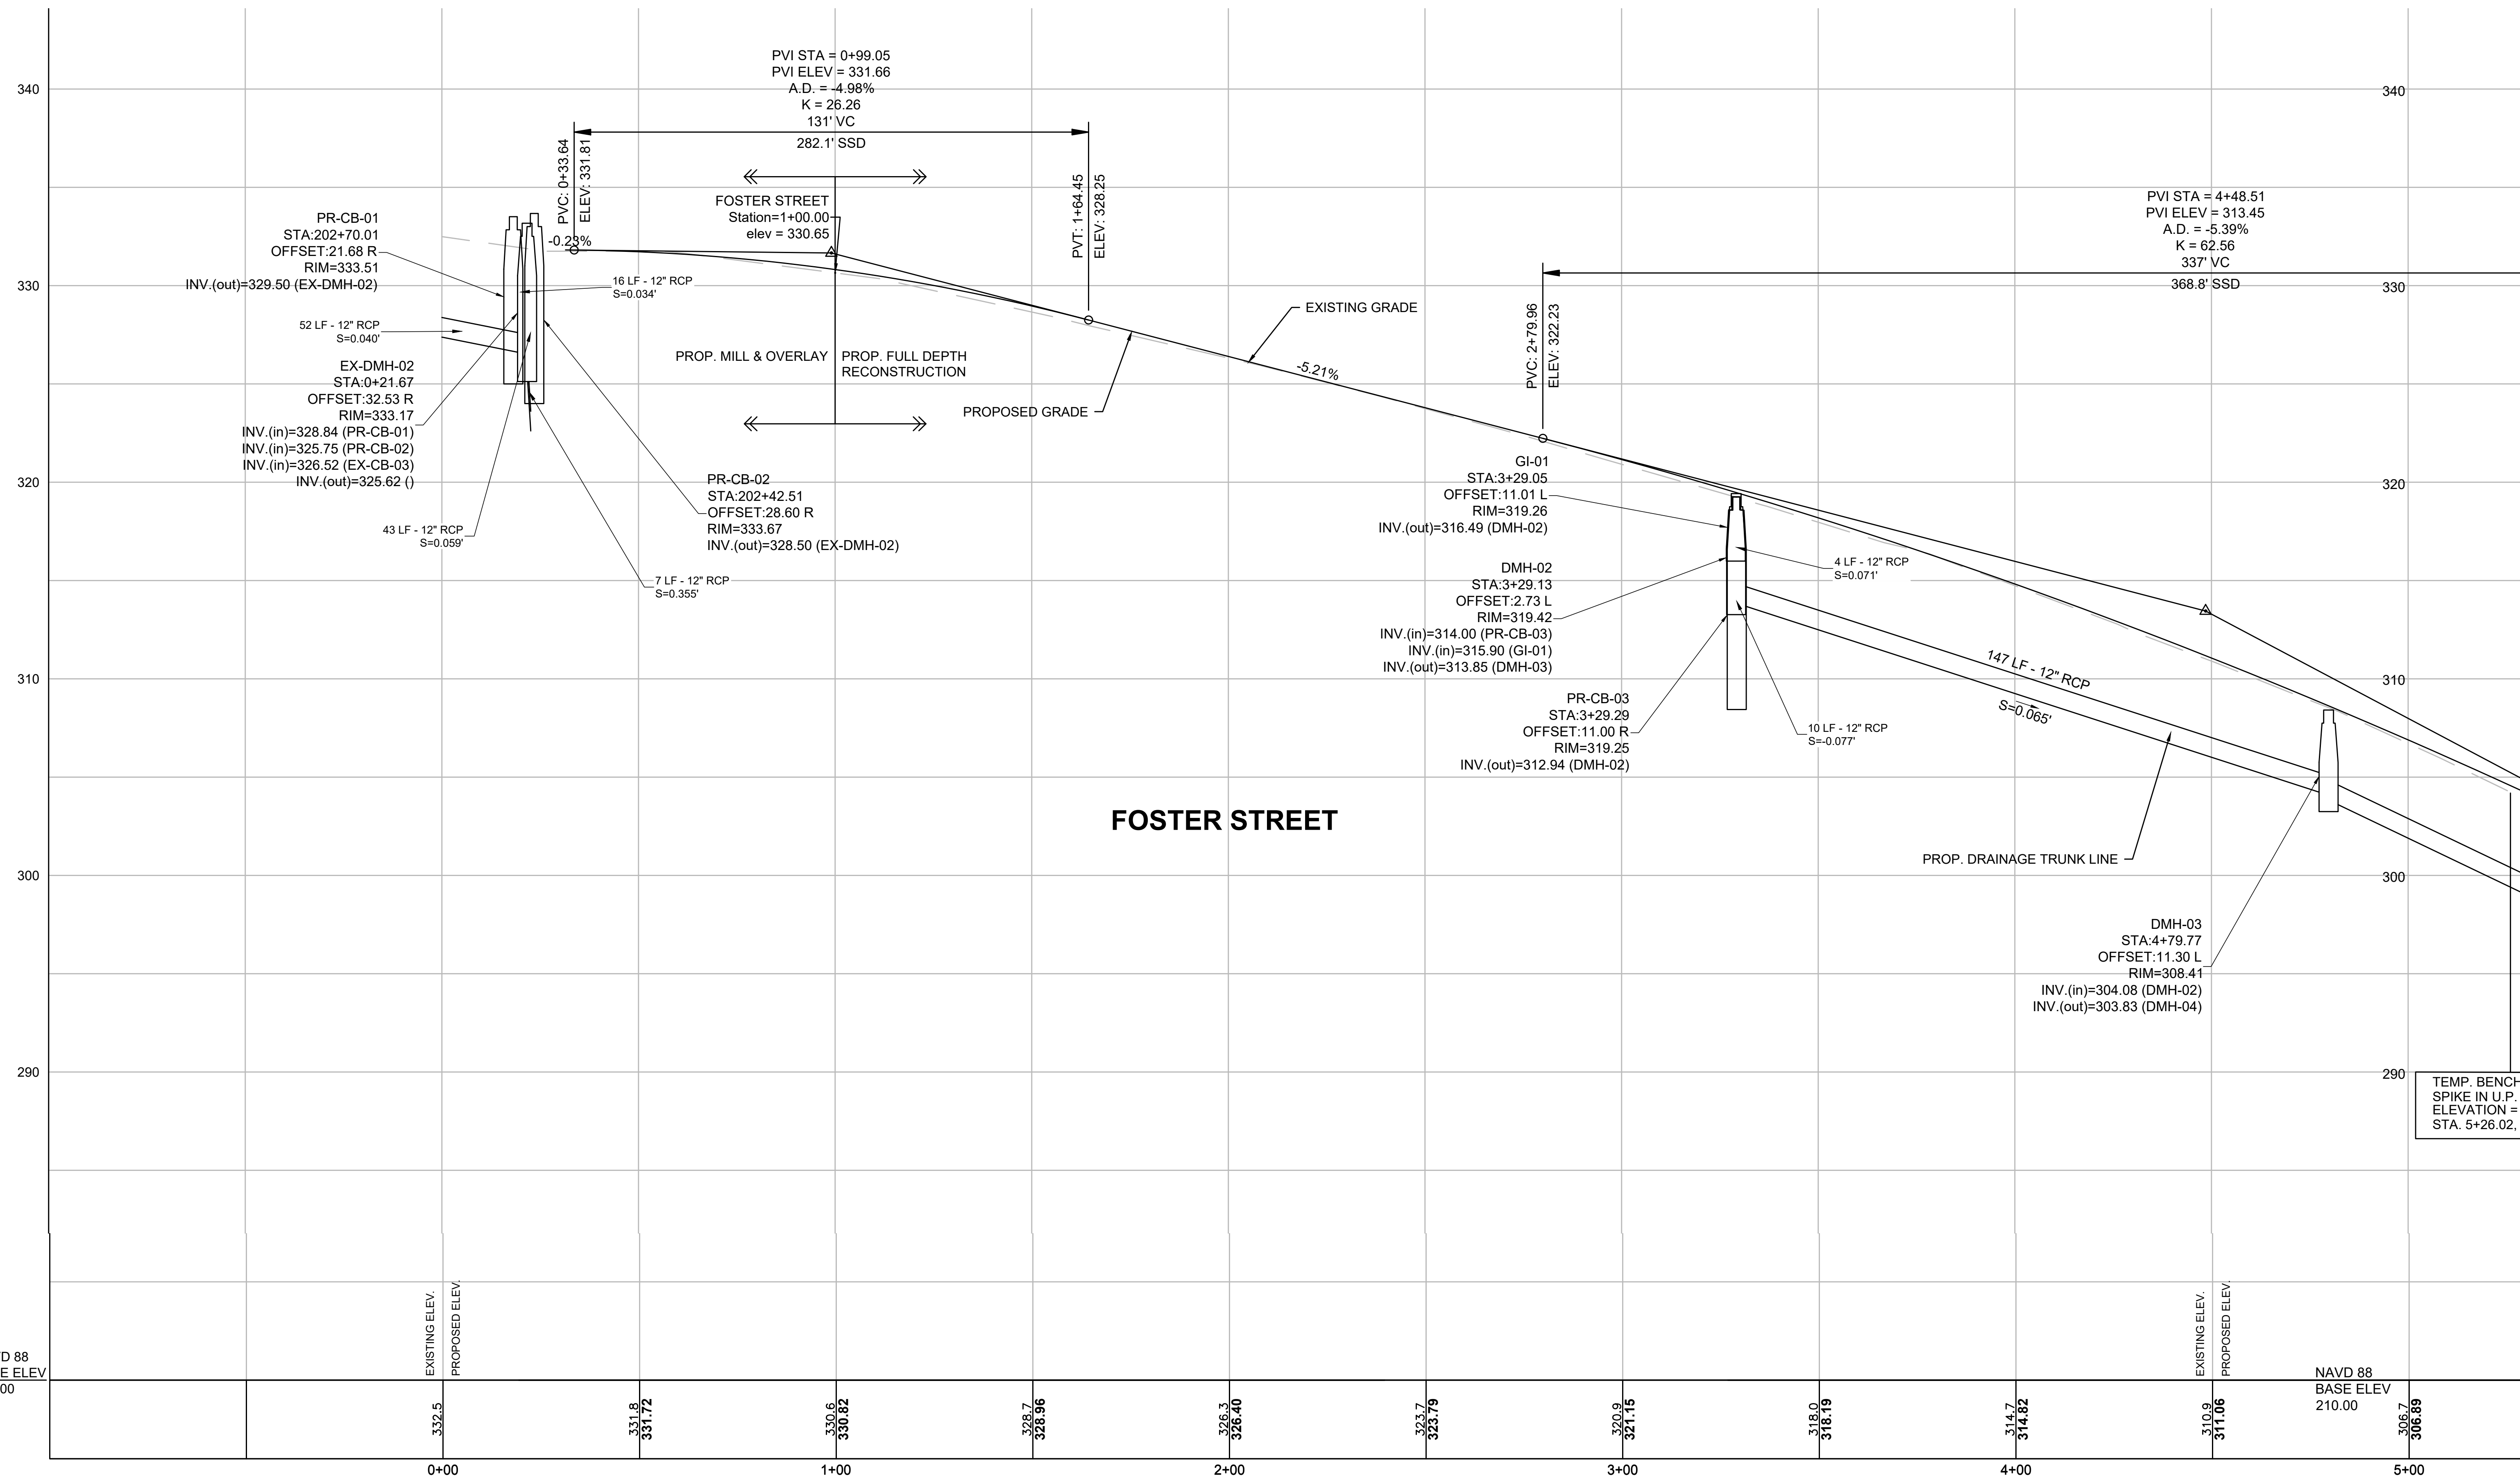

LITTLETON
RECONSTRUCTION OF FOSTER STREET

STATE	FED. AID PROJ. NO.	SHEET NO.	TOTAL SHEETS
MA	XXX-XXX(XXX)X	18	129
PROJECT FILE NO.		609054	


PROFILE - FOSTER STREET

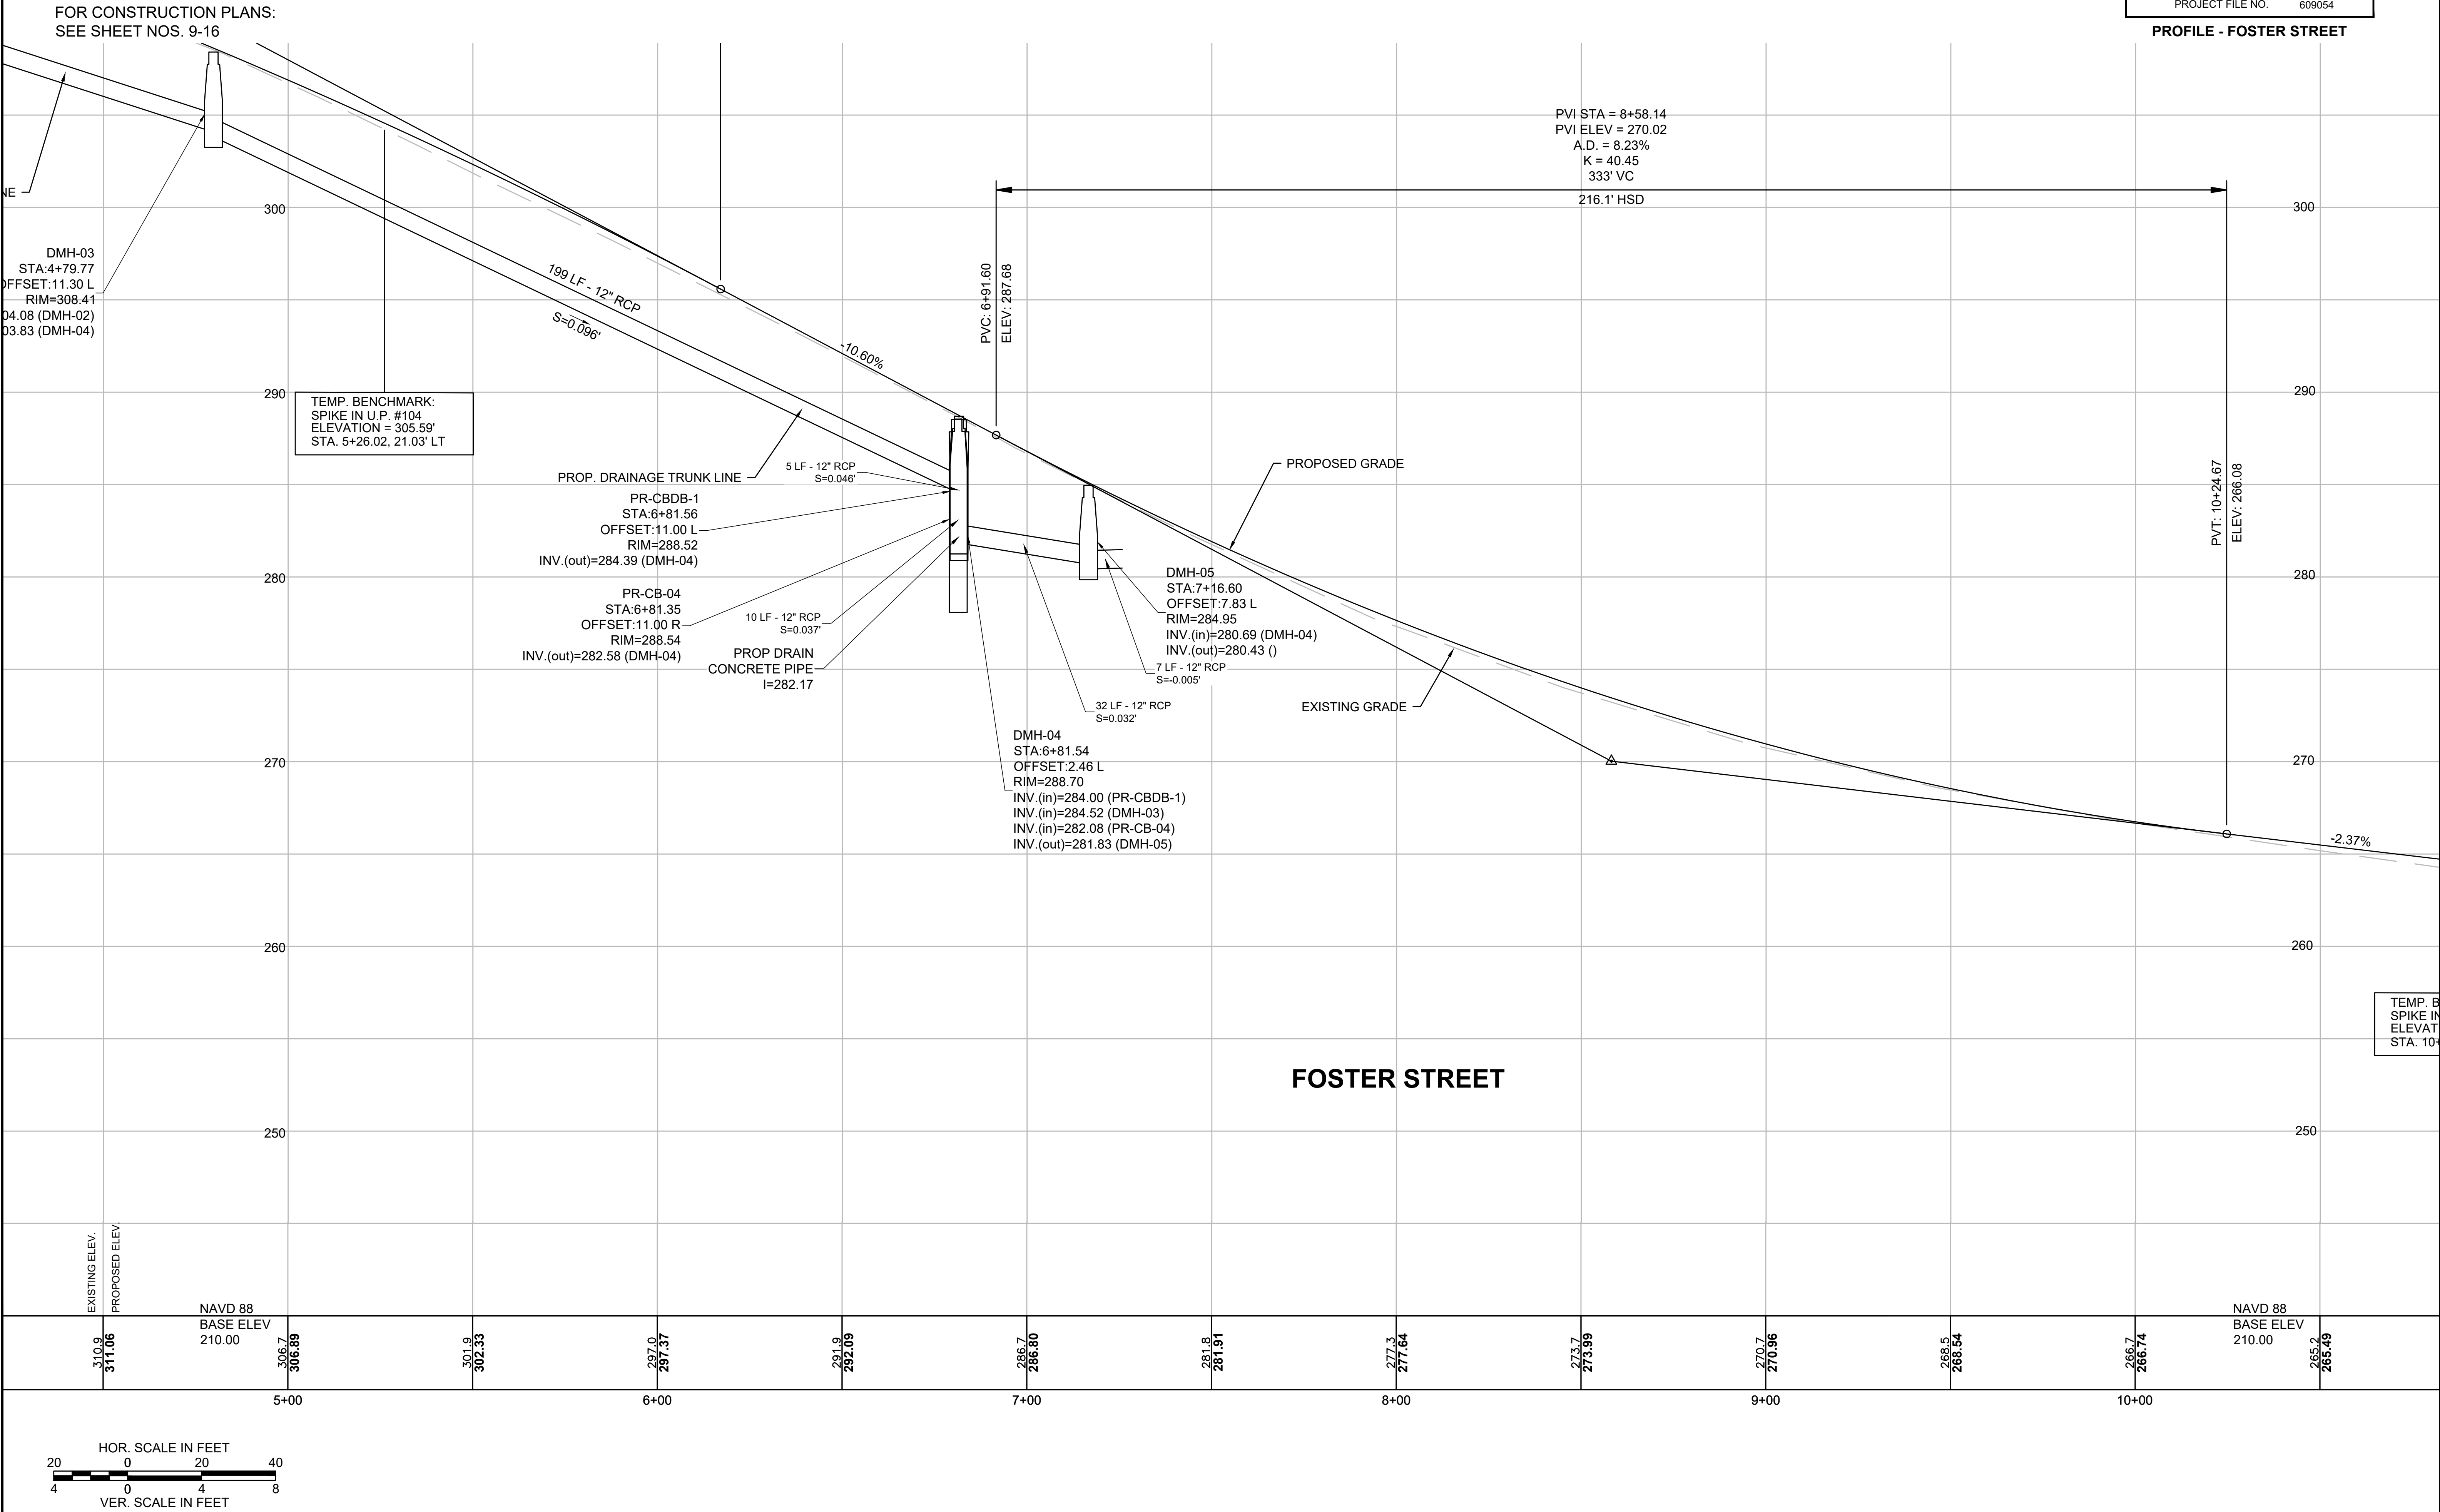

LITTLETON
RECONSTRUCTION OF FOSTER STREET

STATE	FED. AID PROJ. NO.	SHEET NO.	TOTAL SHEETS
MA	XXX-XXX(XXX)X	19	129
PROJECT FILE NO.		609054	


PROFILE - FOSTER STREET

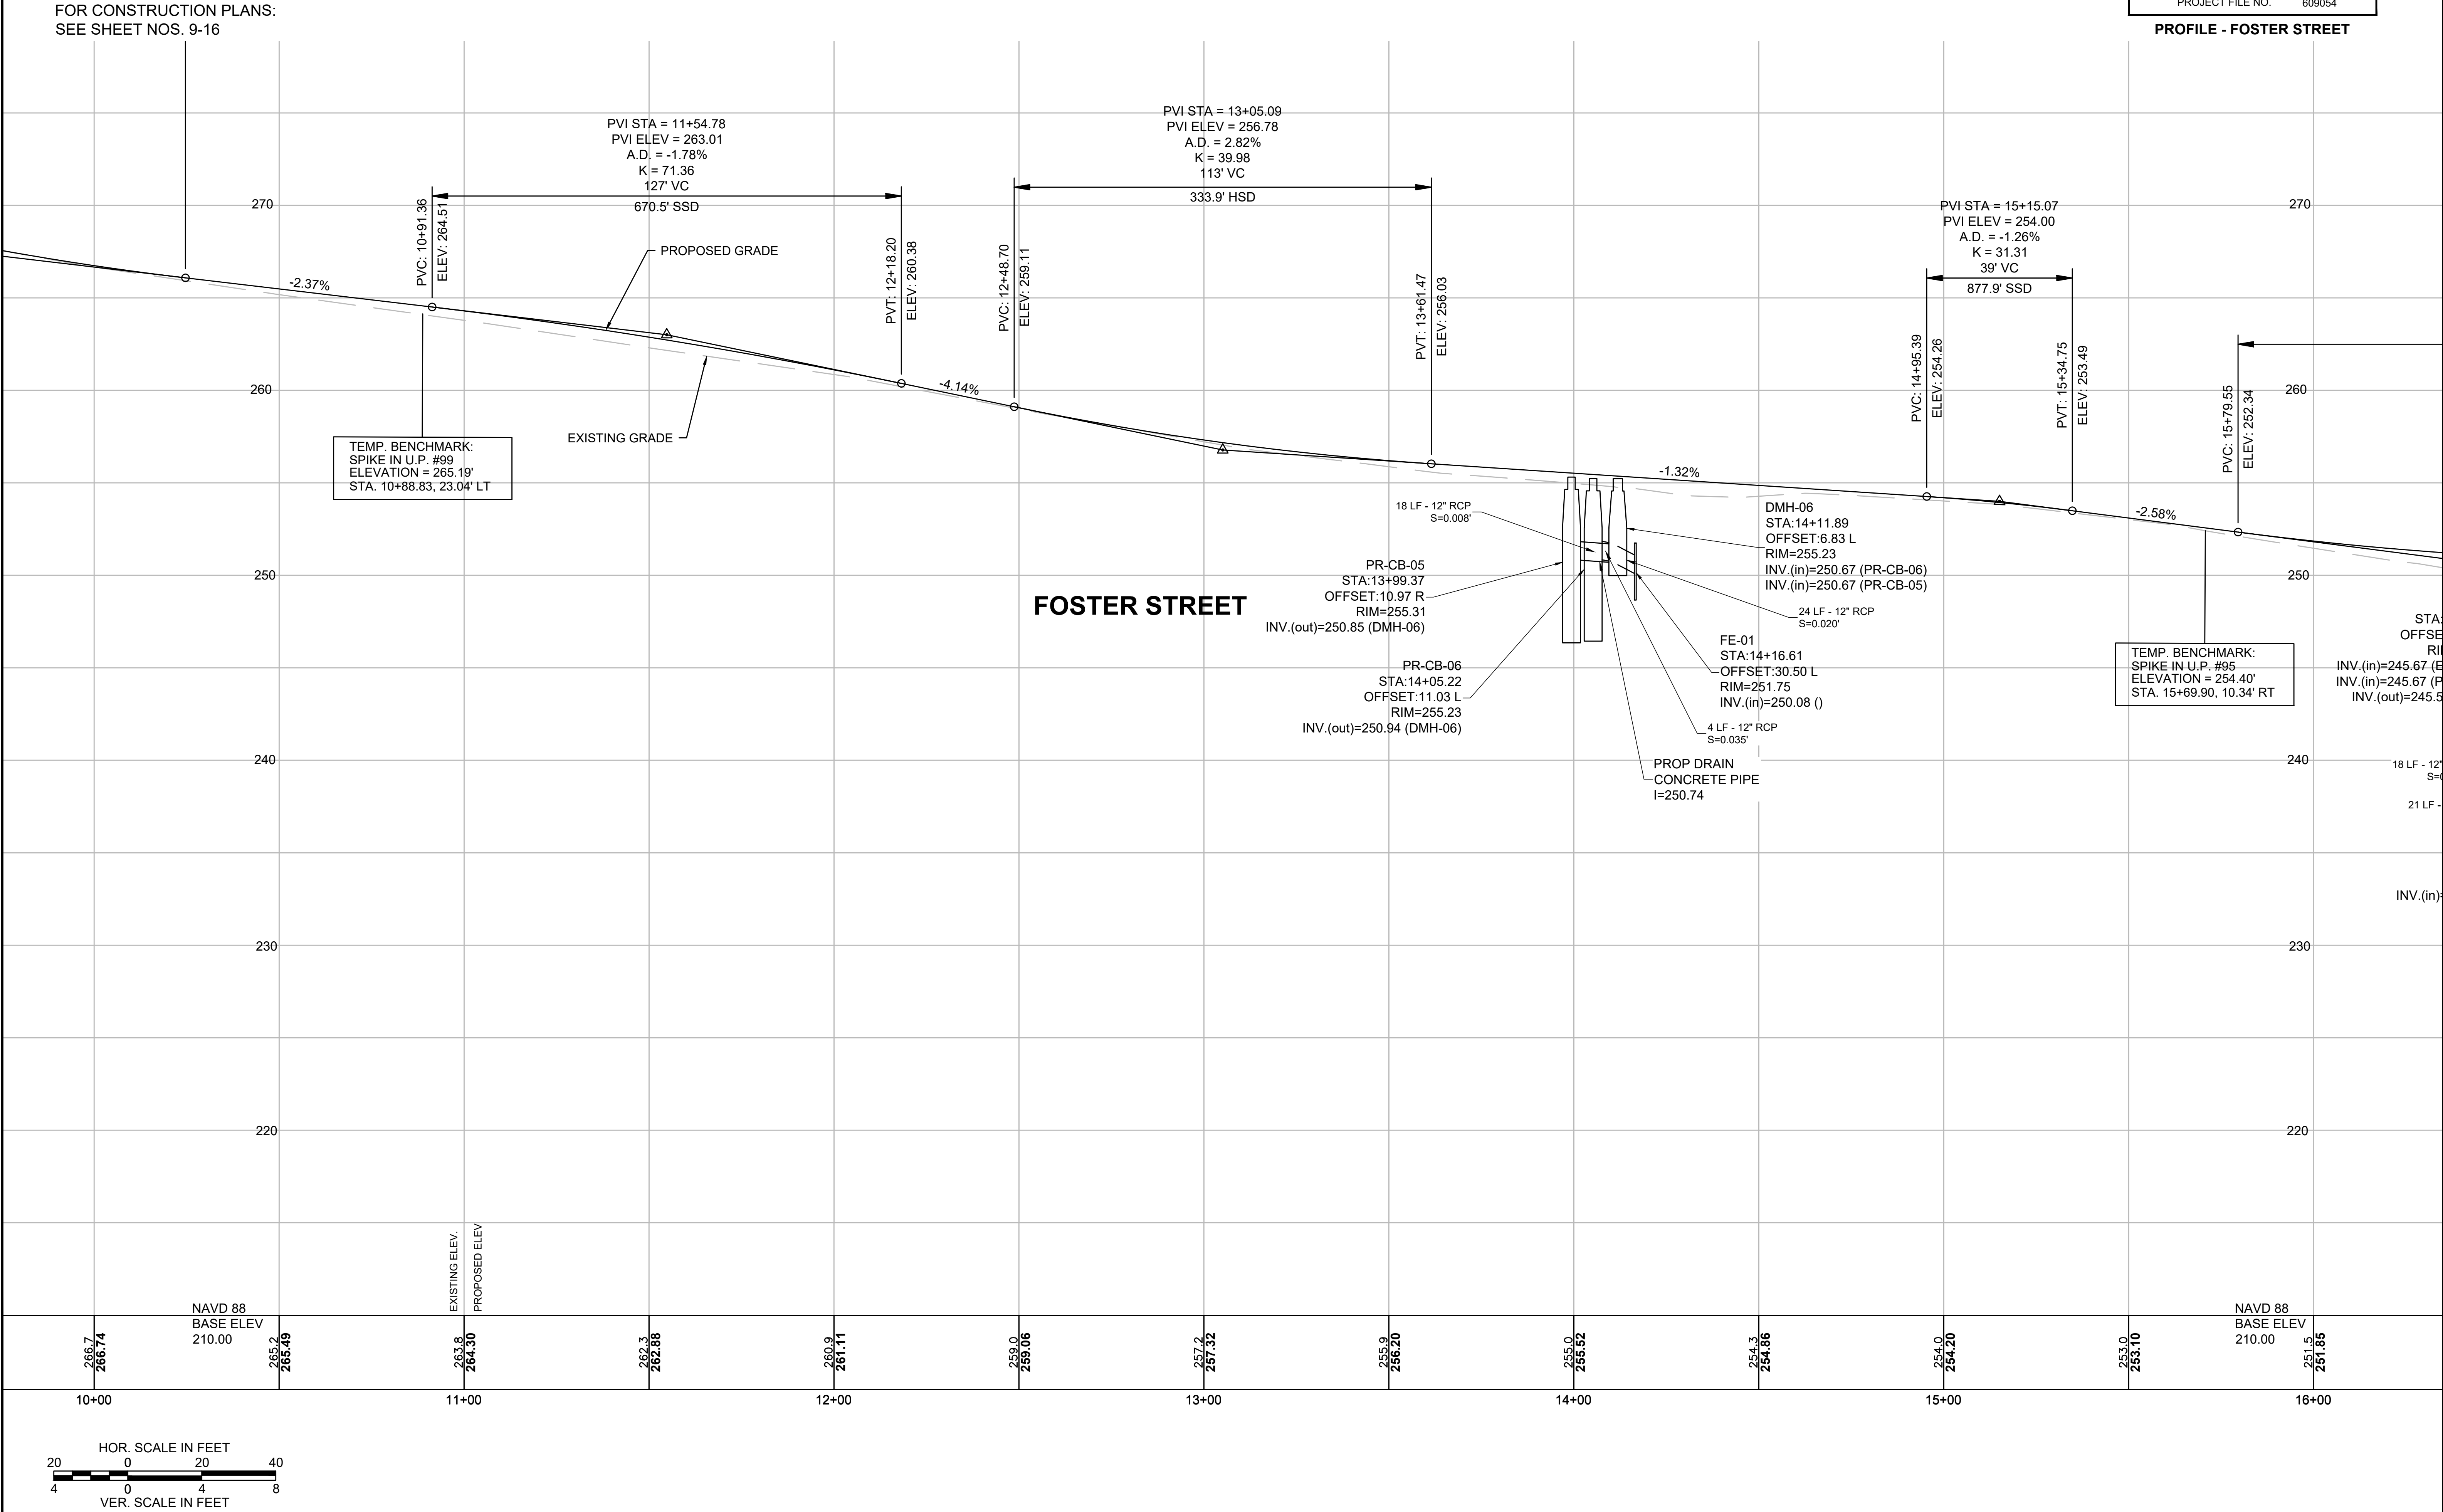

LITTLETON
RECONSTRUCTION OF FOSTER STREET

STATE	FED. AID PROJ. NO.	SHEET NO.	TOTAL SHEETS
MA	XXX-XXXX(XXX)X	20	129
PROJECT FILE NO.		609054	



PROFILE - FOSTER STREET

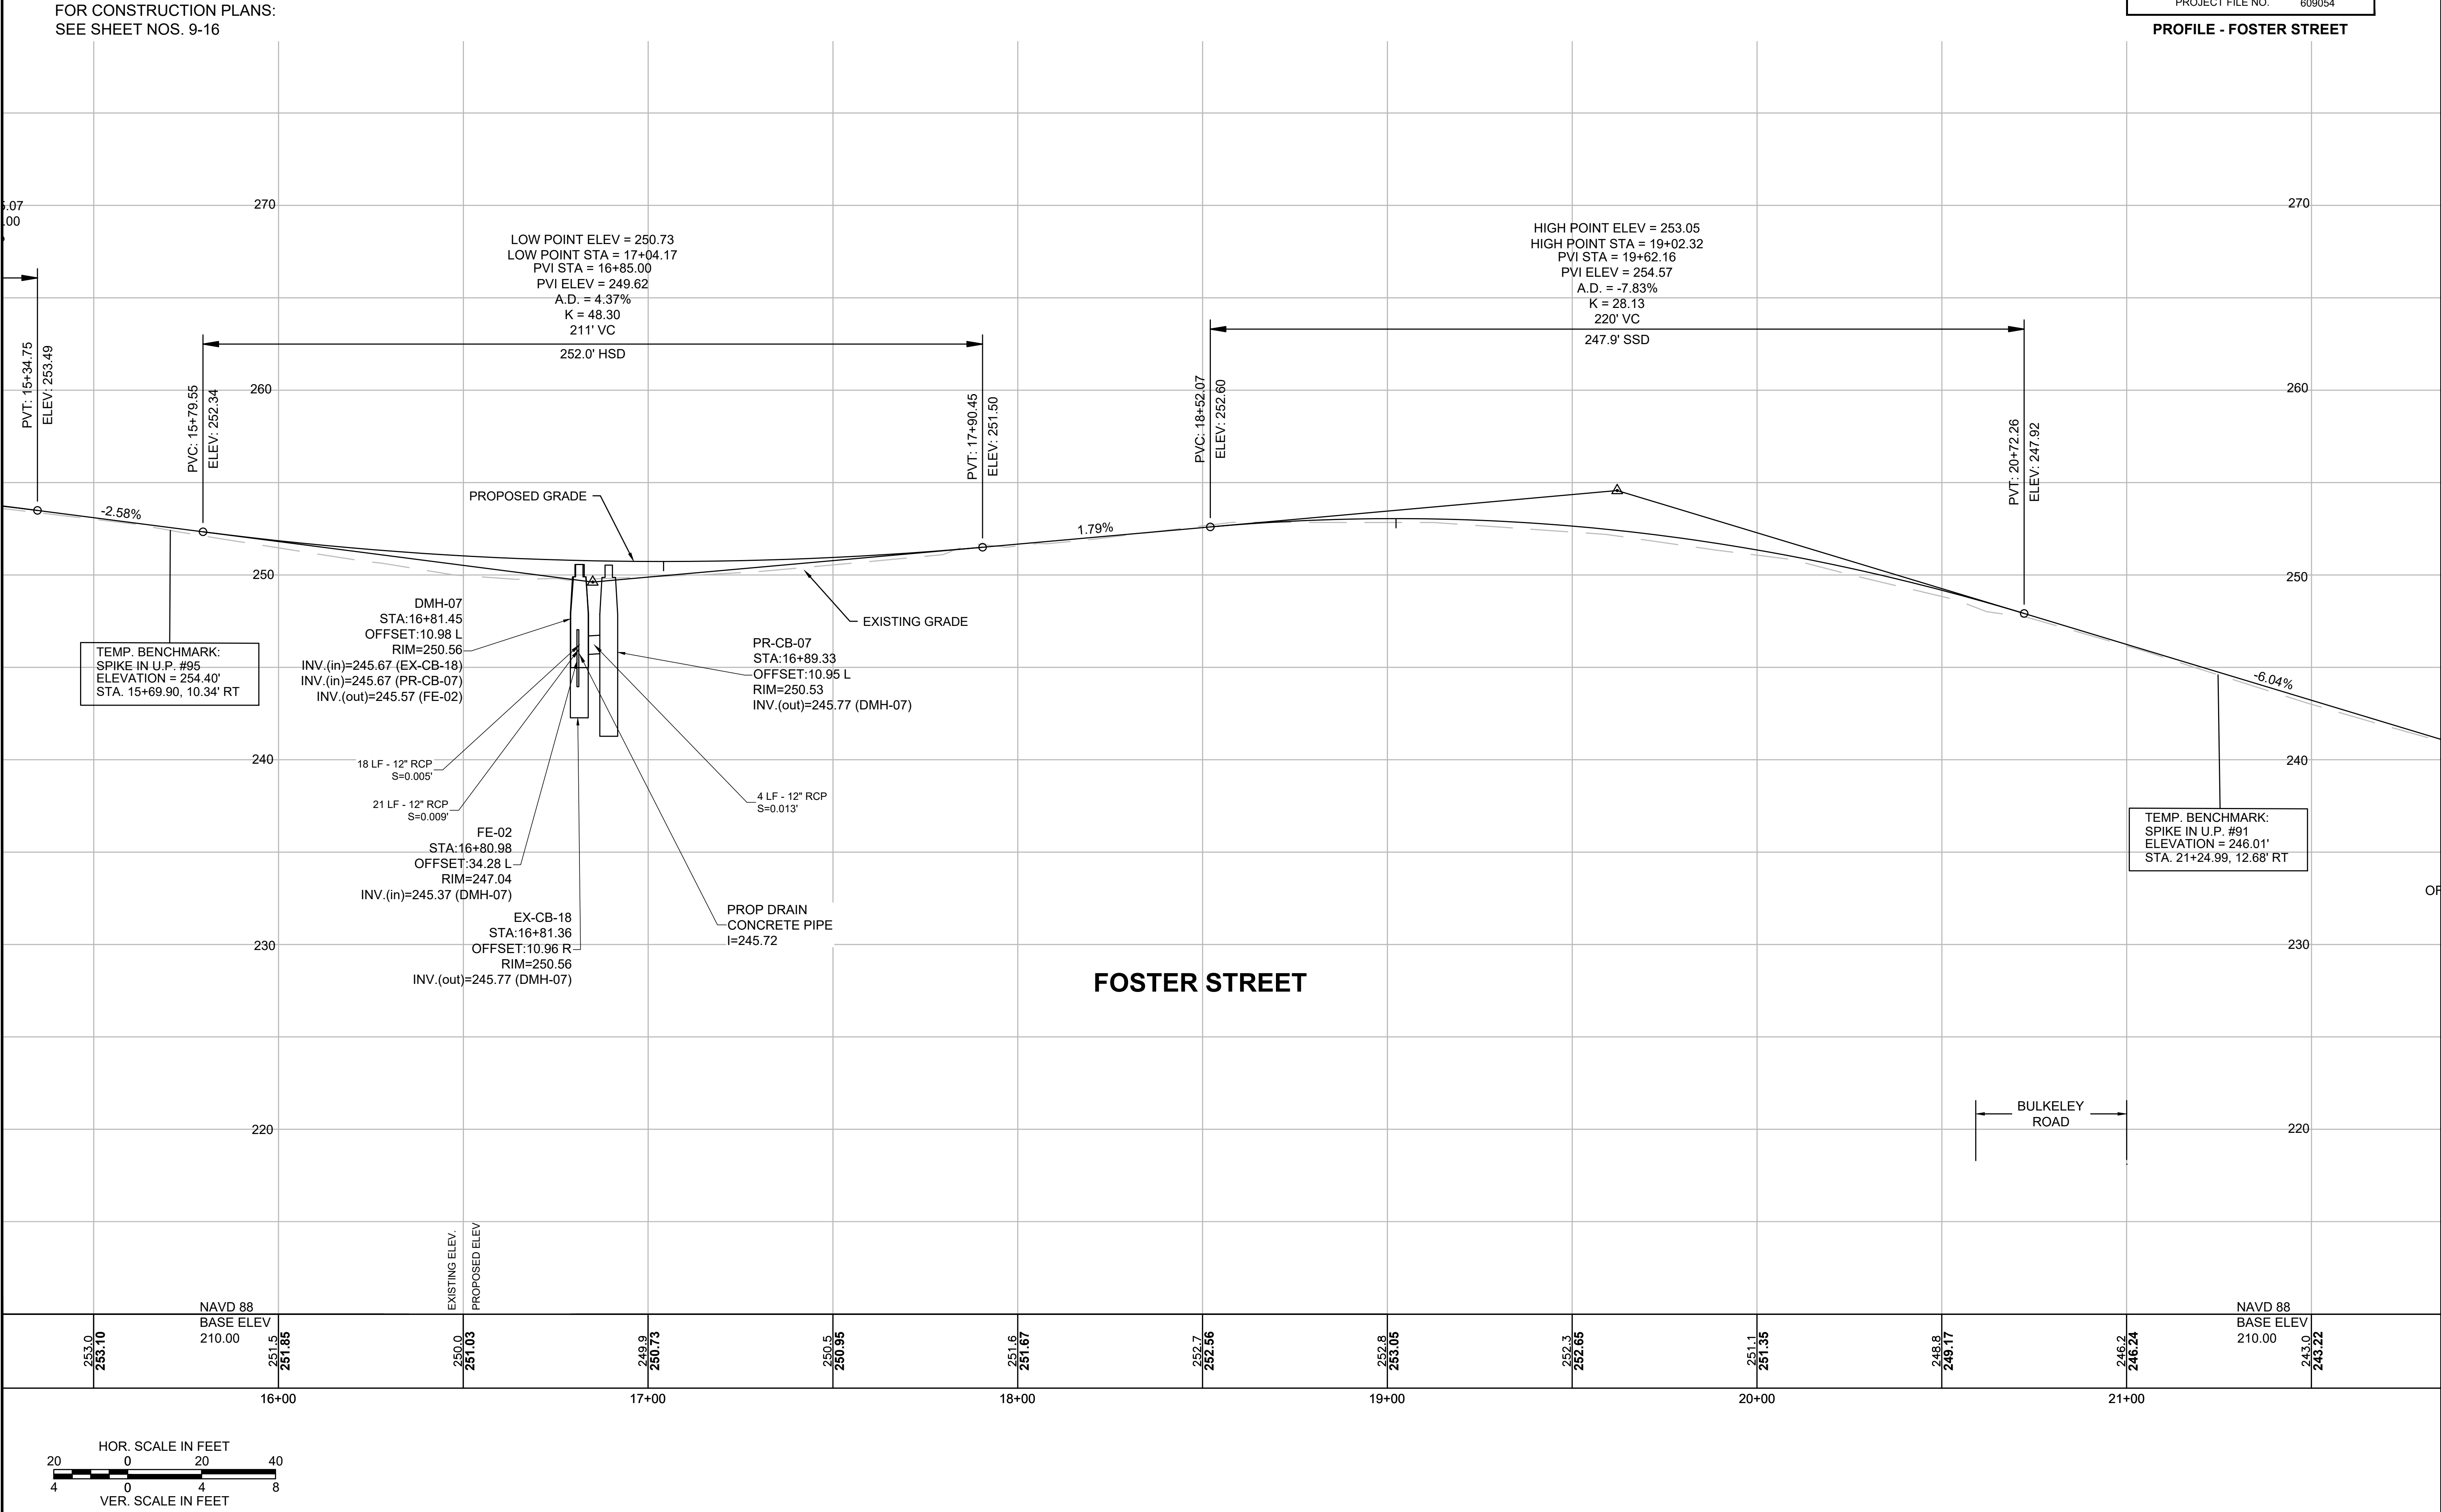

LITTLETON
RECONSTRUCTION OF FOSTER STREET

STATE	FED. AID PROJ. NO.	SHEET NO.	TOTAL SHEETS
MA	XXX-XXXX(XXX)X	21	129
PROJECT FILE NO.		609054	

PROFILE - FOSTER STREET

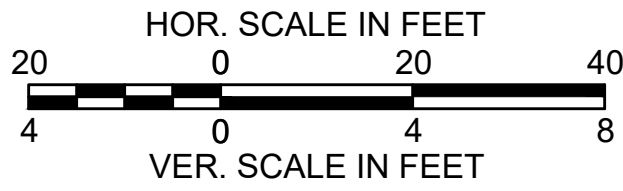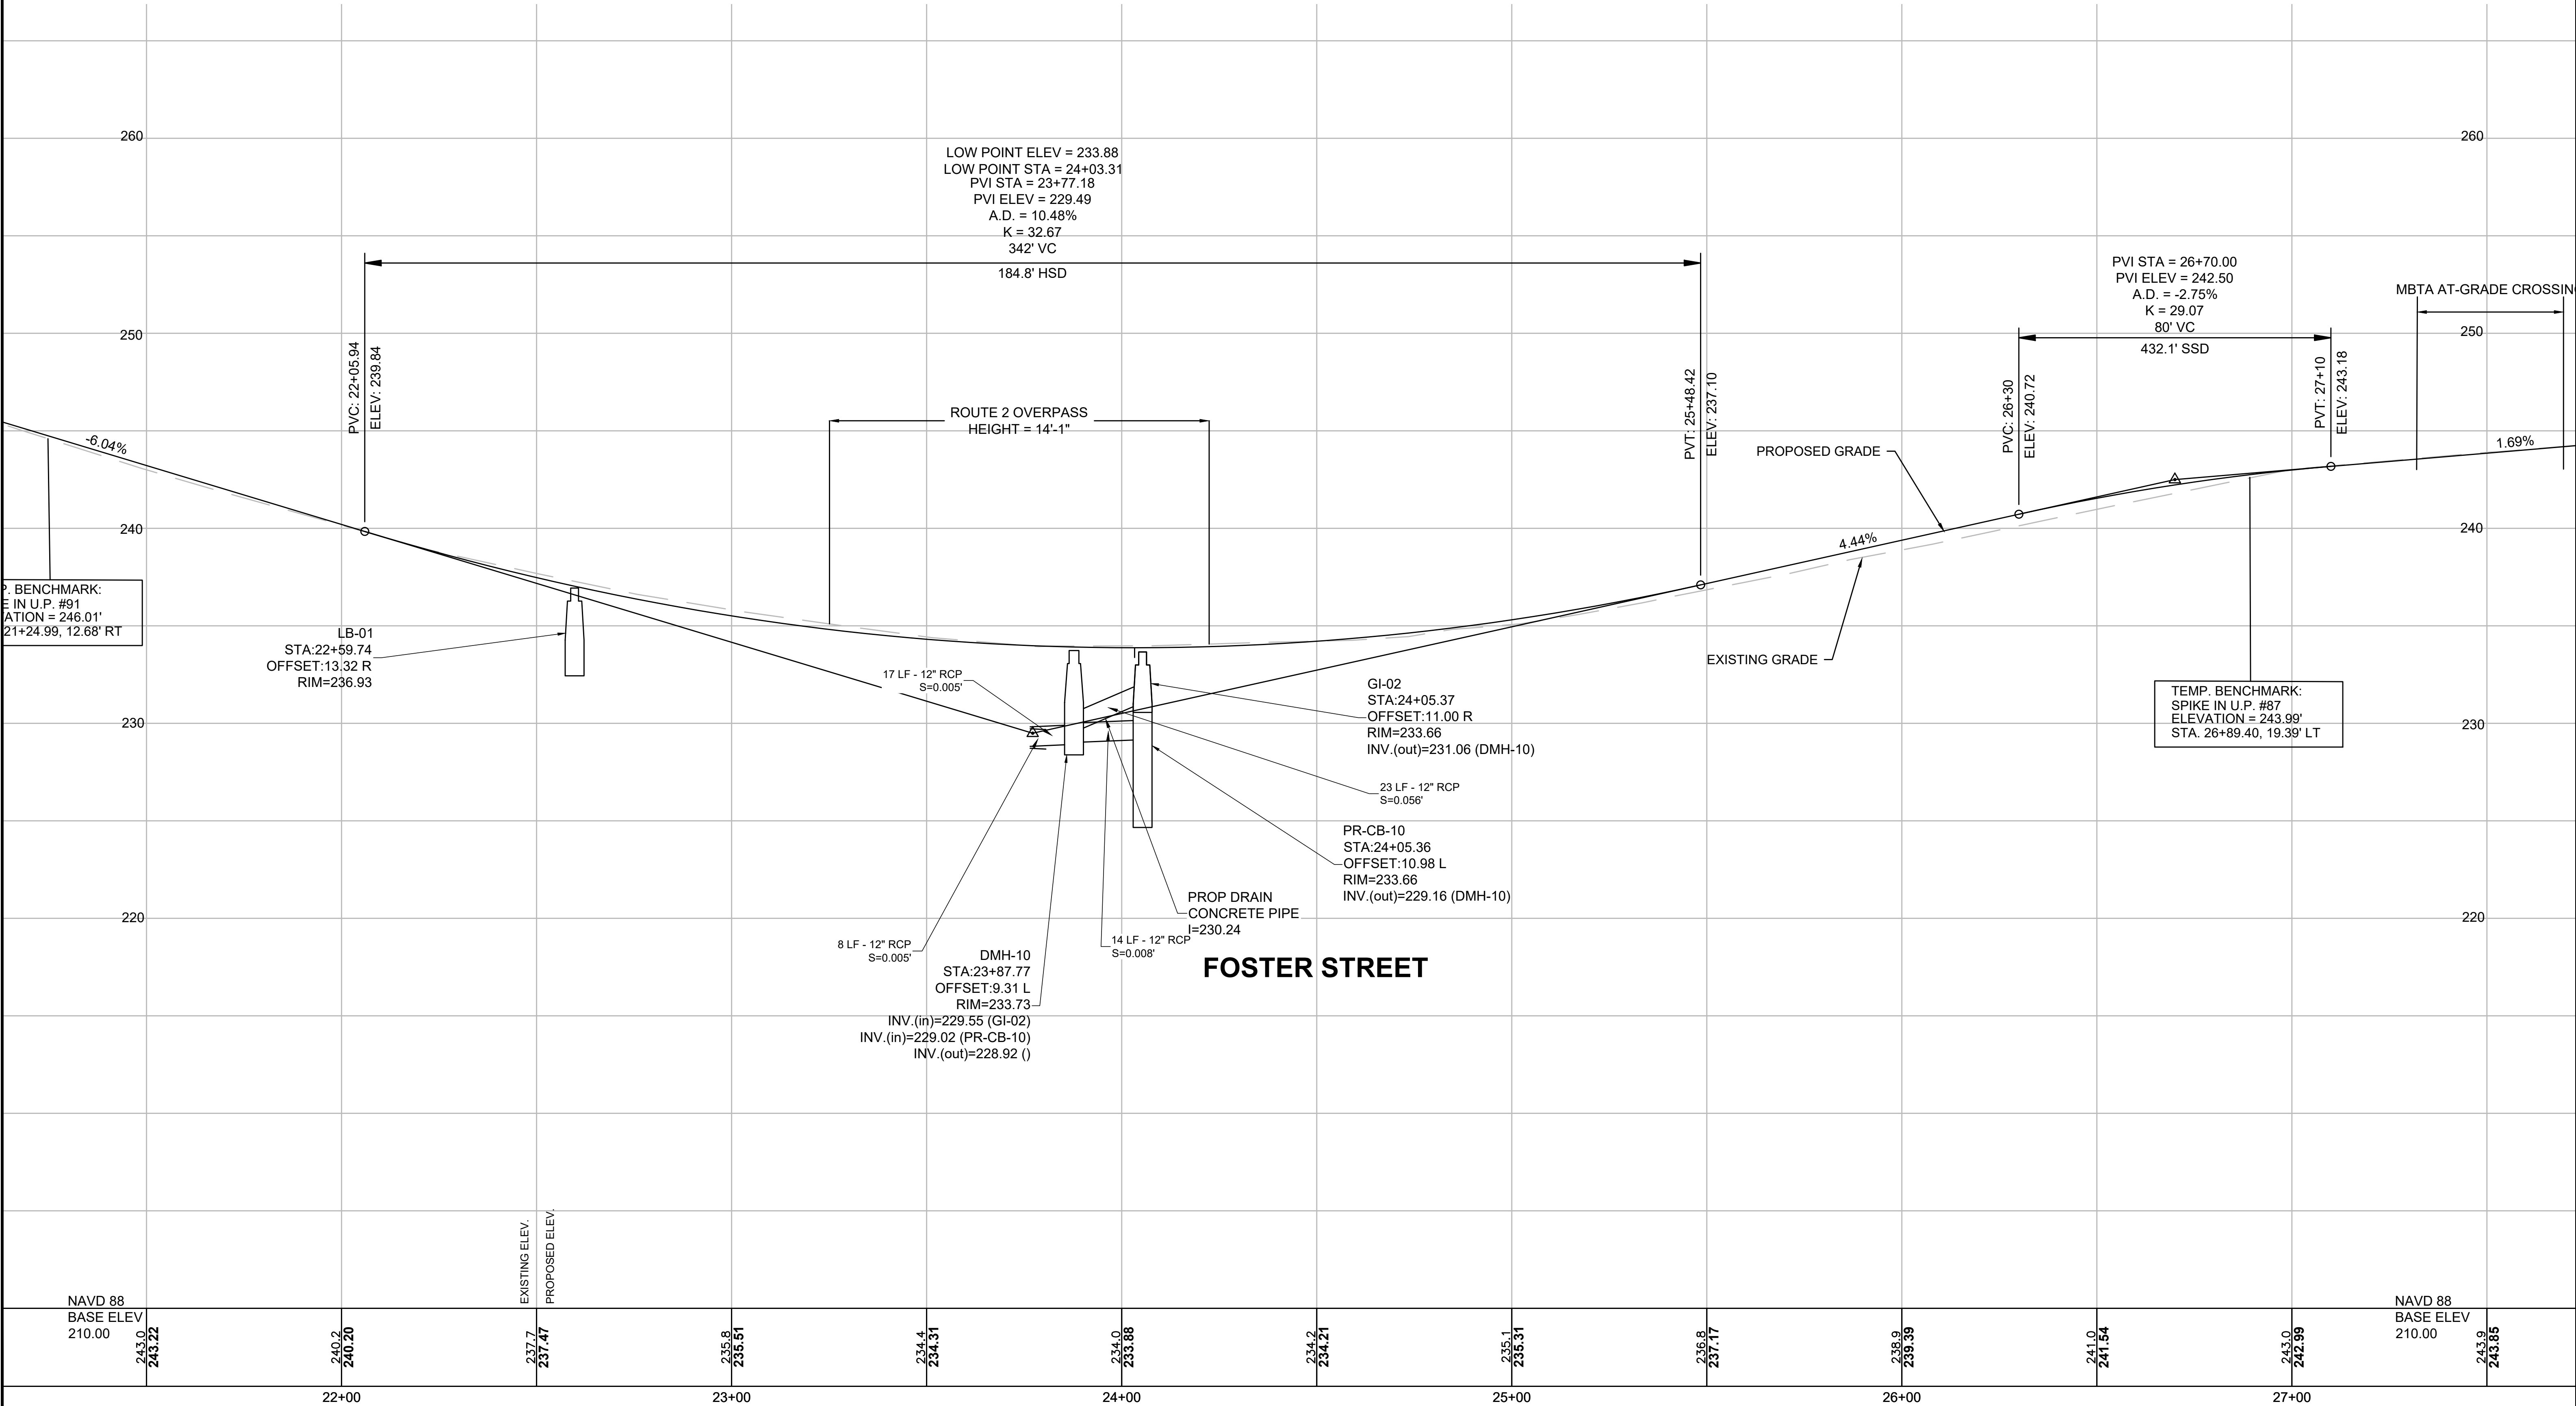


LITTLETON
RECONSTRUCTION OF FOSTER STREET

STATE	FED. AID PROJ. NO.	SHEET NO.	TOTAL SHEETS
MA	XXX-XXX(XXX)X	22	129
PROJECT FILE NO.		609054	


PROFILE - FOSTER STREET

PVI ELEV = 268.75
A.D. = -3.89%
K = 36.03
140' VC
347.7' SSD

FOR CONSTRUCTION PLANS:
SEE SHEET NOS. 9-16

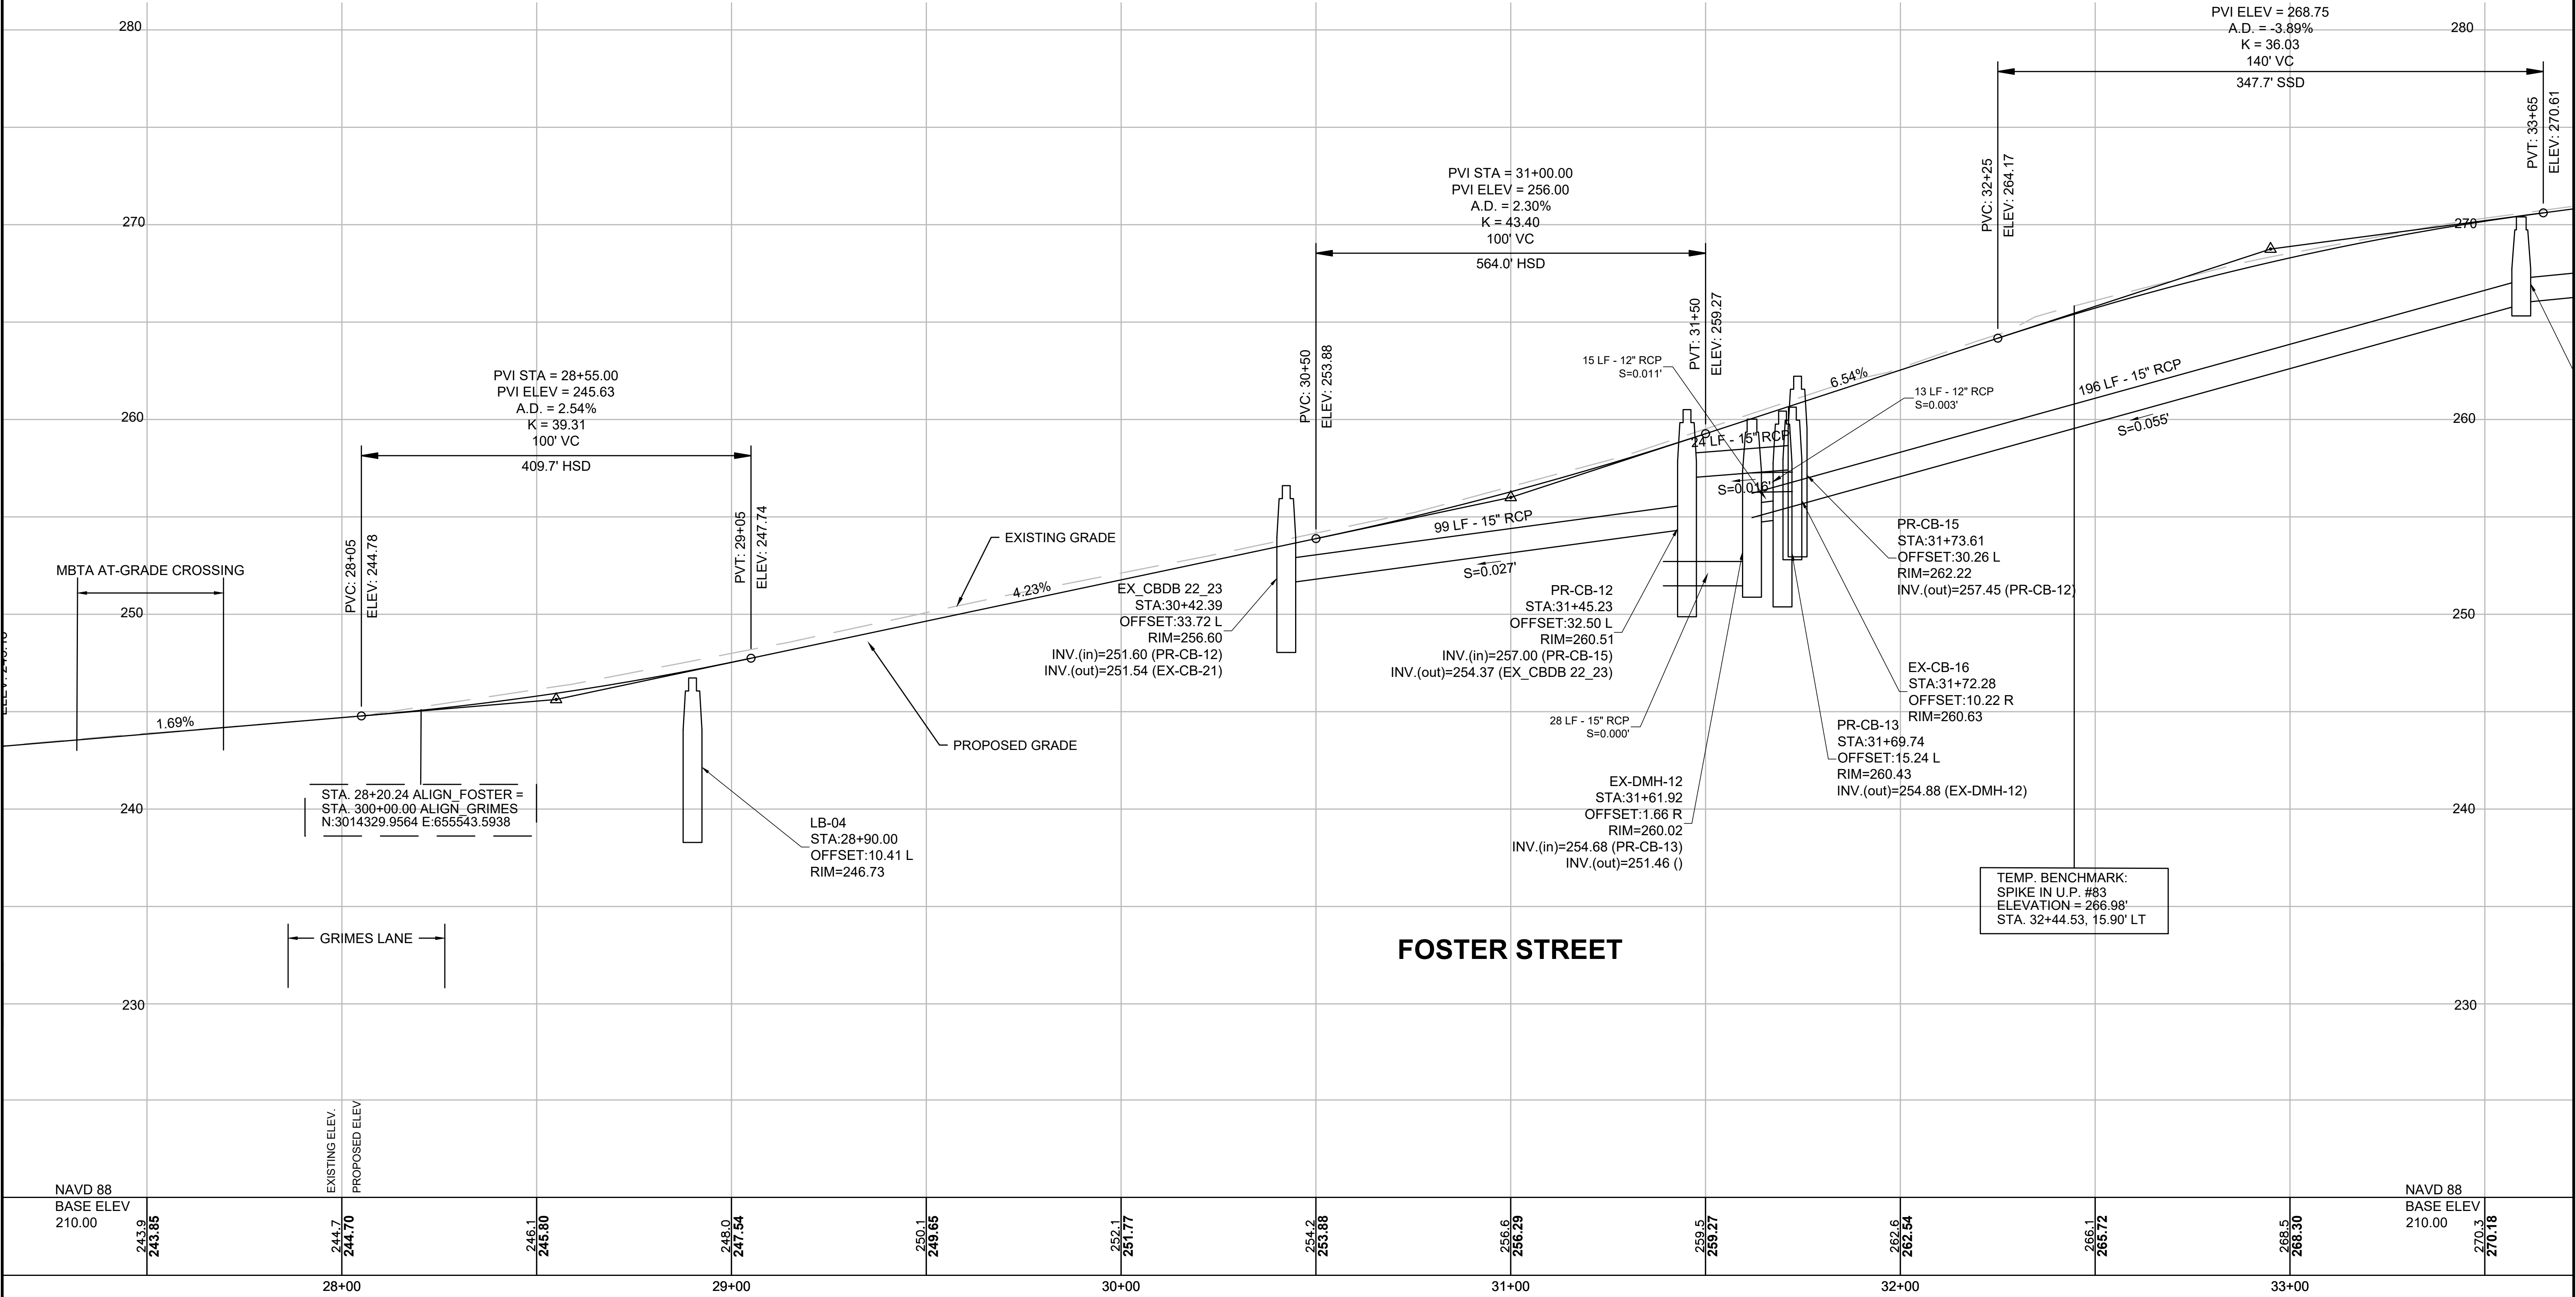



TEMP. BENCHMARK:
SPIKE IN U.P. #83
ELEVATION = 266.98'
STA. 32+44.53, 15.90' LT

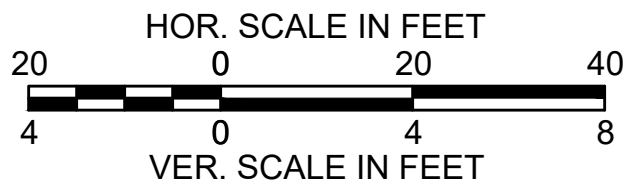

LITTLETON
RECONSTRUCTION OF FOSTER STREET

STATE	FED. AID PROJ. NO.	SHEET NO.	TOTAL SHEETS
MA	XXX-XXXX(XXX)X	23	129
PROJECT FILE NO.		609054	

PROFILE - FOSTER STREET

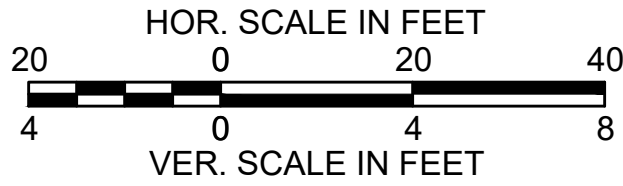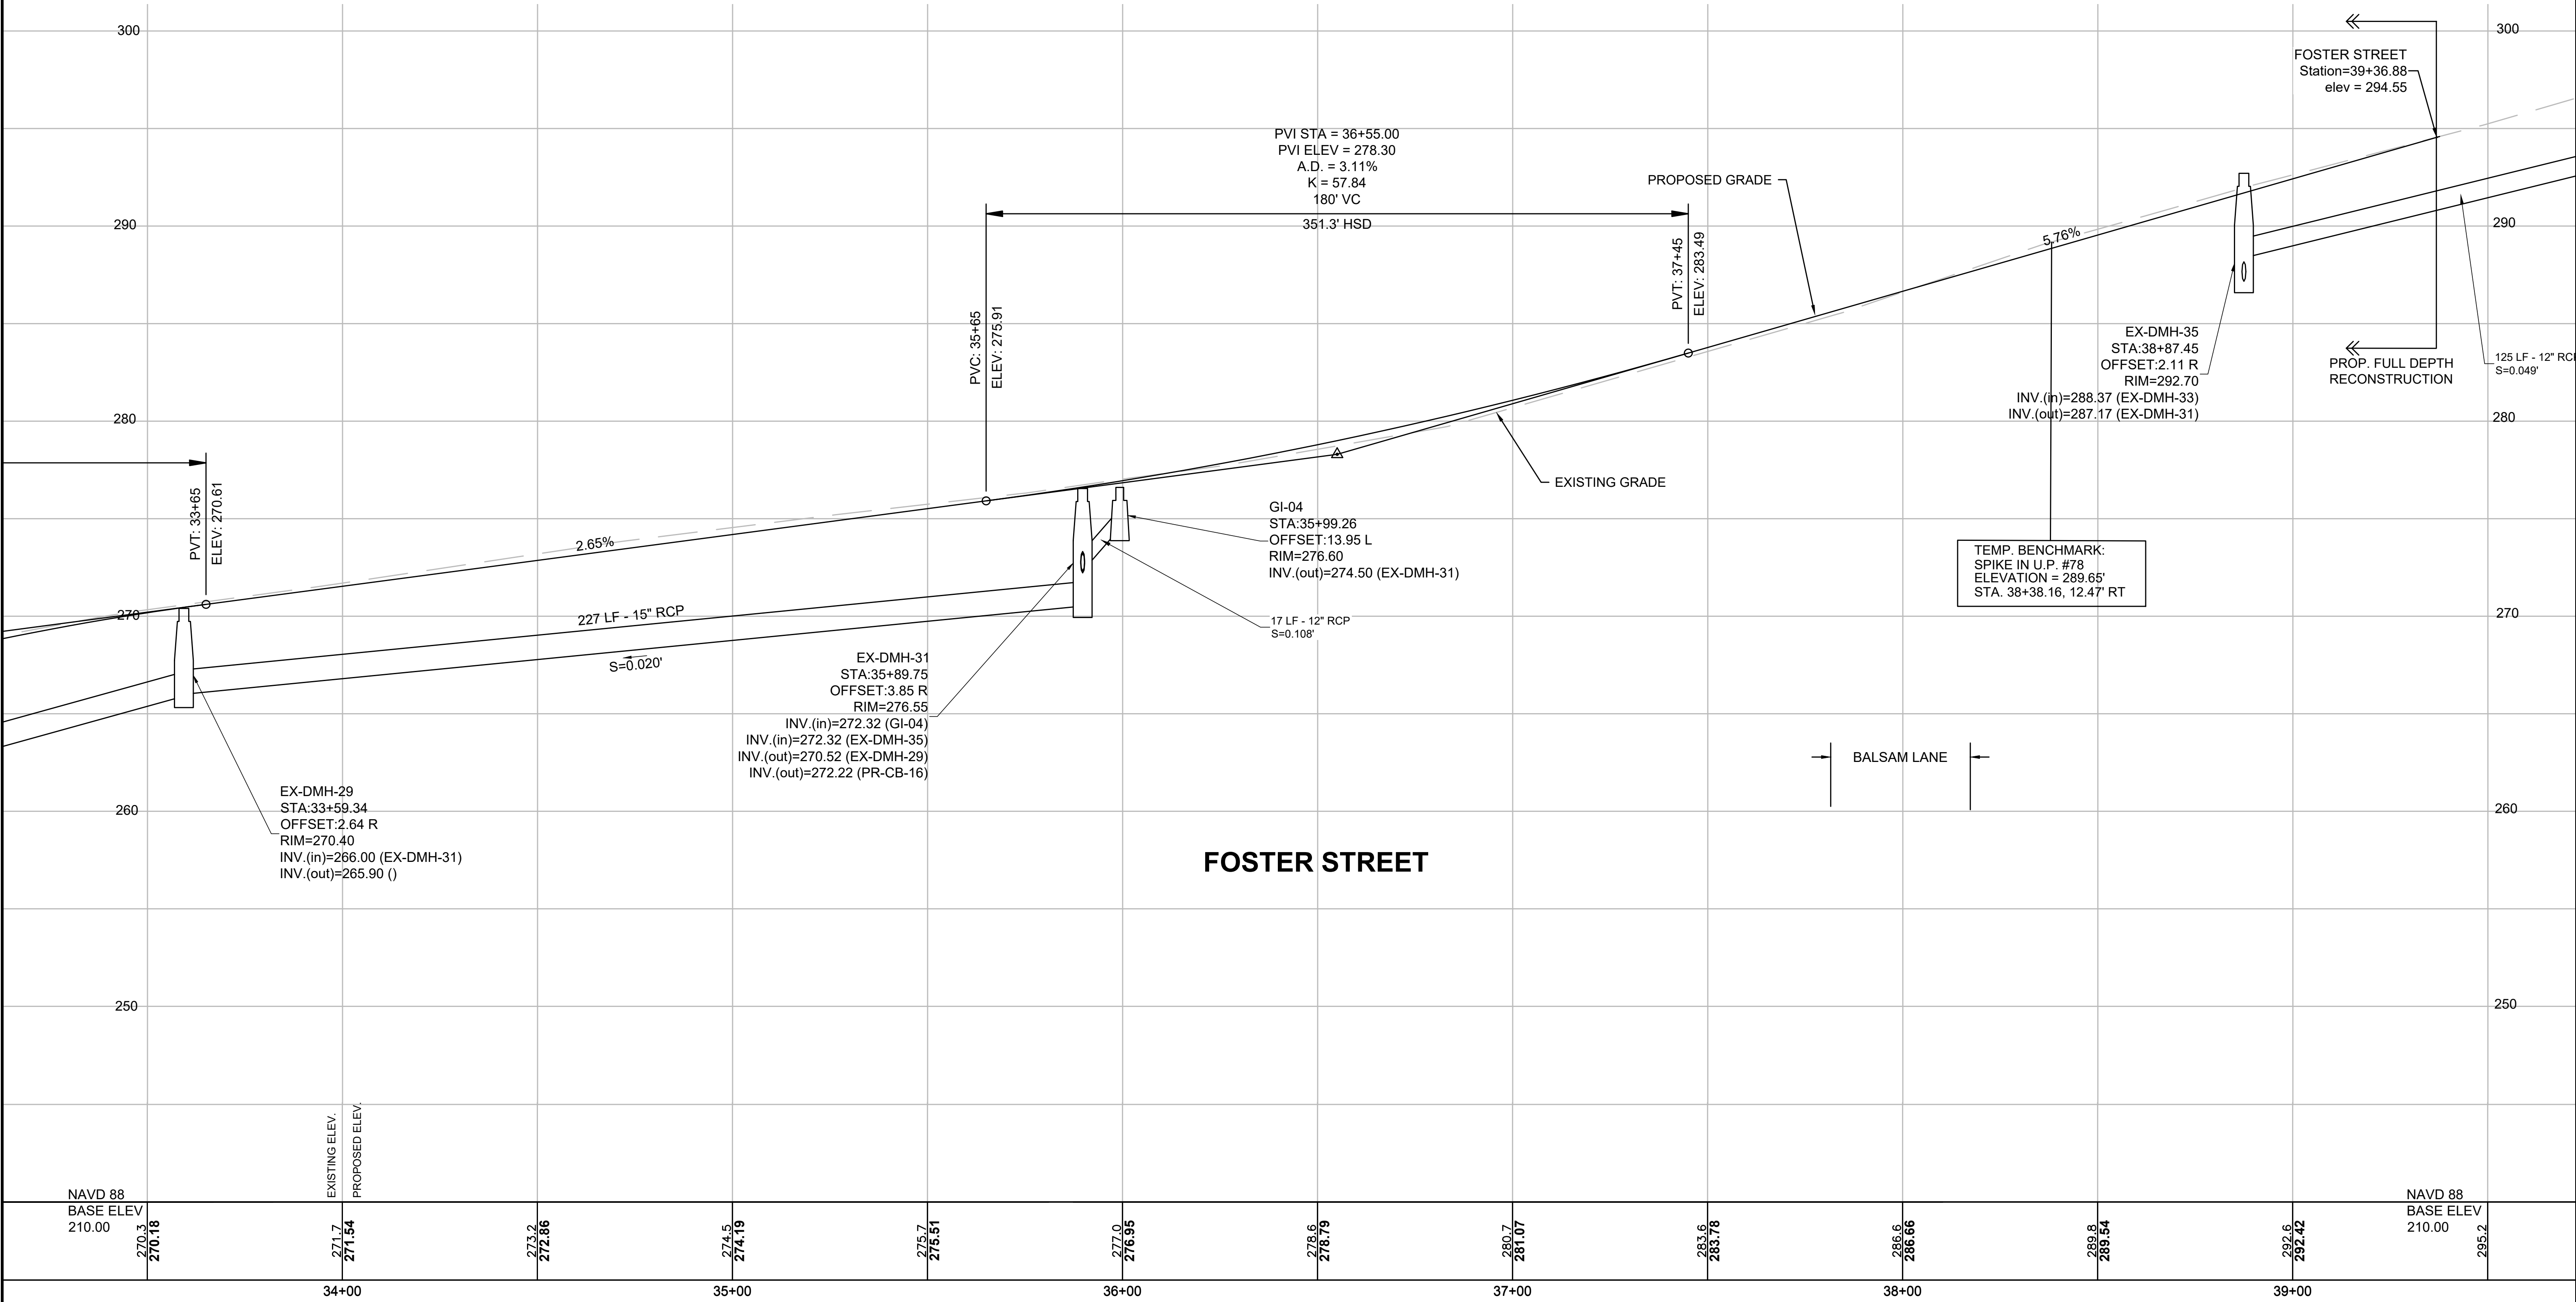

THIS PLAN IS BASED ON FIELD SURVEY CONDUCTED BY:
SHERMAN & FRYDRYK, LLC.
FIELD DATA WAS COLLECTED BETWEEN 8/14/18 & 9/17/18

HORIZONTAL CONTROL IS BASED ON VALUES PROVIDED BY MEANS OF GLOBAL POSITION SYSTEM METHODS, AND IS BASED ON THE NORTH AMERICAN DATUM OF 1983 (NAD-1093) MASSACHUSETTS STATE PLANE COORDINATE SYSTEM MAINLAND ZONE. OR PER SURVEY NOTE: HORIZONTAL DATUM IS BASED ON THE 1983 N.A.D. SYSTEM USING SURVEY GPS CONTROL POINTS SET BY THE CITY OF LITTLETON ENGINEERING DEPARTMENT. GPS CONTROL STATION CORS_IS-HAMP, PID-DE9093

VERTICAL CONTROL IS BASED ON THE NORTH AMERICAN VERTICAL DATUM OF 1988. (NAVD-1988), OR VERTICAL DATUM IS BASED ON THE 1988 N.G.V.D. SYSTEM USING SURVEY GPS CONTROL POINTS SET BY THE CITY OF LITTLETON ENGINEERING DEPARTMENT, GPS CONTROL STATION: CORS_ID-HAMP, PID-DE8093

LITTLETON
RECONSTRUCTION OF FOSTER STREET

STATE	FED. AID PROJ. NO.	SHEET NO.	TOTAL SHEETS
MA	XXX-XXXX(XXX)X	33	129
PROJECT FILE NO.		609054	


GRADING PLAN

GUTIERREZ ARTURO+CATALDO CLASS B TRUST
SWEENEY D CLASS A TRUST
BK/PG 32096/213
PARCEL #R10 6 0
TAYLOR STREET


2641-2651 SANTA ANNA AVENUE, LLC
BK/PG 68756/572
PLAN NO 1425 OF 1981
PARCEL #R10 2 1
305 FOSTER STREET

JOHN K. GRADY, TRUSTEE OF THE
FOSTER/TAYLOR REALTY TRUST
BK/PG 25198/143
PLAN NO 228 OF 1992
PARCEL #R09 32 0
230 TAYLOR STREET

JOHN K. GRADY & DAVID B. RICE, TRUSTEES OF
CONCORD ASSOCIATES FOSTER STREET TRUST
BK/PG 14680/362
PLAN NO 1314 OF 1981
PARCEL #R09 33 0
300 FOSTER STREET

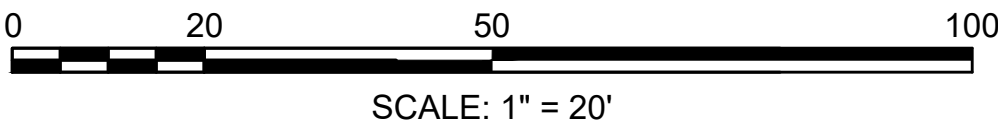

CONTINUED ON
SHEET NO. 34

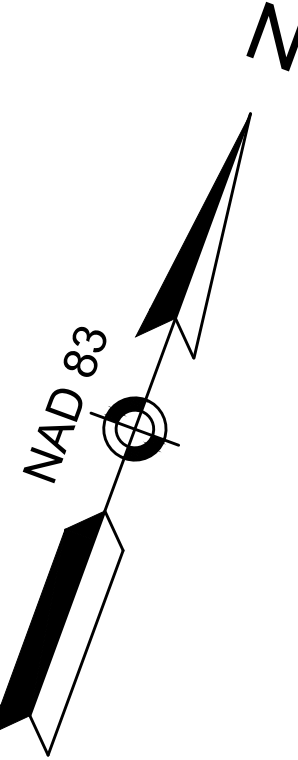

LITTLETON
RECONSTRUCTION OF FOSTER STREET

STATE	FED. AID PROJ. NO.	SHEET NO.	TOTAL SHEETS
MA	XXX-XXX(XXX)X	35	129
PROJECT FILE NO.		609054	

GRADING PLAN




<p align="center">LITTLETON</p> <p align="center">RECONSTRUCTION OF FOSTER STREET</p>			
STATE	FED. AID PROJ. NO.	SHEET NO.	TOTAL SHEETS
MA	XXX-XXX(XXX)X	36	129
PROJECT FILE NO.		609054	

**CONTINUED ON
SHEET NO. 37**

20170044A21 GRA01.DWG Plotted on 19-Apr-2023 1:52 AM

LAYER STATE:-



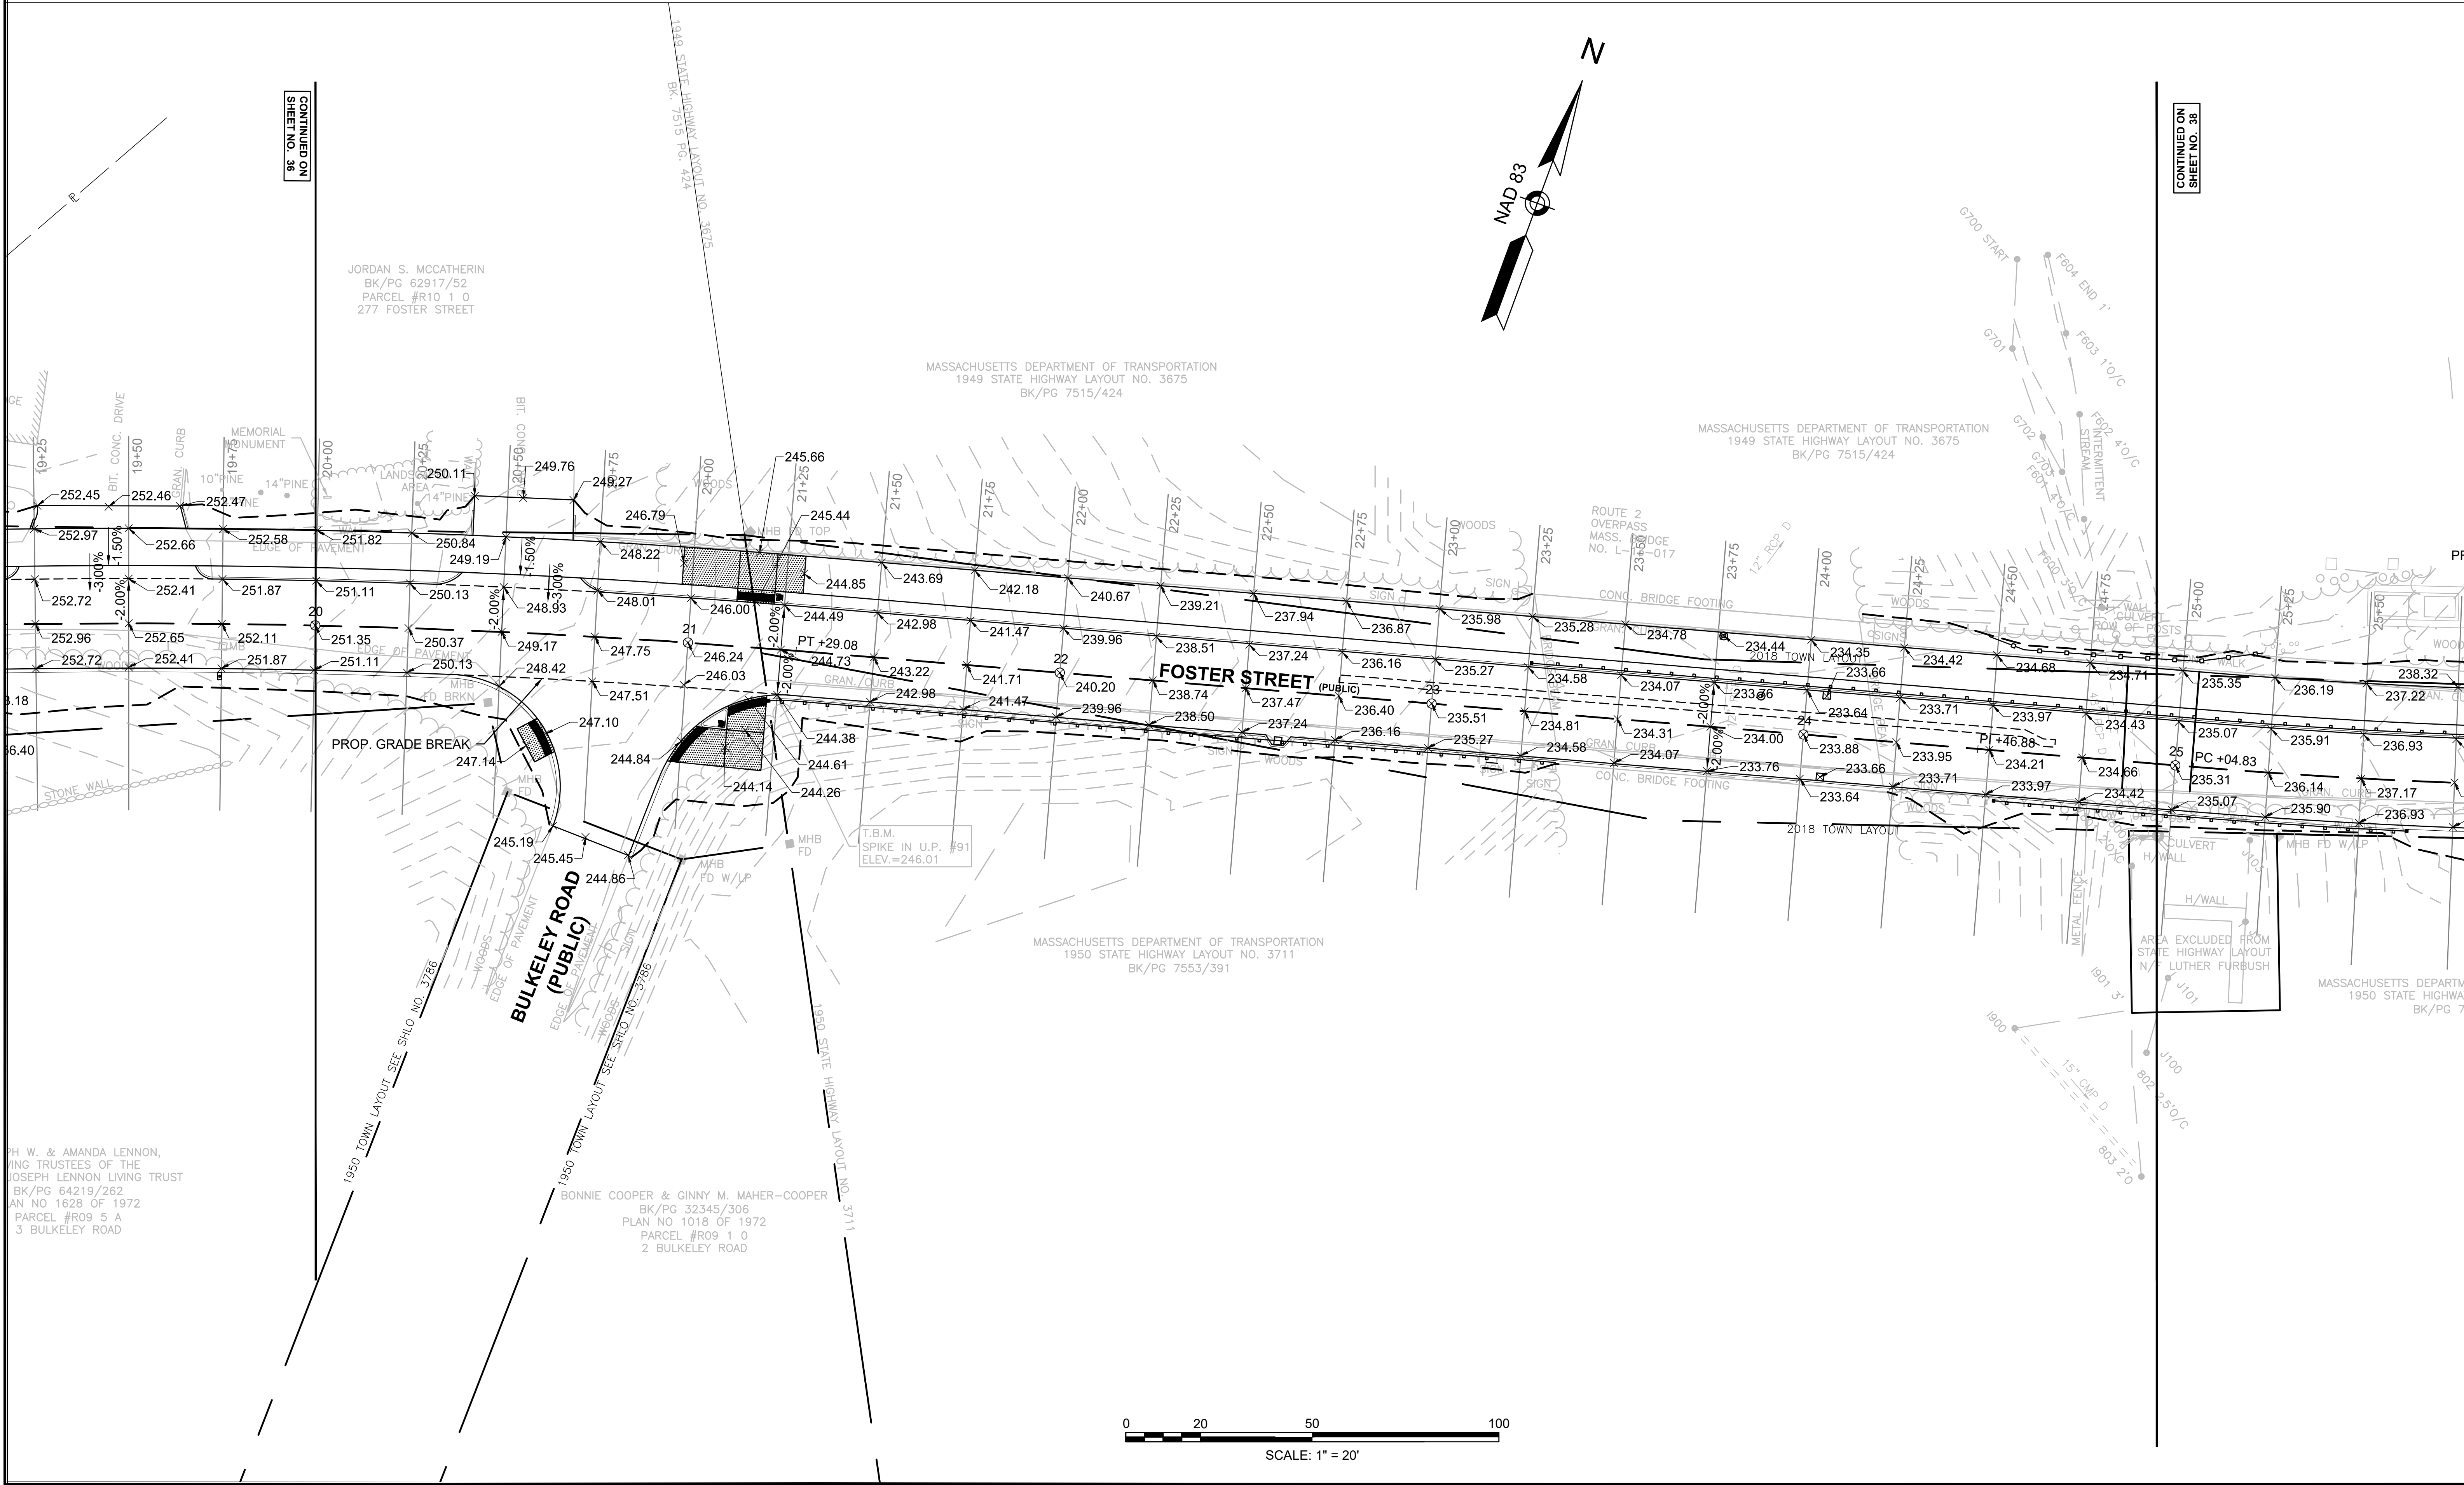

LITTLETON
RECONSTRUCTION OF FOSTER STREET

STATE	FED. AID PROJ. NO.	SHEET NO.	TOTAL SHEETS
MA	XXX-XXX(XXX)X	37	129
PROJECT FILE NO.		609054	


GRADING PLAN

File Path: J:\DWG\2017\0044A21\Civil\Plan\20170044A21_GRA01.dwg Layout: GRA06 Plotted: Wed, April 19, 2023 - 1:52 AM User: akegan
MS VIEW: -
Ploter: AUTOCAD PDF (GENERAL DOCUMENTATION) PC3 CTB File: MADOT-D.STB
LAYER STATE: -

LITTLETON
RECONSTRUCTION OF FOSTER STREET

STATE	FED. AID PROJ. NO.	SHEET NO.	TOTAL SHEETS
MA	XXX-XXX(XXX)X	38	129
PROJECT FILE NO.		609054	

GRADING PLAN

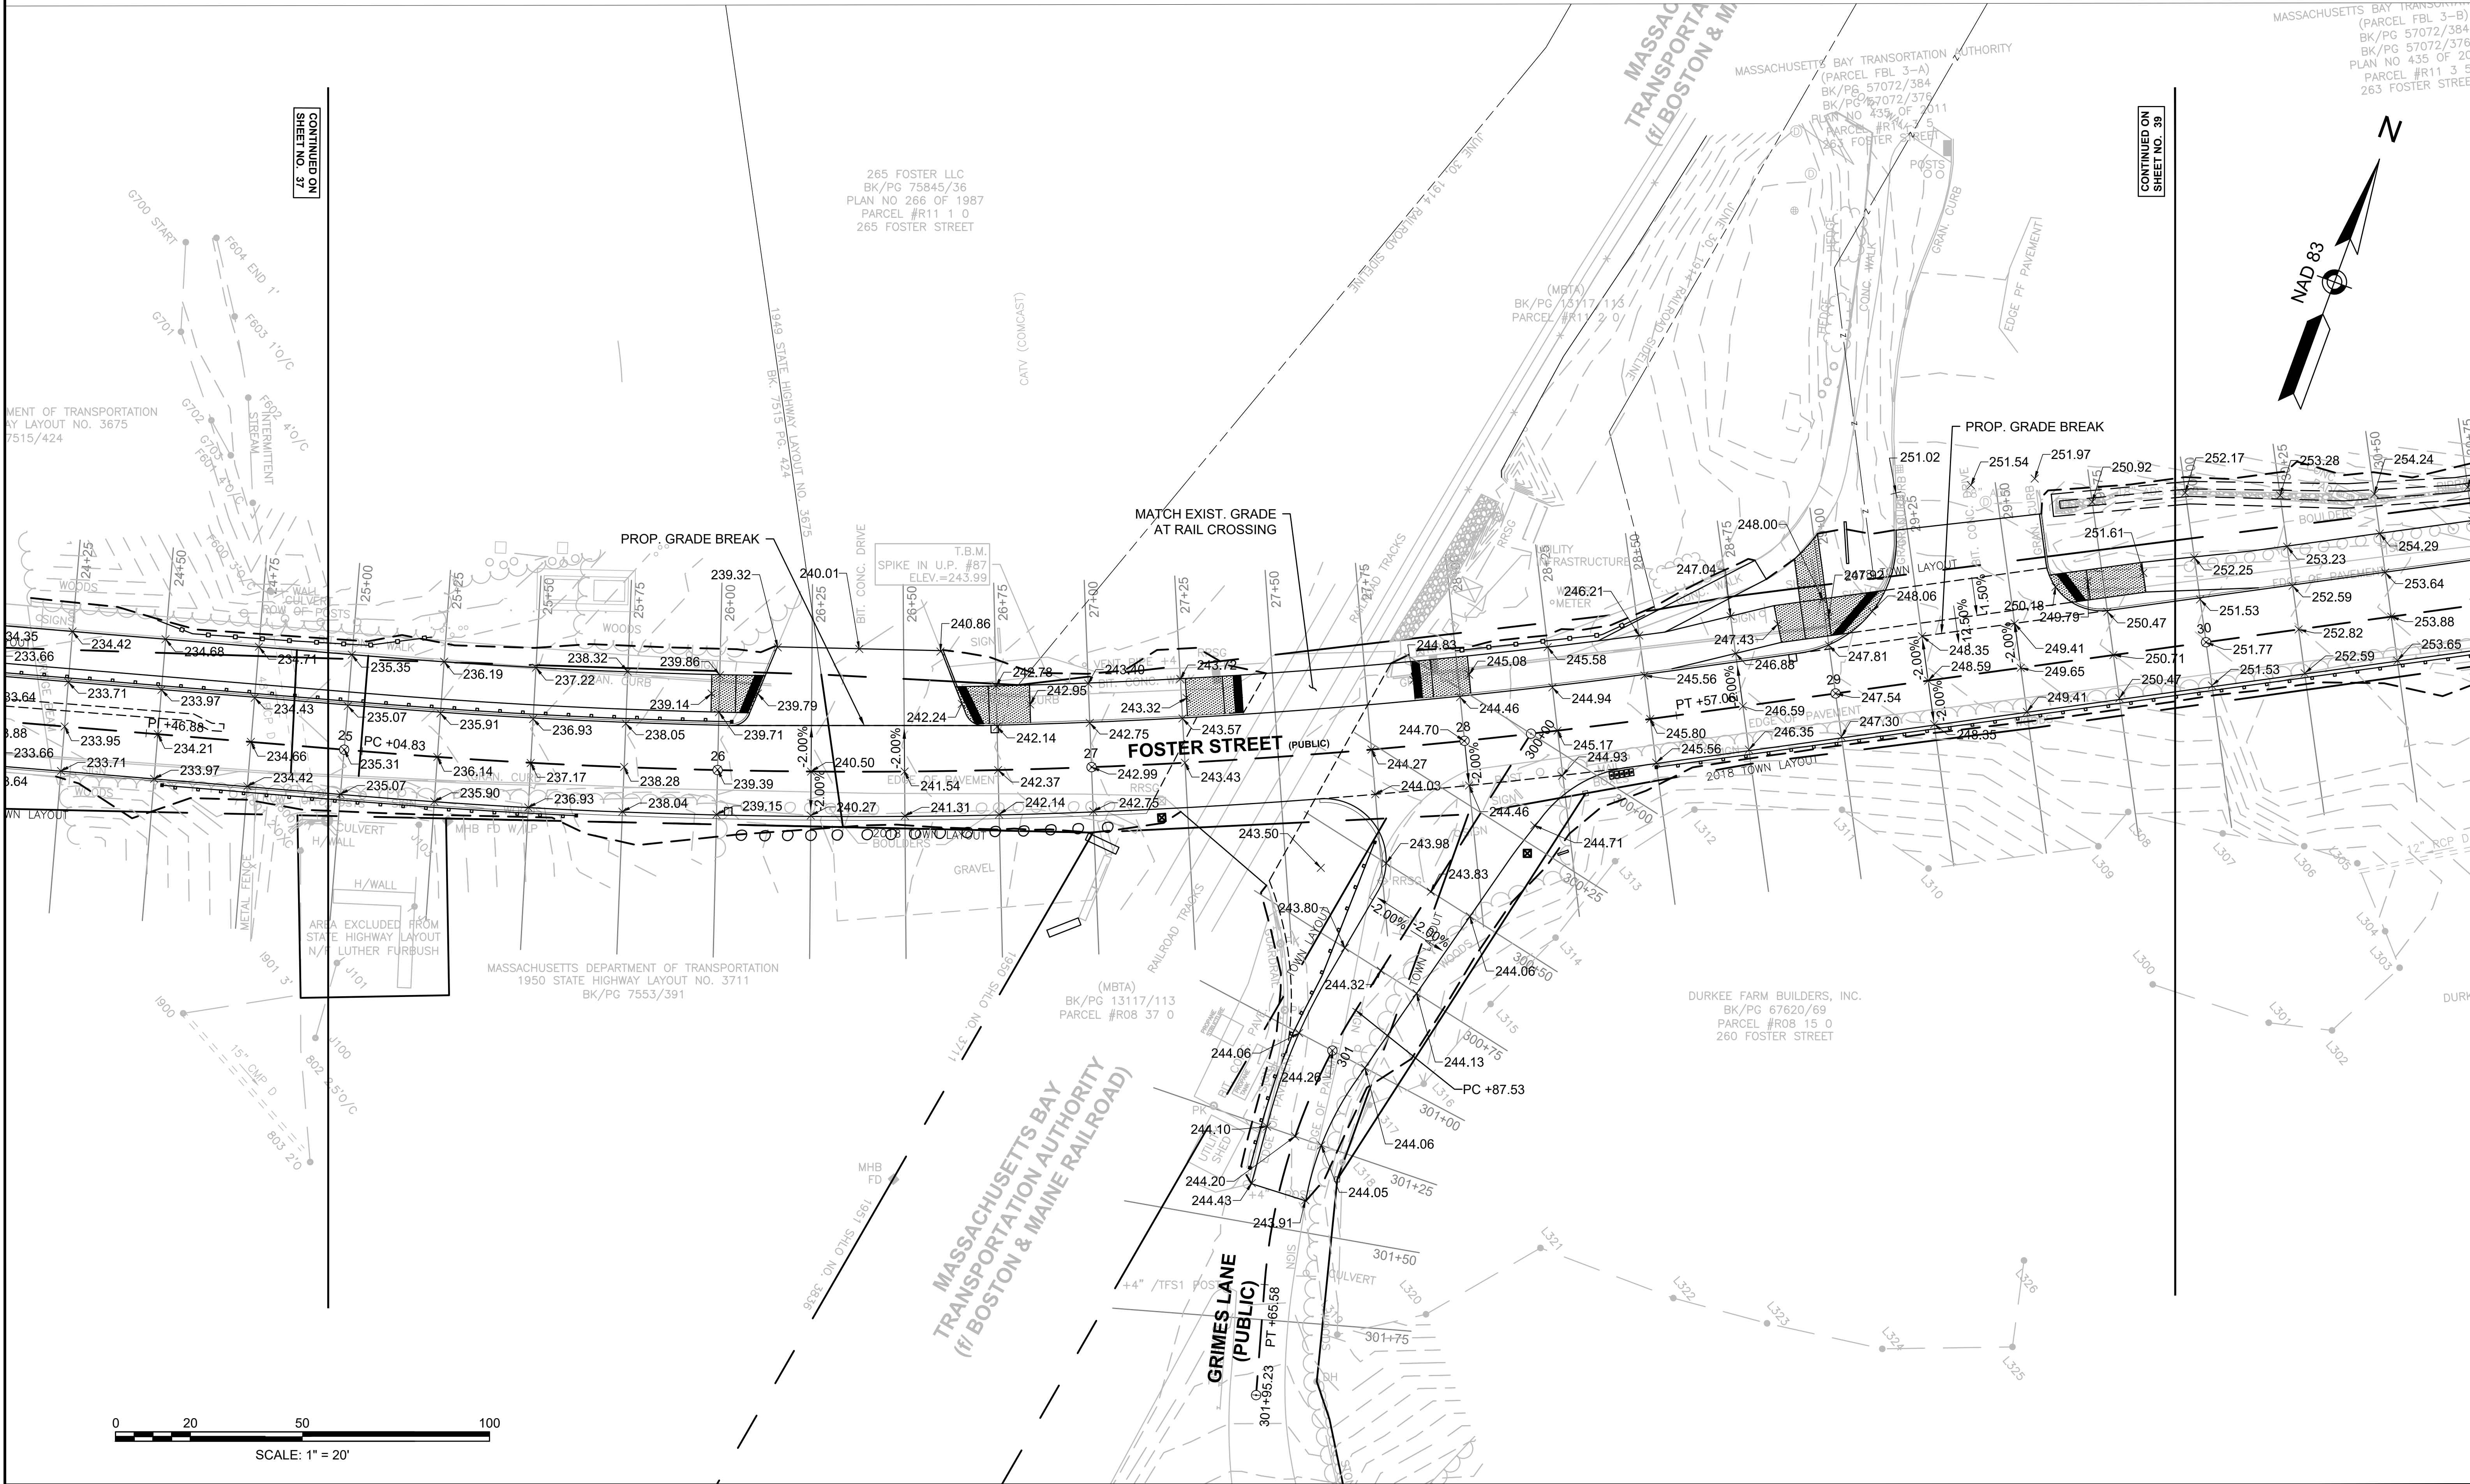

File Path: J:\DWG\2017\0044A21\Plan\20170044A21_GRA01.dwg Layout: GRA07 Plotted: Wed, April 19, 2023 1:53 AM User: akegan
MS VIEW: -
Layer: STATE: -
Printer: AUTOCAD PDF (GENERAL DOCUMENTATION) PC3 CTB File: MADOT-D.STB

LITTLETON

RECONSTRUCTION OF FOSTER STREET

STATE	FED. AID PROJ. NO.	SHEET NO.	TOTAL SHEETS
MA	XXX-XXXX(XXX)X	39	129
PROJECT FILE NO.		609054	

GRADING PLAN



0 20 50 100



SCALE: 1" = 20'

LITTLETON
RECONSTRUCTION OF FOSTER STREET

STATE	FED. AID PROJ. NO.	SHEET NO.	TOTAL SHEETS
MA	XXX-XXX(XXX)X	41	129
PROJECT FILE NO.		609054	

PAVEMENT MARKING & SIGNING PLAN



MARKING LEGEND	
	PROPOSED SIGN
SL	PROPOSED 12" WHITE STOP LINE / 24" AT RAILROAD CROSSING
CW	PROPOSED 24" WHITE CROSS WALK
SWL	PROPOSED 6" SINGLE WHITE LINE
SYL	PROPOSED 4" SINGLE SOLID YELLOW LINE
BYCL	PROPOSED 4" BROKEN YELLOW CENTER LINE (3' MARK - 9' SKIP)
DBYL	PROPOSED 6" DOUBLE YELLOW LINE
DWLEX	PROPOSED 6" DOTTED WHITE LANE EXTENSION LINE (2' MARK - 6' SKIP)
DYLEX	PROPOSED 6" DOTTED YELLOW LANE EXTENSION LINE (2' MARK - 6' SKIP)
WGL	WHITE GORE LINE - 12" SOLID WHITE LINE

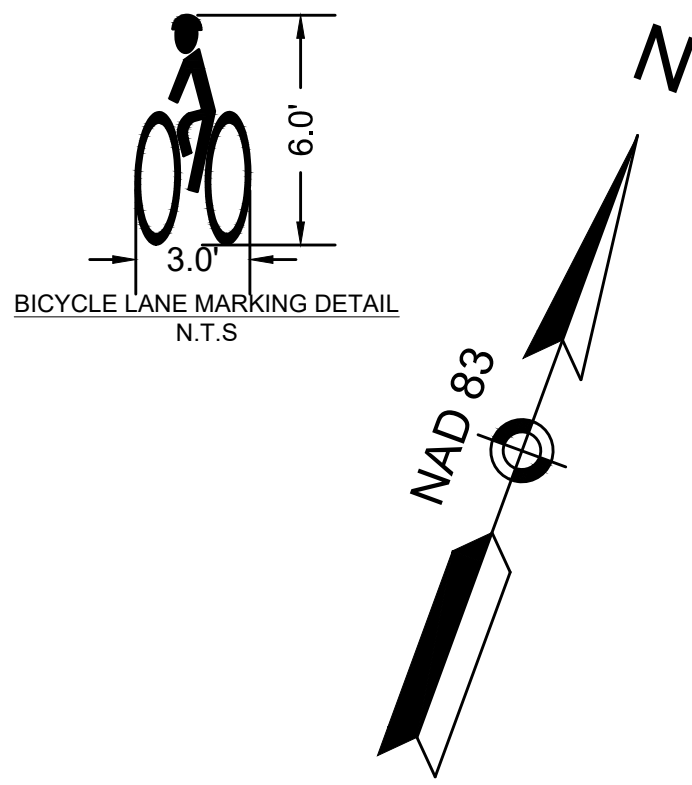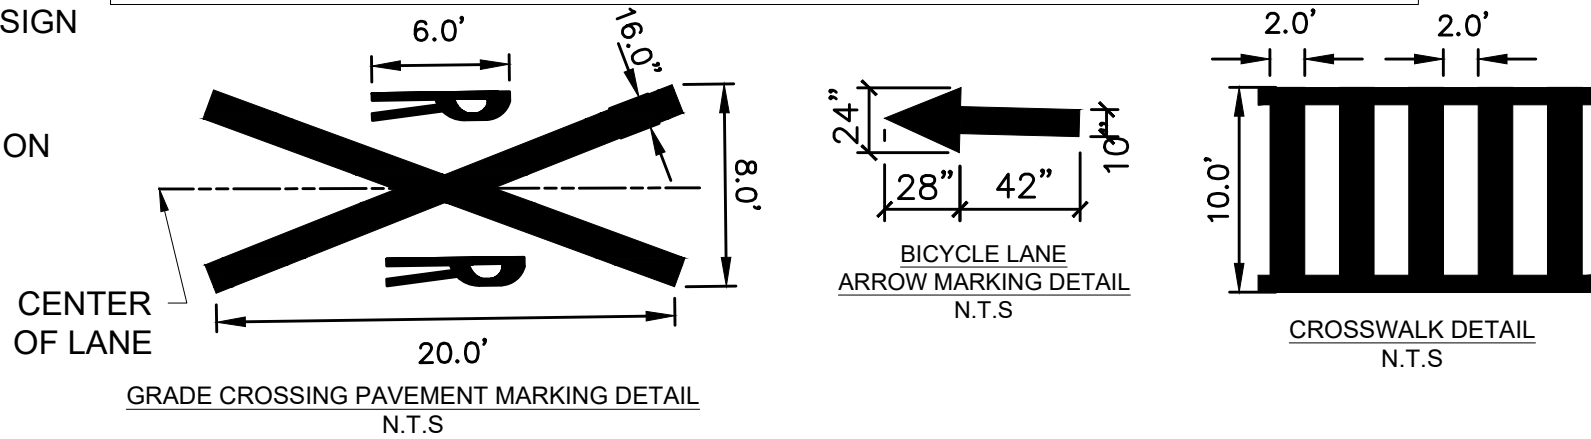

NOTES:

- ALL EXISTING SIGNS TO REMAIN UNLESS OTHERWISE NOTED ON PLANS
- ALL PROPOSED PAVEMENT MARKING LINES ON ROADWAYS SHALL BE WET REFLECTORIZED RECESSED THERMOPLASTIC. ALL MARKINGS SHALL BE 6" WIDE, EXCEPT STOP BARS WHICH SHALL BE 12" WIDE.
- ALL PROPOSED PAVEMENT MARKING LINES ON SHARED-USE PATH SHALL BE PAINTED. ALL MARKINGS SHALL BE 4" WIDE, EXCEPT STOP BARS WHICH SHALL BE 12" WIDE.
- ANY SIGN LABELED WITH AN " * " SHALL BE MOUNTED ON A SIGN SUPPORT FOR SHARED-USE PATH. THE SUPPORTS SHALL BE 4"x4" PRESSURE TREATED WOOD POSTS AND PLACED AS SHOWN ON THE "TYPICAL SIGN PLACEMENT DETAIL" IN THE CONSTRUCTION DETAILS.
- ANY OTHER SIGN SHALL BE MOUNTED ON A STANDARD P-5 POST FACTORY COATED GLOSS BLACK AT STANDARD MUTCD HEIGHT UNLESS OTHERWISE SHOWN ON PLANS.
- ALL R7 SERIES SIGNS (NO PARKING) SHALL BE INSTALLED AT 45 DEGREE ANGLE RELATIVE TO THE ROADWAY. REFER TO THE SIGN SYMBOLS PLACED ON PLANS
- SEE SIGN SUMMARY ON SHEET 49 FOR SIGN DETAILS

XXXX	PROPOSED SIGN DESIGNATION
XXXX	EXISTING SIGN DESIGNATION

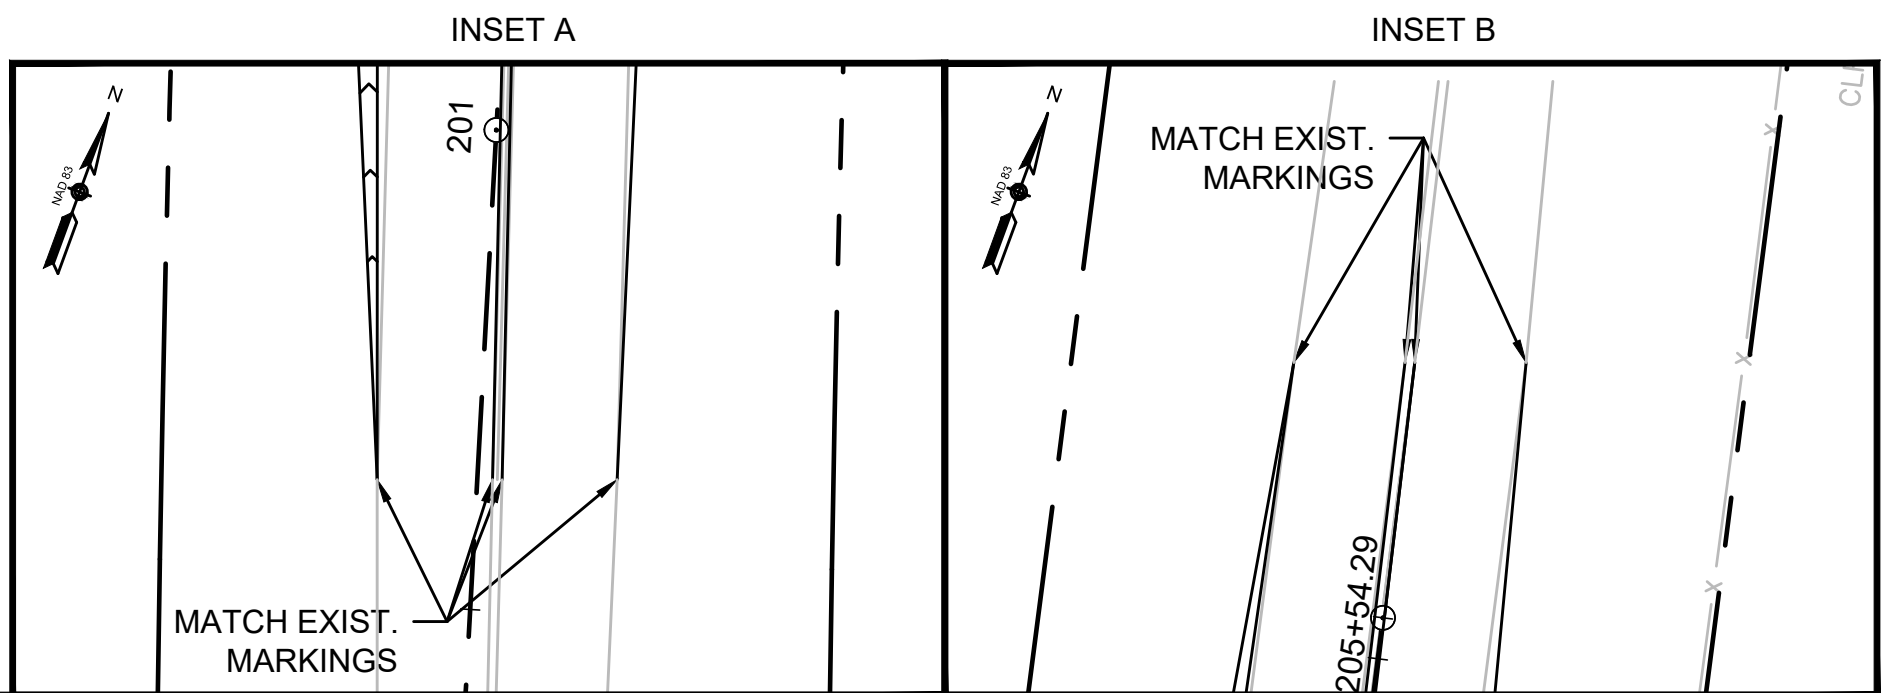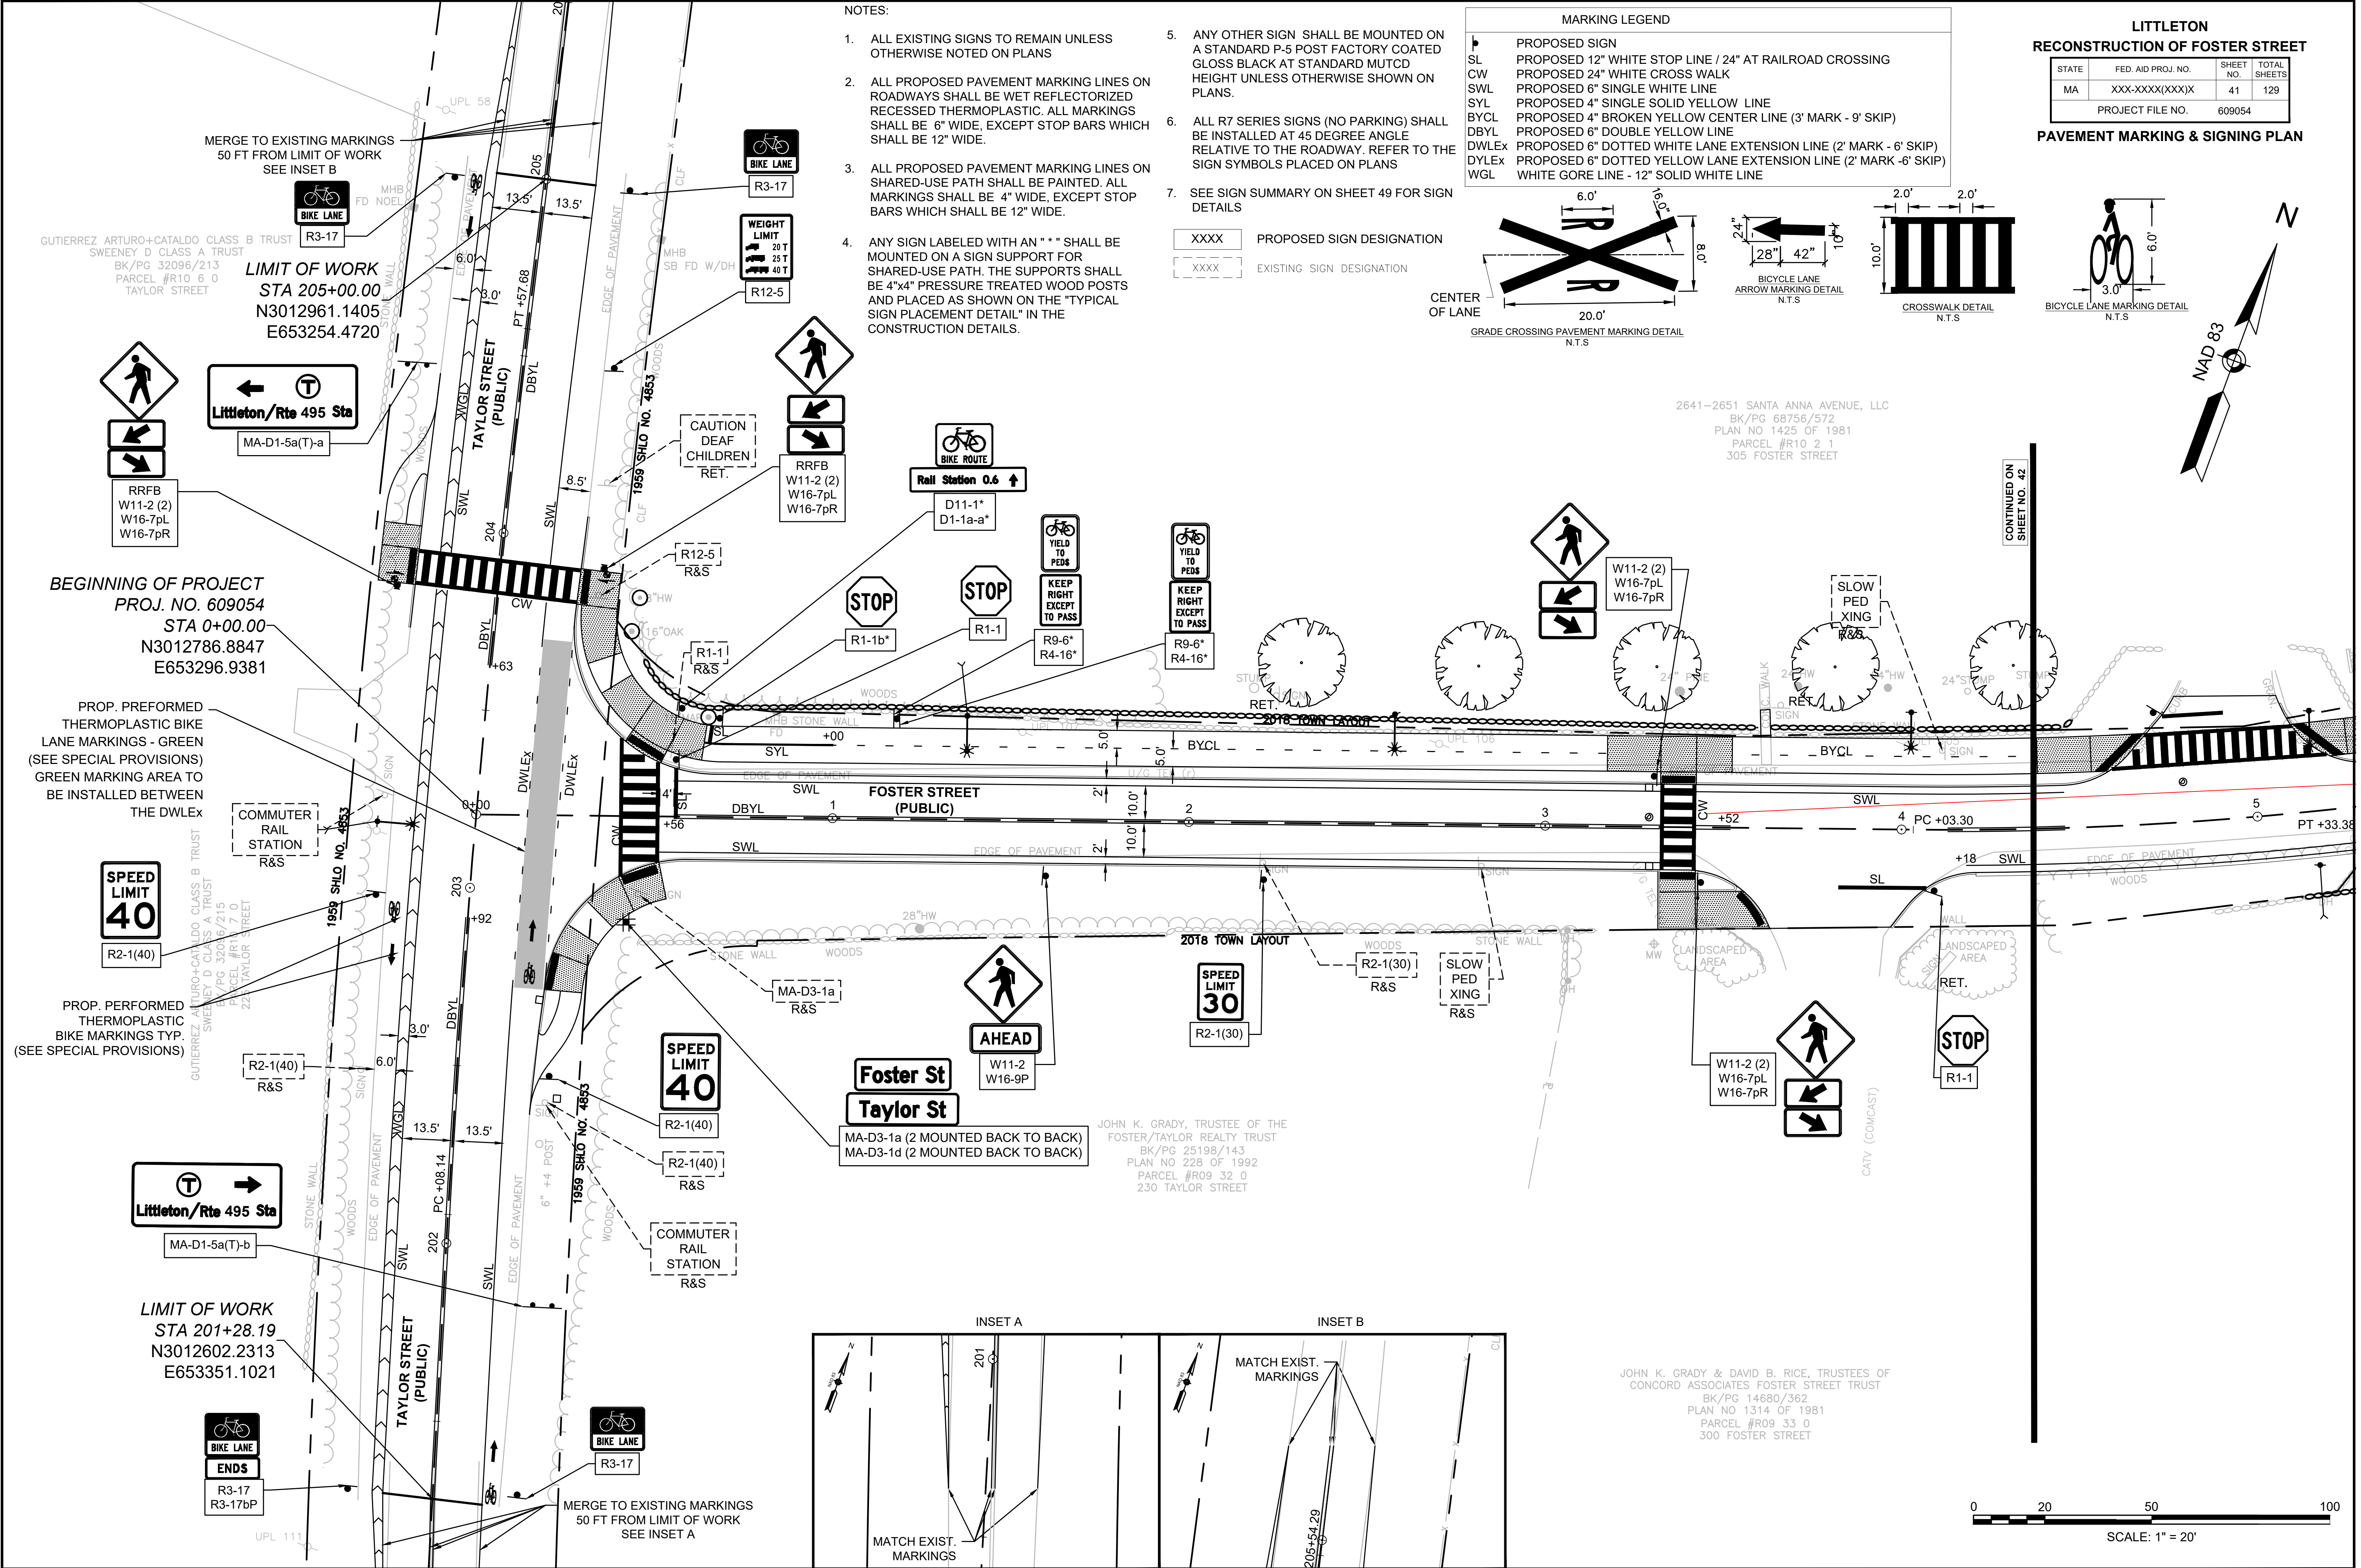

JOHN K. GRADY & DAVID B. RICE, TRUSTEES OF
CONCORD ASSOCIATES FOSTER STREET TRUST
BK/PG 14680/362
PLAN NO 1314 OF 1981
PARCEL #R09 33 0
300 FOSTER STREET

0 20 50 100
SCALE: 1" = 20'

LLC

24" STON



CATV (COMCAST)

S OF
UST

A diamond-shaped pedestrian crossing sign with a black border and a black silhouette of a person walking.

AHEAD

W11-2
W16-9P

ASIJA PROPERTIES, LLC & SANDEEP ASIJA
BK/PG 70688/365
PLAN NO 1425 OF 1981
PARCEL #R10 2 2
295 FOSTER STREET



YIELD TO PEDS

**KEEP
RIGHT
EXCEPT
TO PASS**

R9-6*(2) EACH SIDE OF POST
R4-16*(2) EACH SIDE OF POST

JOHN K. GRADY & DAVID B. RICE, TRUSTEES OF
CONCORD ASSOCIATES FOSTER STREET TRUST
BK/PG 14680/362
PLAN NO 1314 OF 1981
PARCEL #R09 33 0
300 FOSTER STREET

STATE	FED. AID PROJ. NO.	SHEET NO.	TOTAL SHEETS
MA	XXX-XXXX(XXX)X	42	129
PROJECT FILE NO.		609054	

PAVEMENT MARKING & SIGNING PLAN

CONTINUED ON
SHEET NO. 43

0 20 50 100

SCALE: 1" = 20'


20170044A21_PVT01.DWG Plotted on 19-Apr-2023 1:54 AM

SEE SHEET 41 FOR MARKING & SIGNING NOTES

**LITTLETON
RECONSTRUCTION OF FOSTER STREET**

STATE	FED. AID PROJ. NO.	SHEET NO.	TOTAL SHEETS
MA	XXX-XXXX(XXX)X	43	129
PROJECT FILE NO.		609054	

PAVEMENT MARKING & SIGNING PLAN

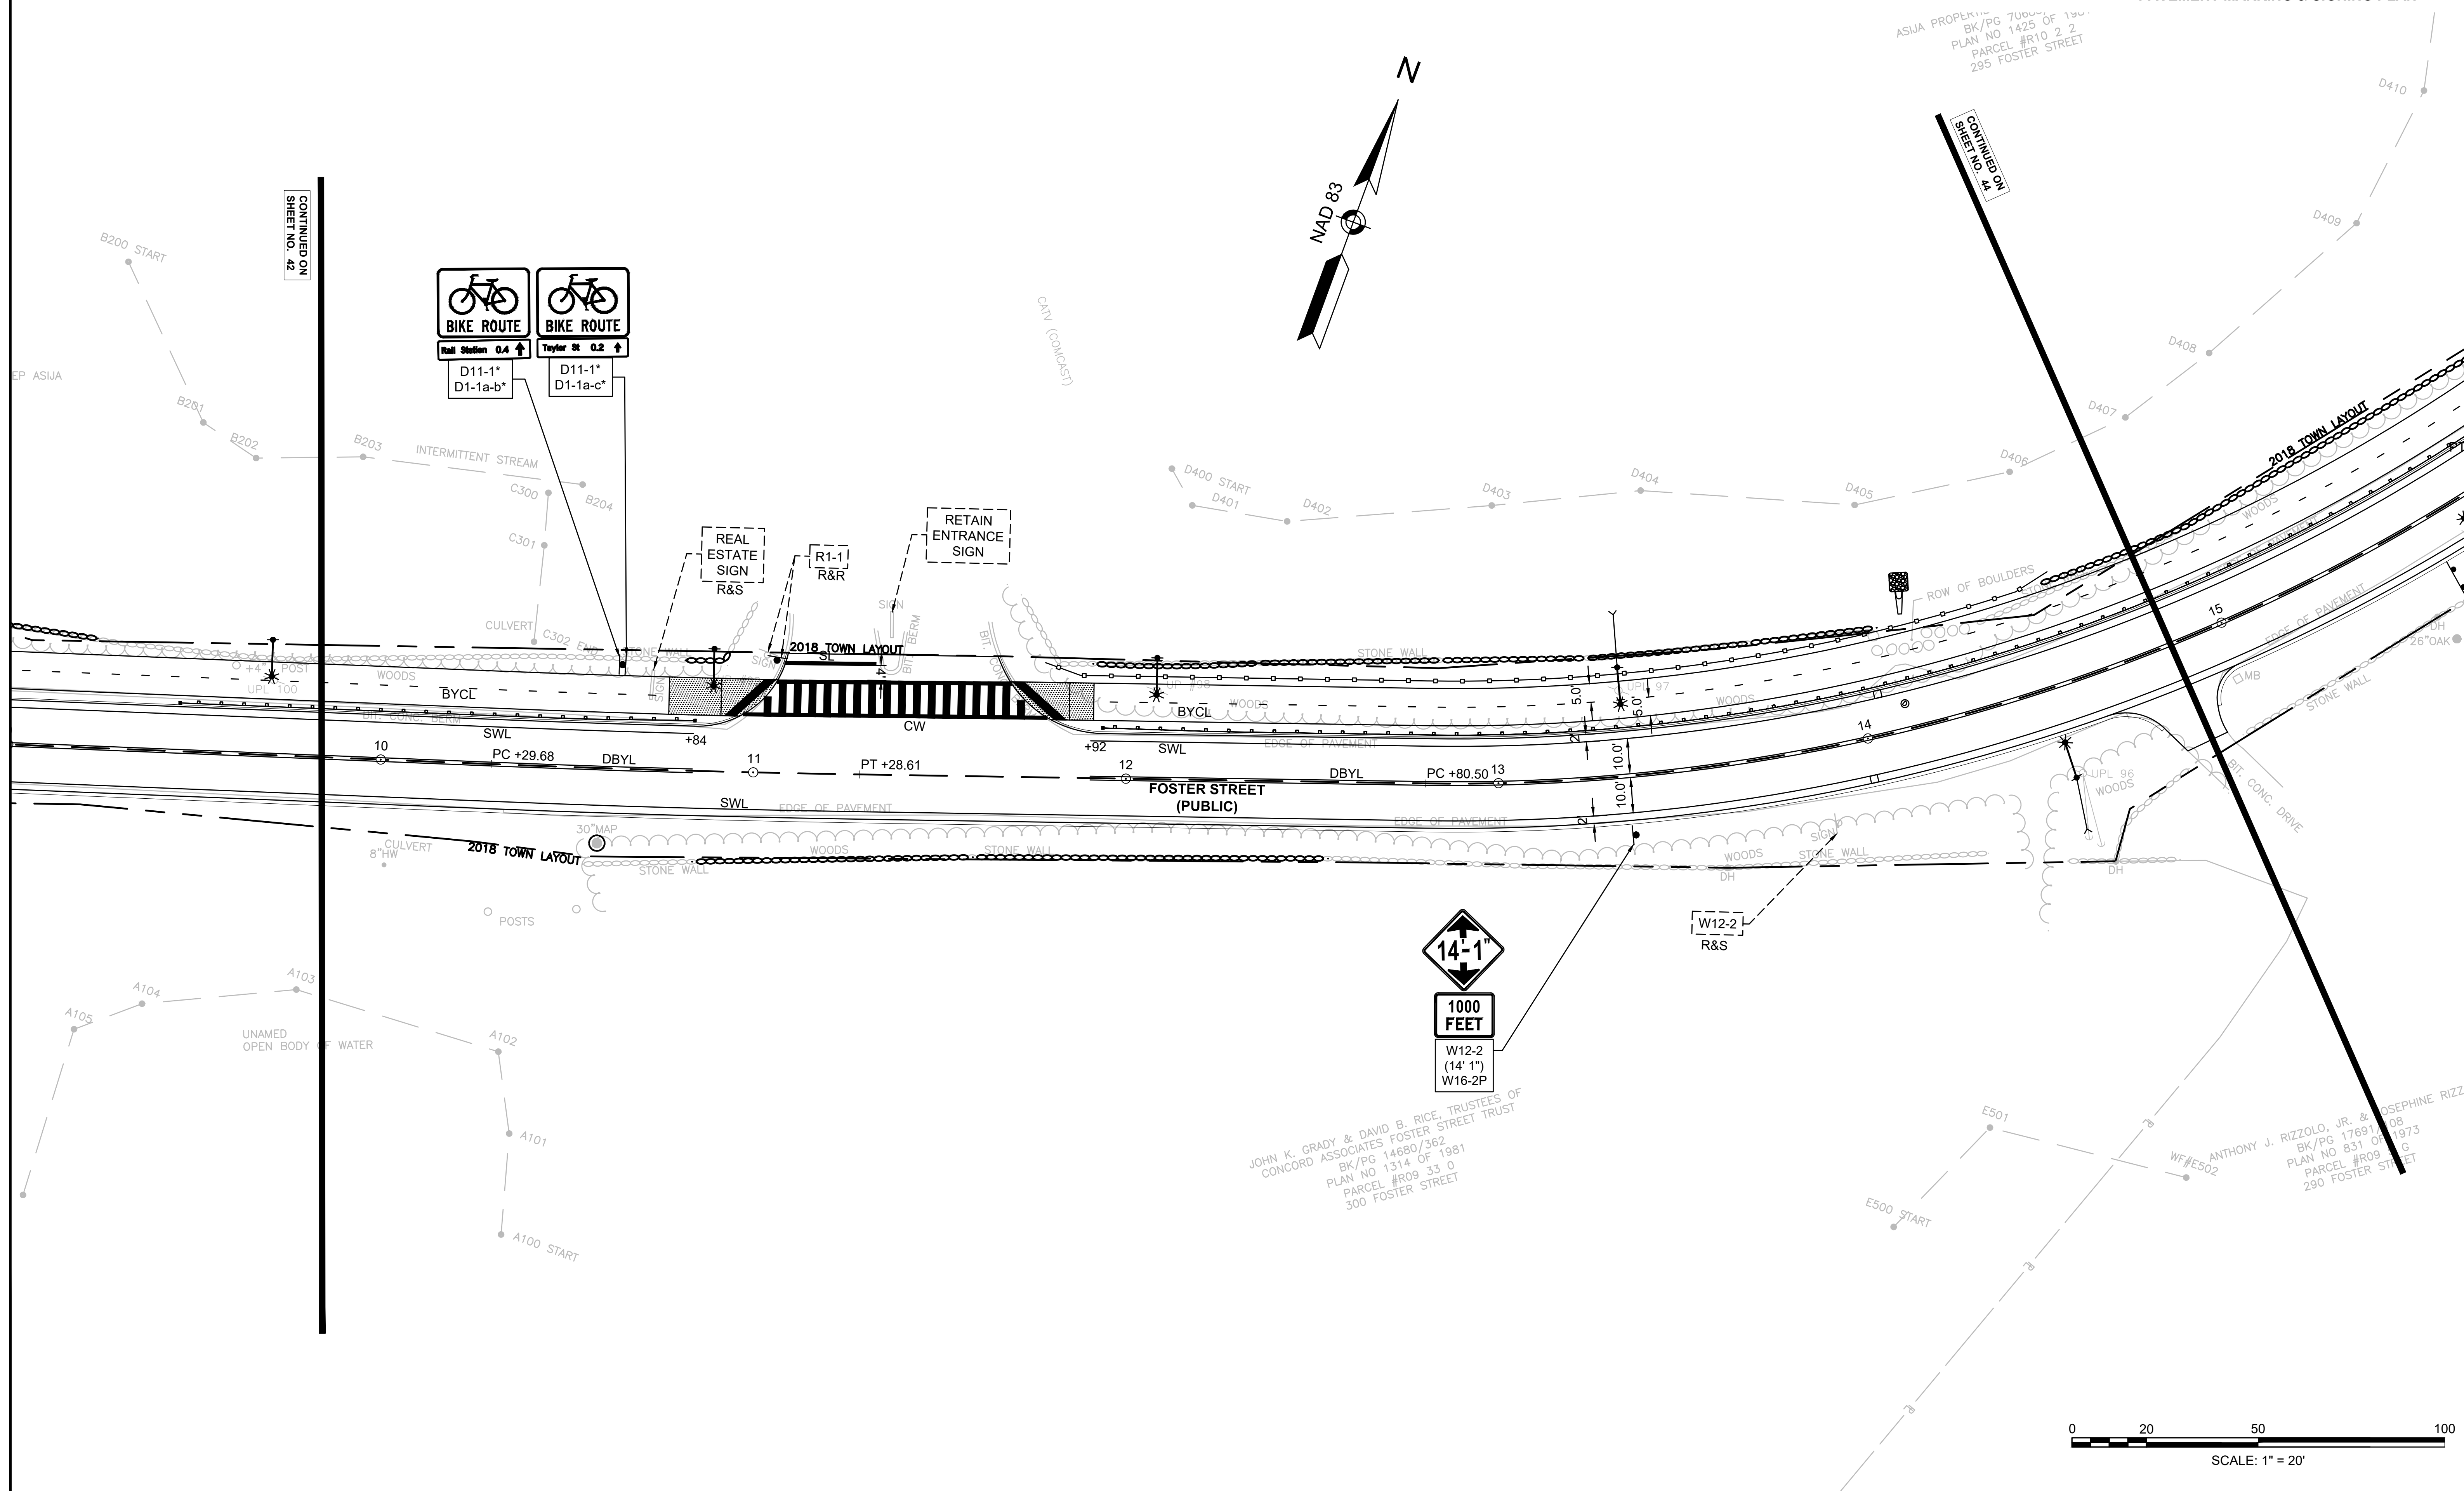



SEE SHEET 41 FOR MARKING & SIGNING NOTES

LITTLETON
RECONSTRUCTION OF FOSTER STREET

STATE	FED. AID PROJ. NO.	SHEET NO.	TOTAL SHEETS
MA	XXX-XXX(XXX)X	44	129
PROJECT FILE NO.		609054	

PAVEMENT MARKING & SIGNING PLAN


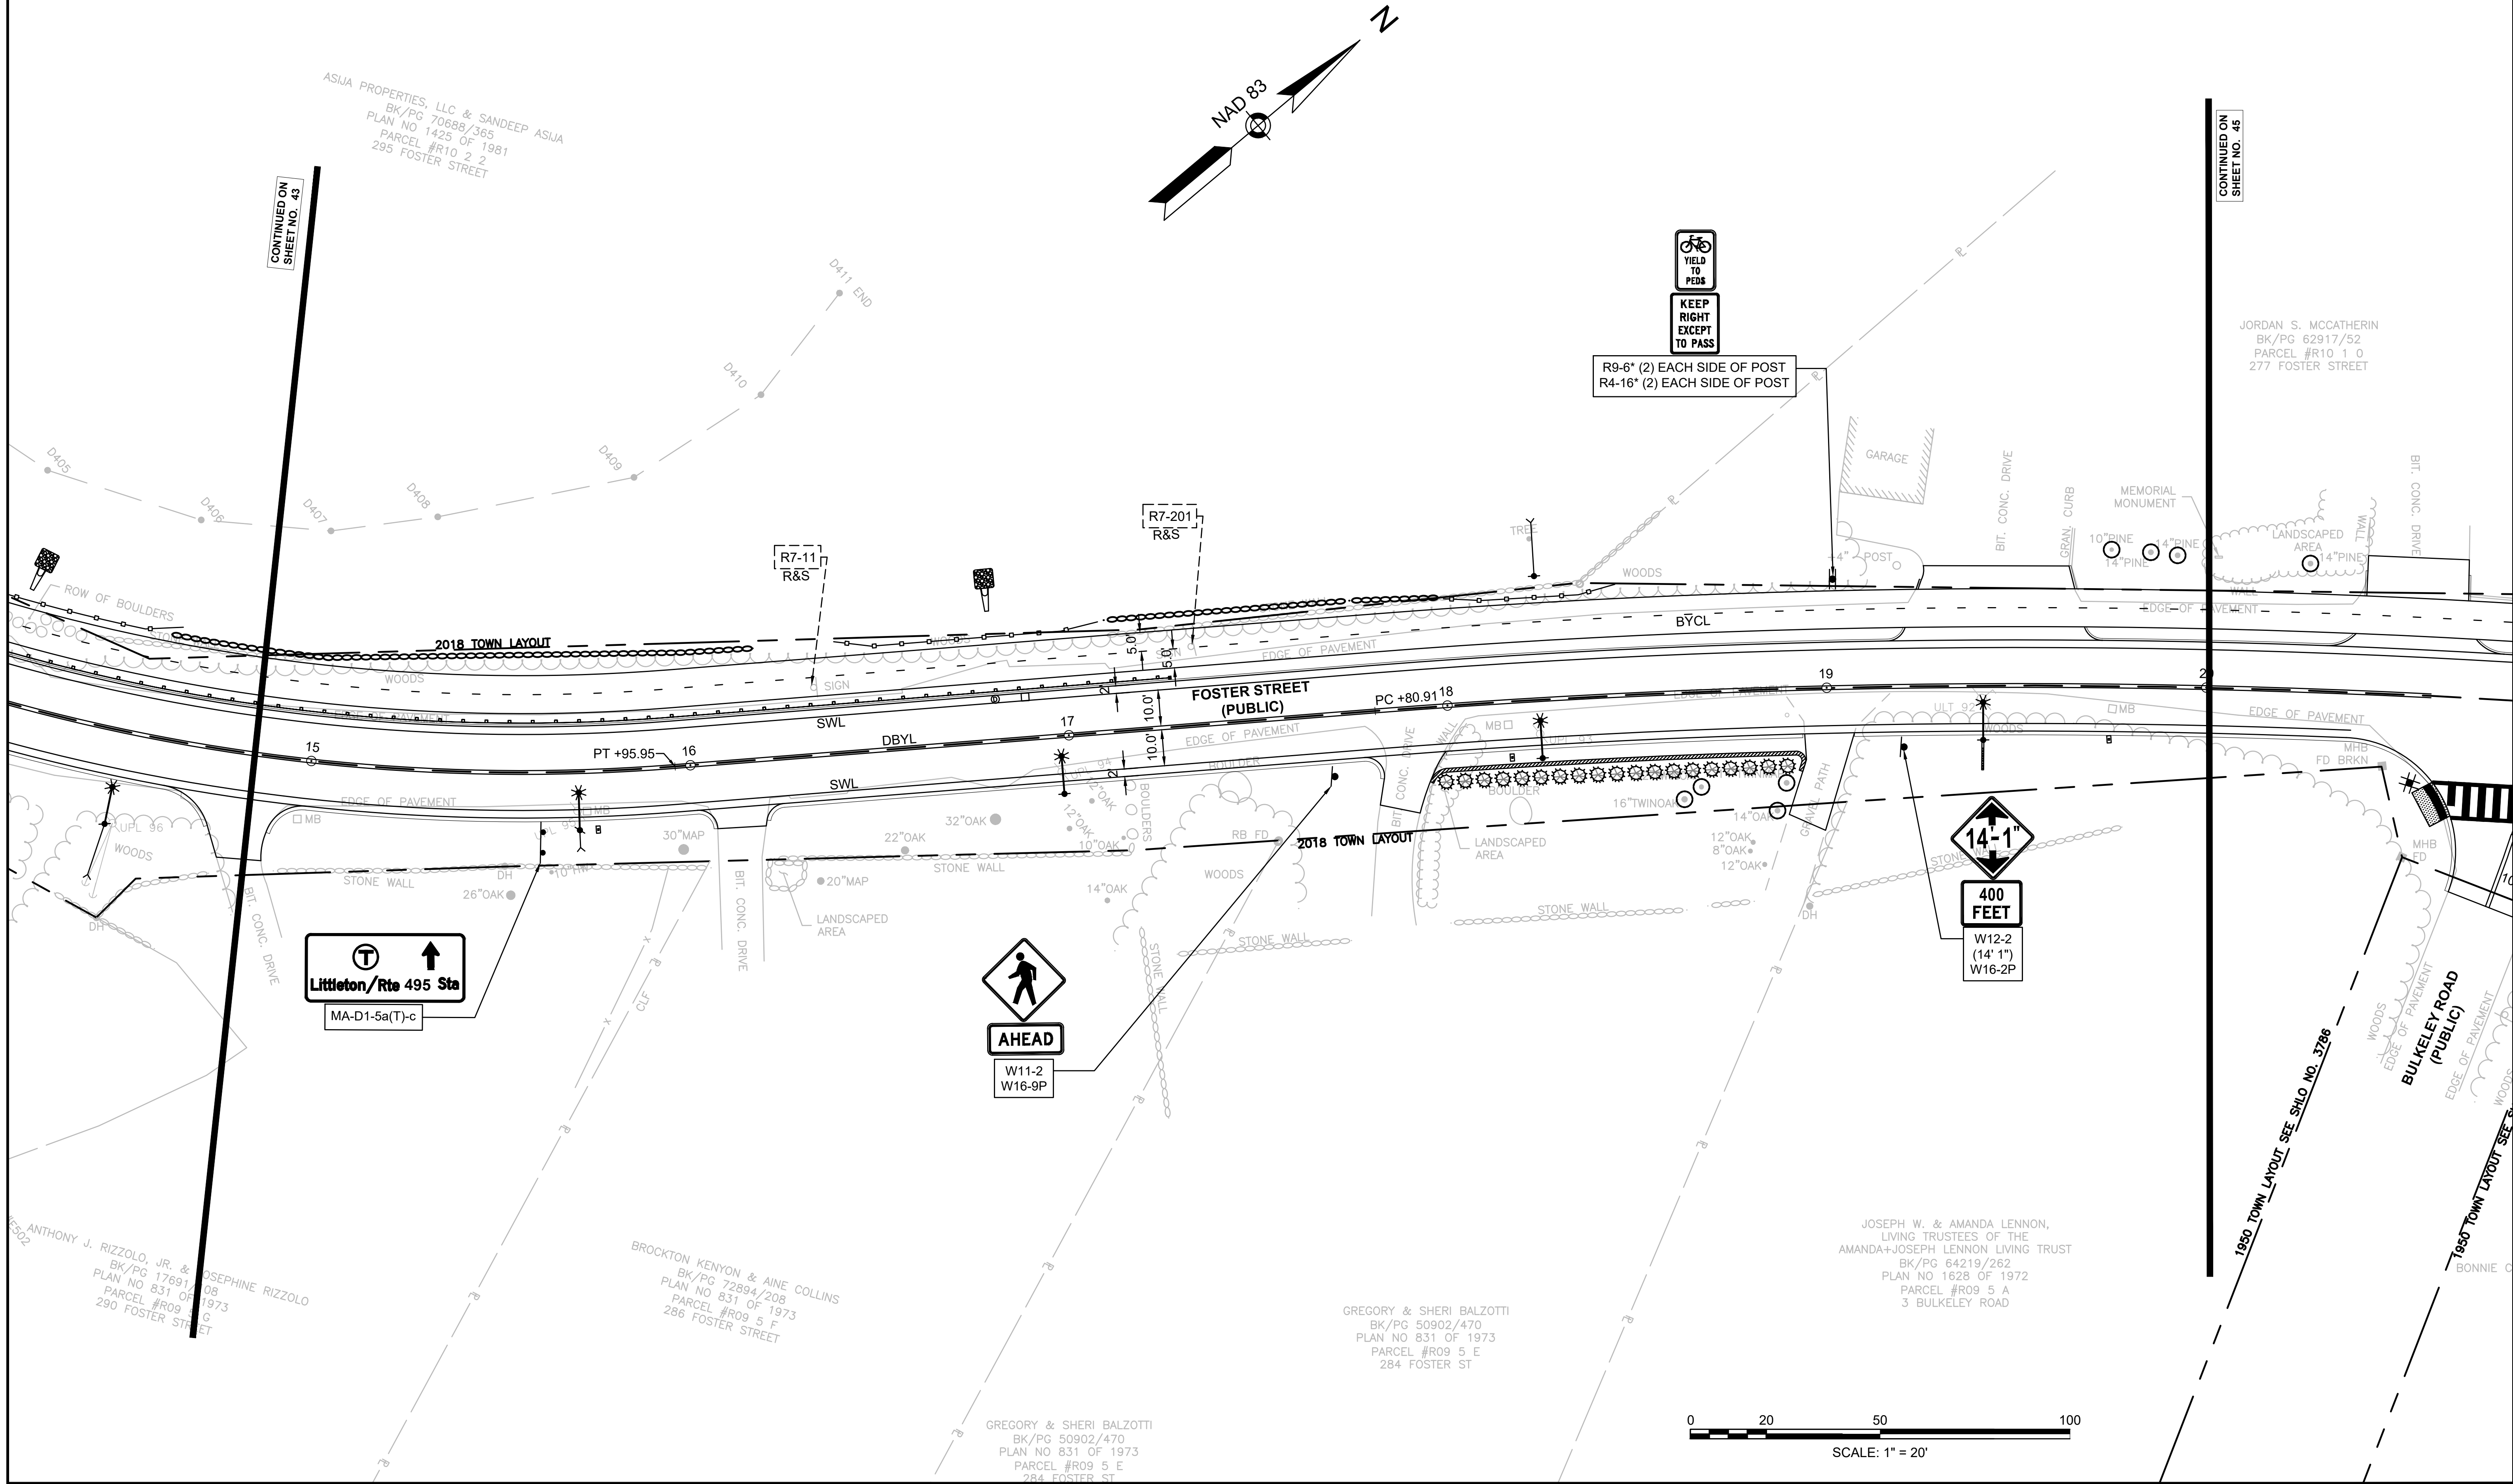


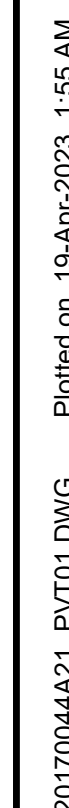

SEE SHEET 41 FOR MARKING & SIGNING NOTES

NOTES
1. REMOVE AND RESET OF THESE SIGNS SHALL BE PAID FOR UNDER ITEM 874.85


LITTLETON RECONSTRUCTION OF FOSTER STREET			
STATE	FED. AID PROJ. NO.	SHEET NO.	TOTAL SHEETS
MA	XXX-XXX(XXX)X	46	129
PROJECT FILE NO. 609054			
PAVEMENT MARKING & SIGNING PLAN			

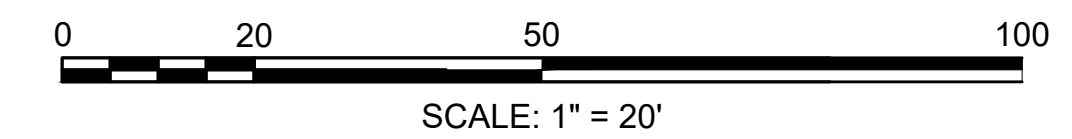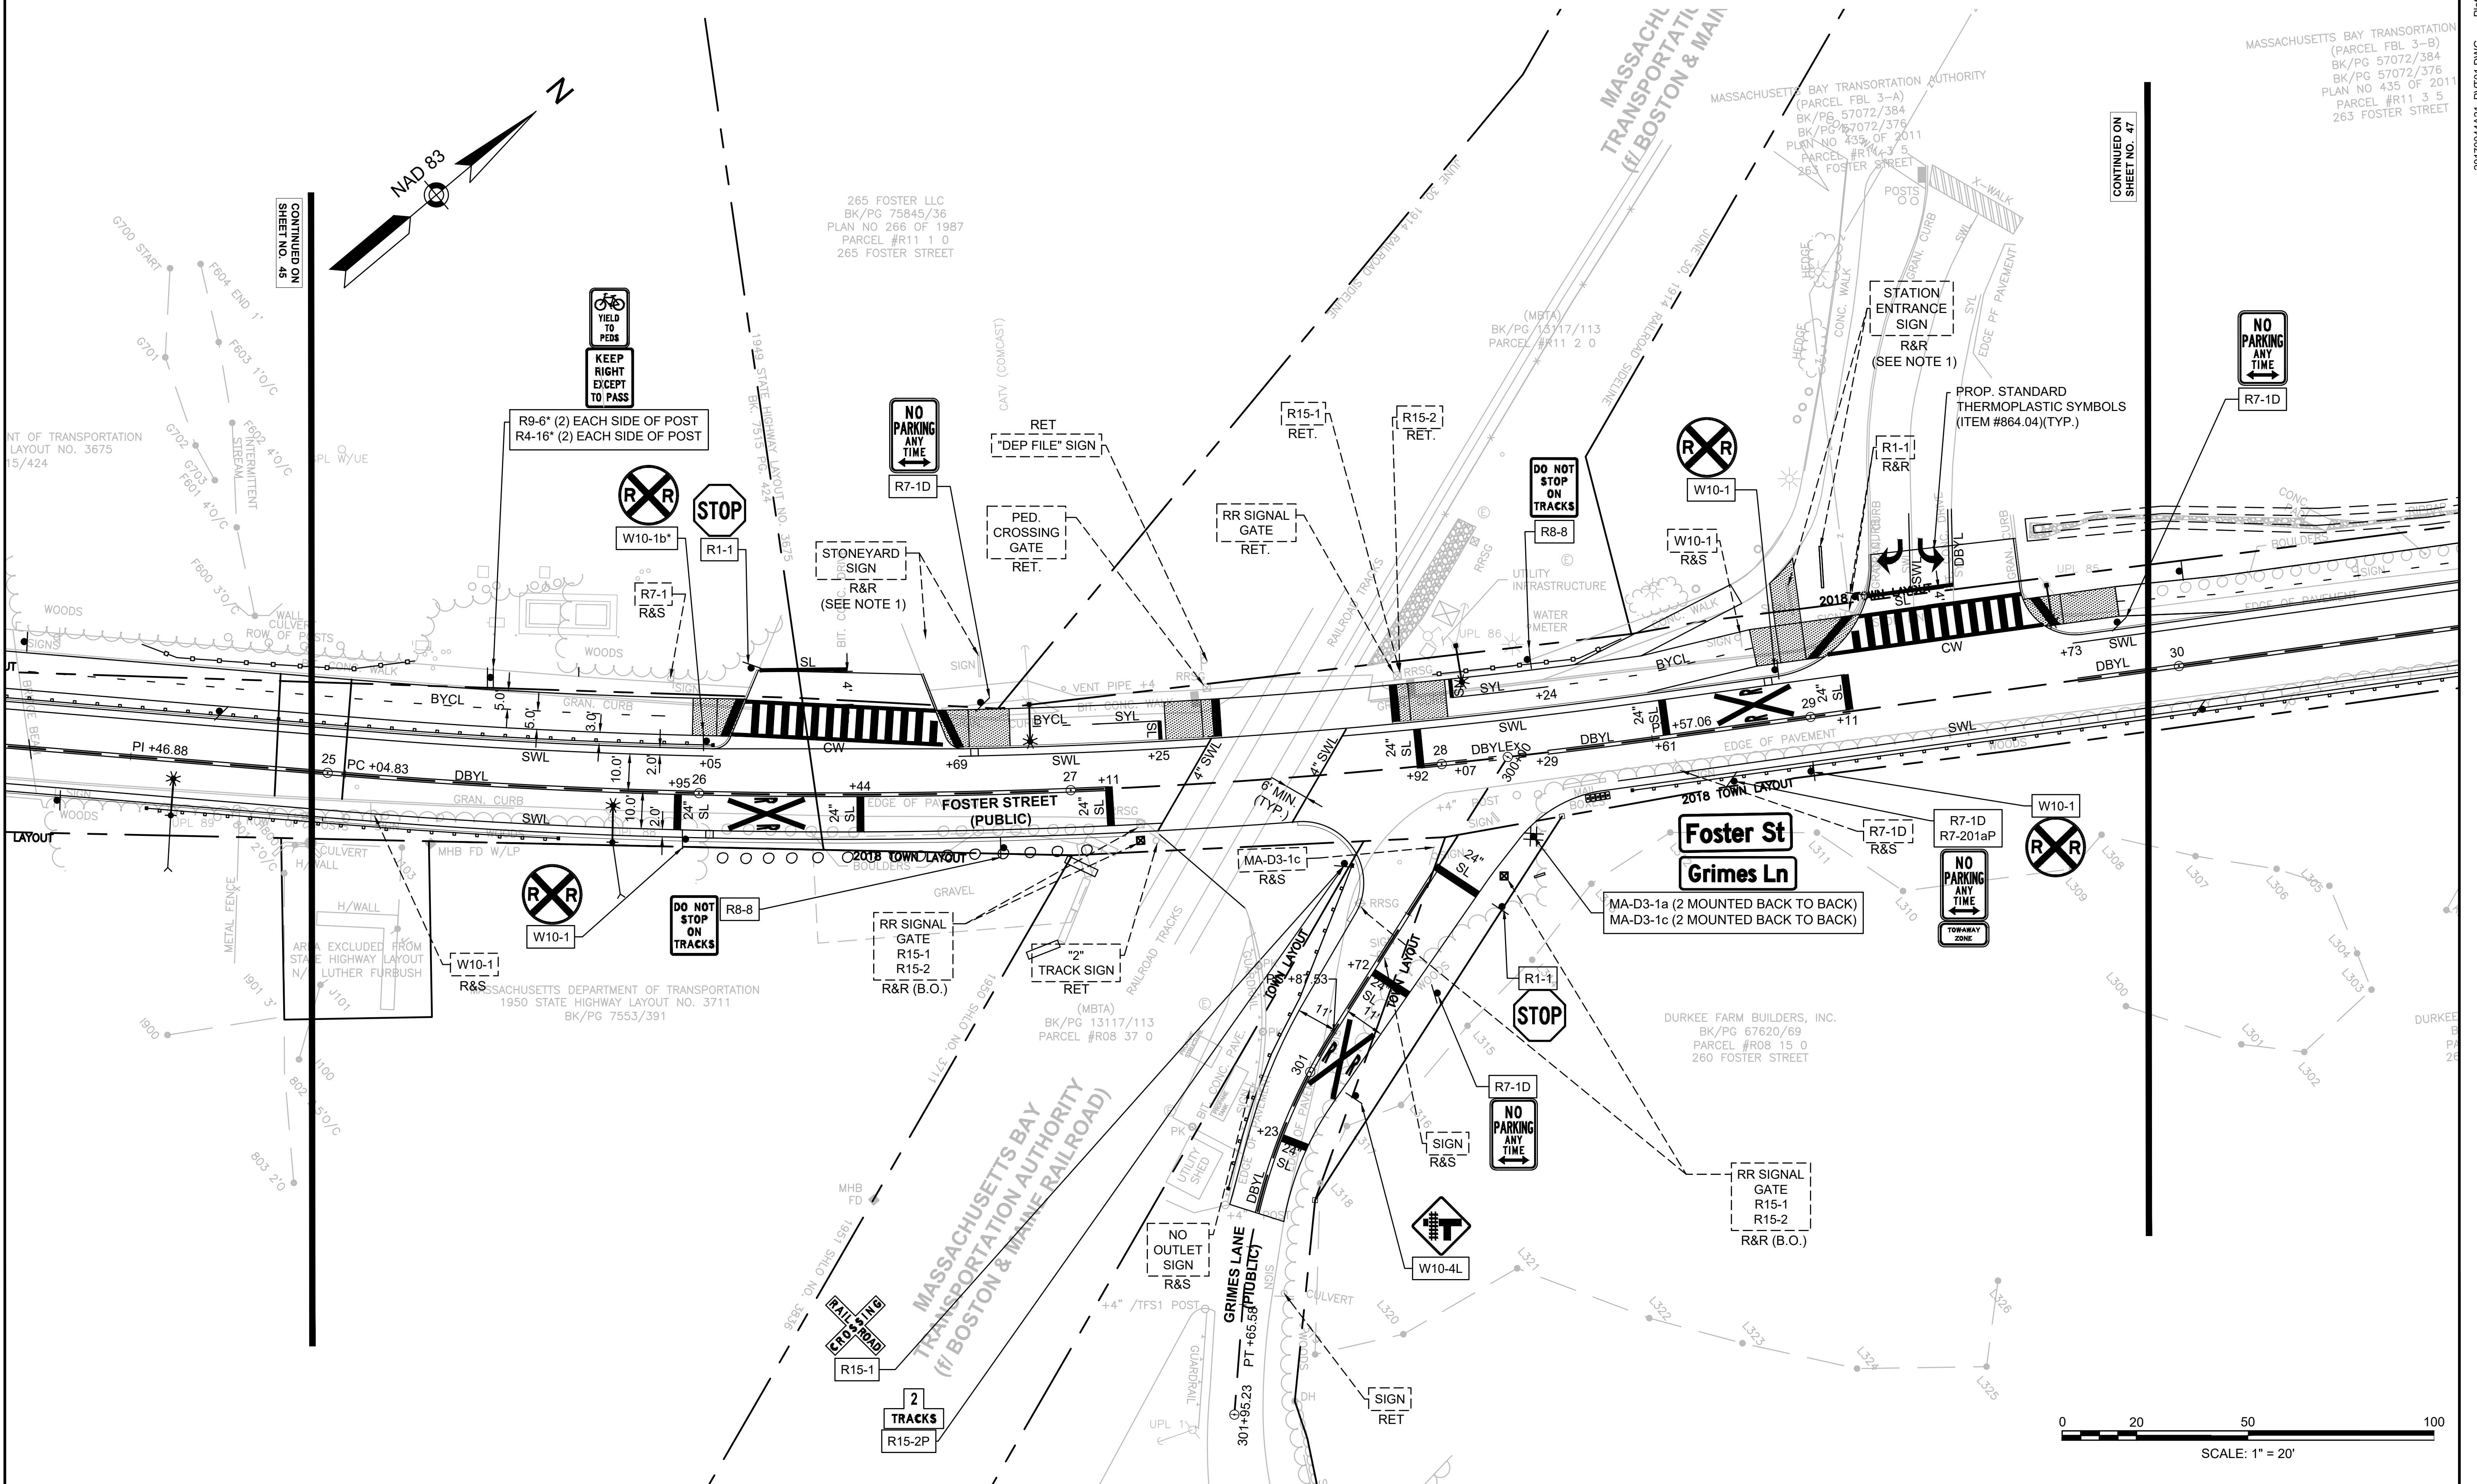

LITTLETON
RECONSTRUCTION OF FOSTER STREET

STATE	FED. AID PROJ. NO.	SHEET NO.	TOTAL SHEETS
MA	XXX-XXX(XXX)X	47	129
PROJECT FILE NO.		609054	

PAVEMENT MARKING & SIGNING PLAN

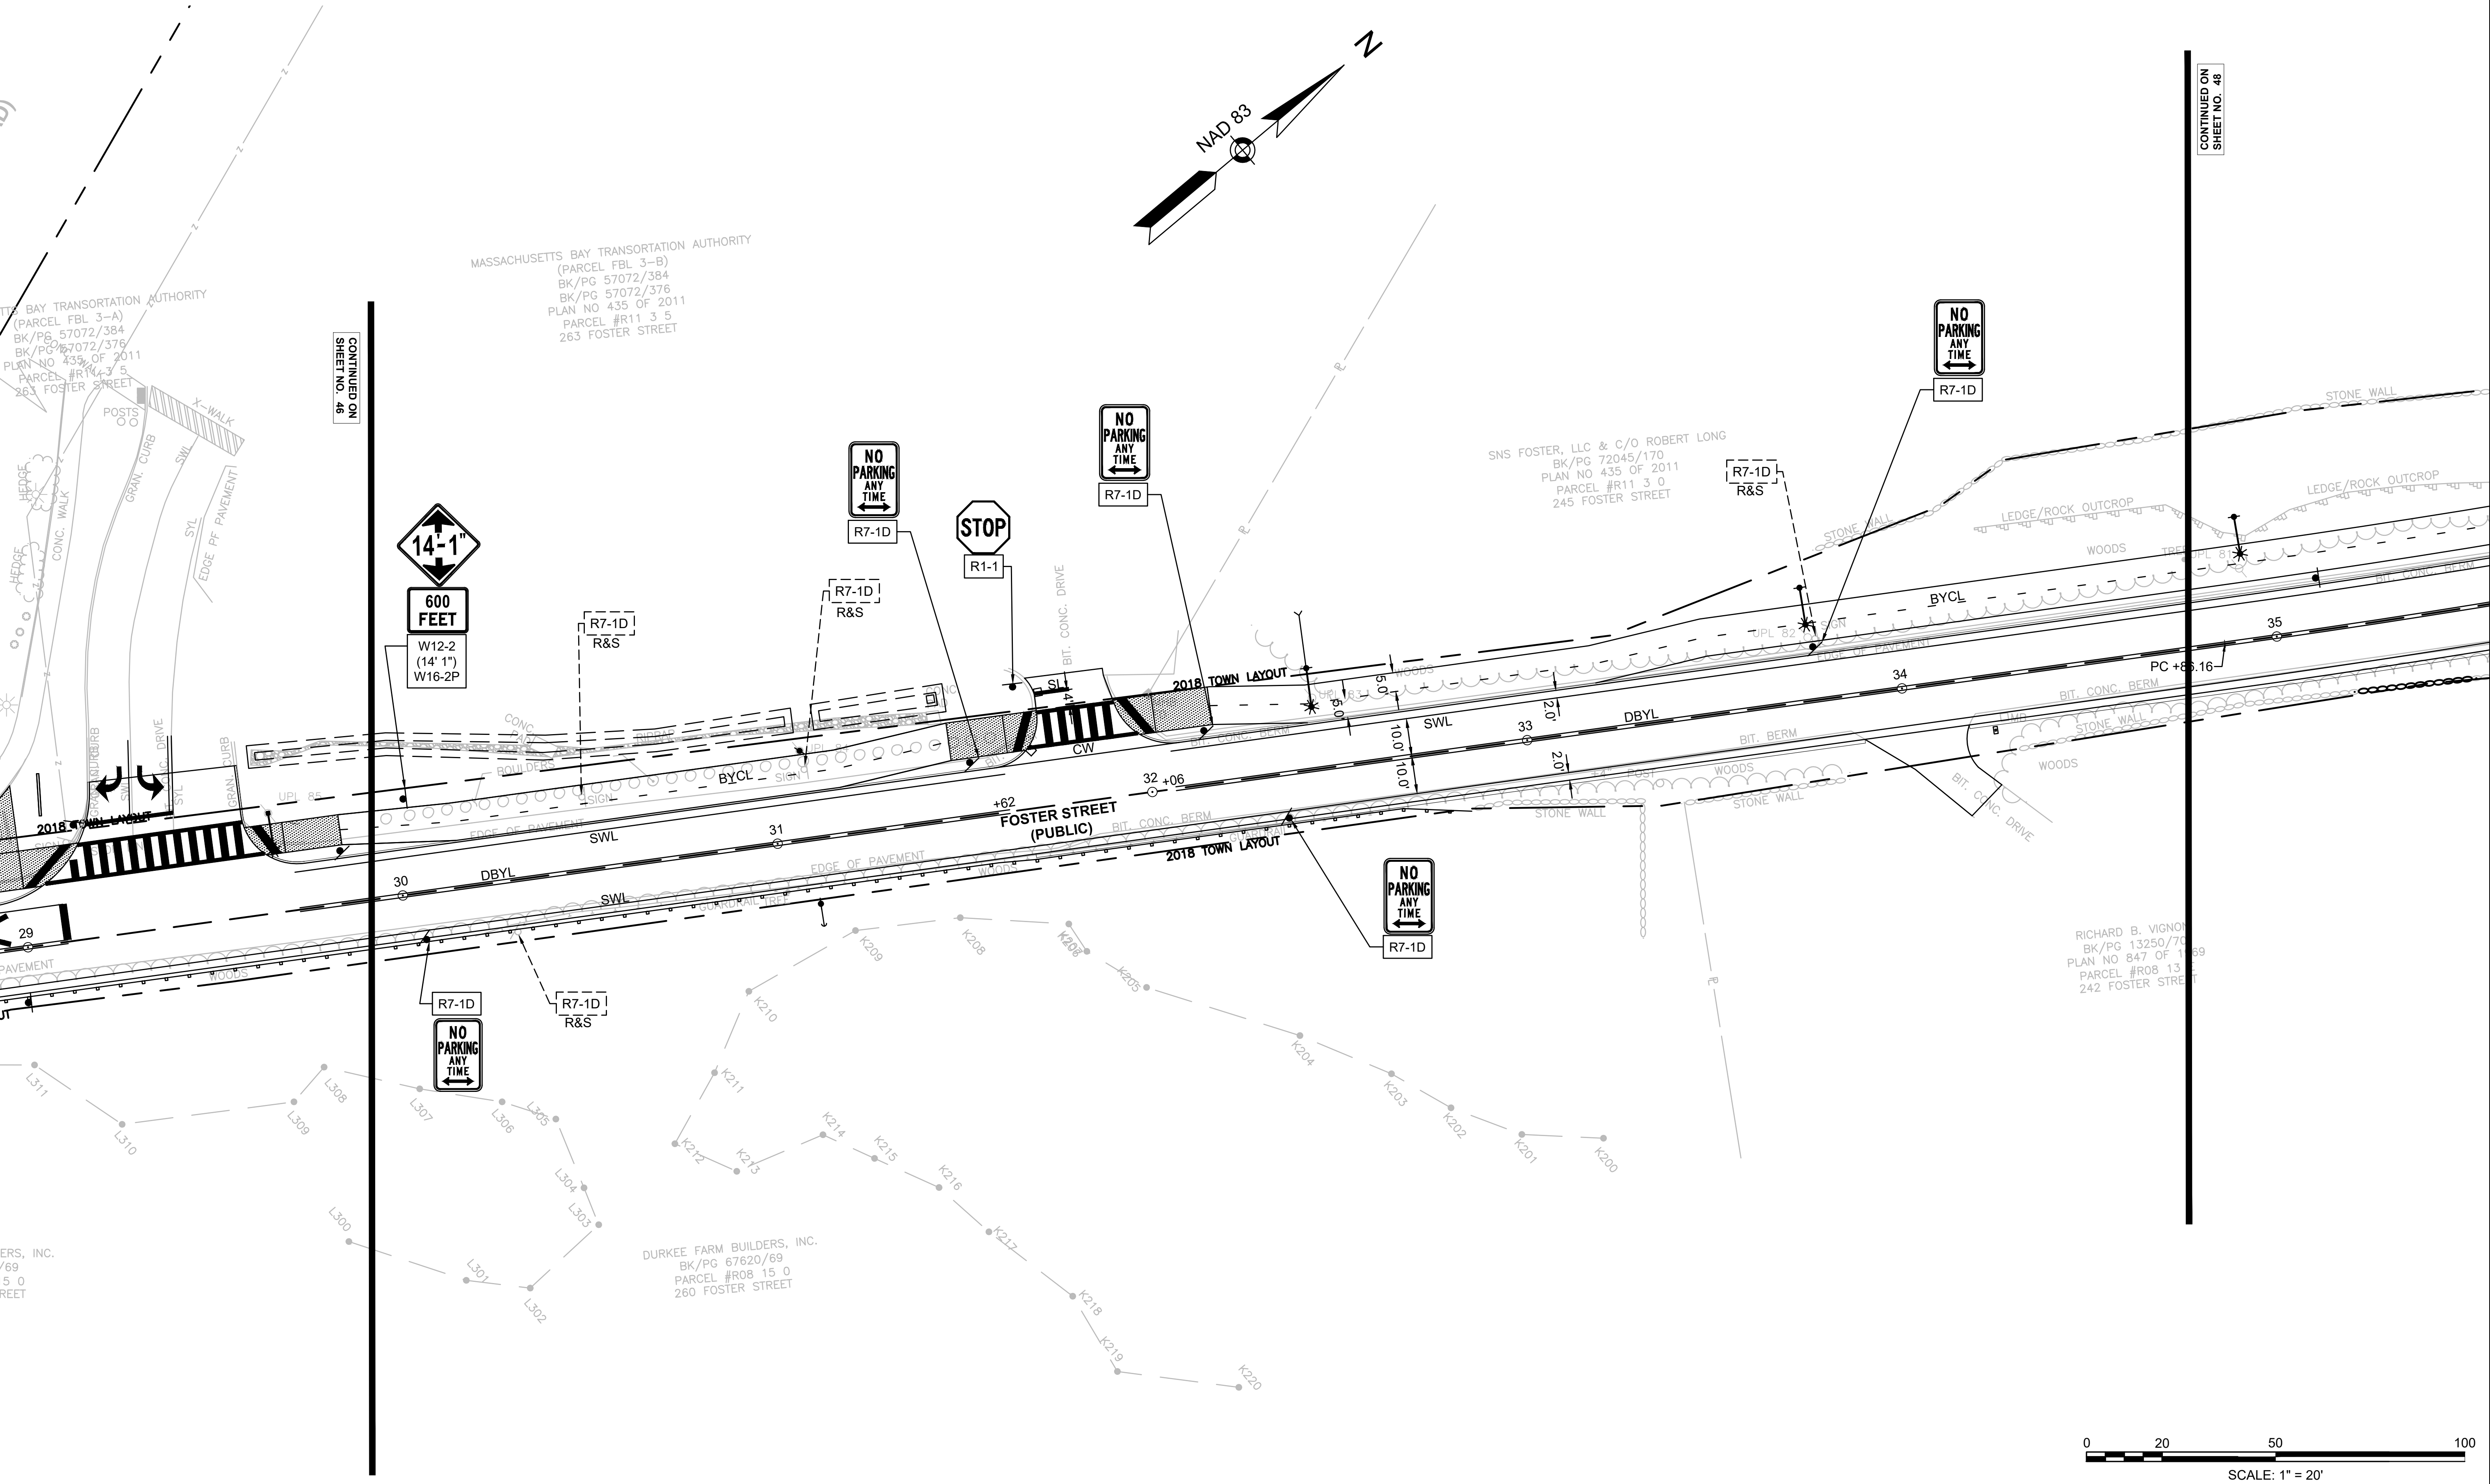


SEE SHEET 41 FOR MARKING & SIGNING NOTES

**LITTLETON
RECONSTRUCTION OF FOSTER STREET**

STATE	FED. AID PROJ. NO.	SHEET NO.	TOTAL SHEETS
MA	XXX-XXXX(XXX)X	48	129
PROJECT FILE NO.		609054	

PAVEMENT MARKING & SIGNING PLAN

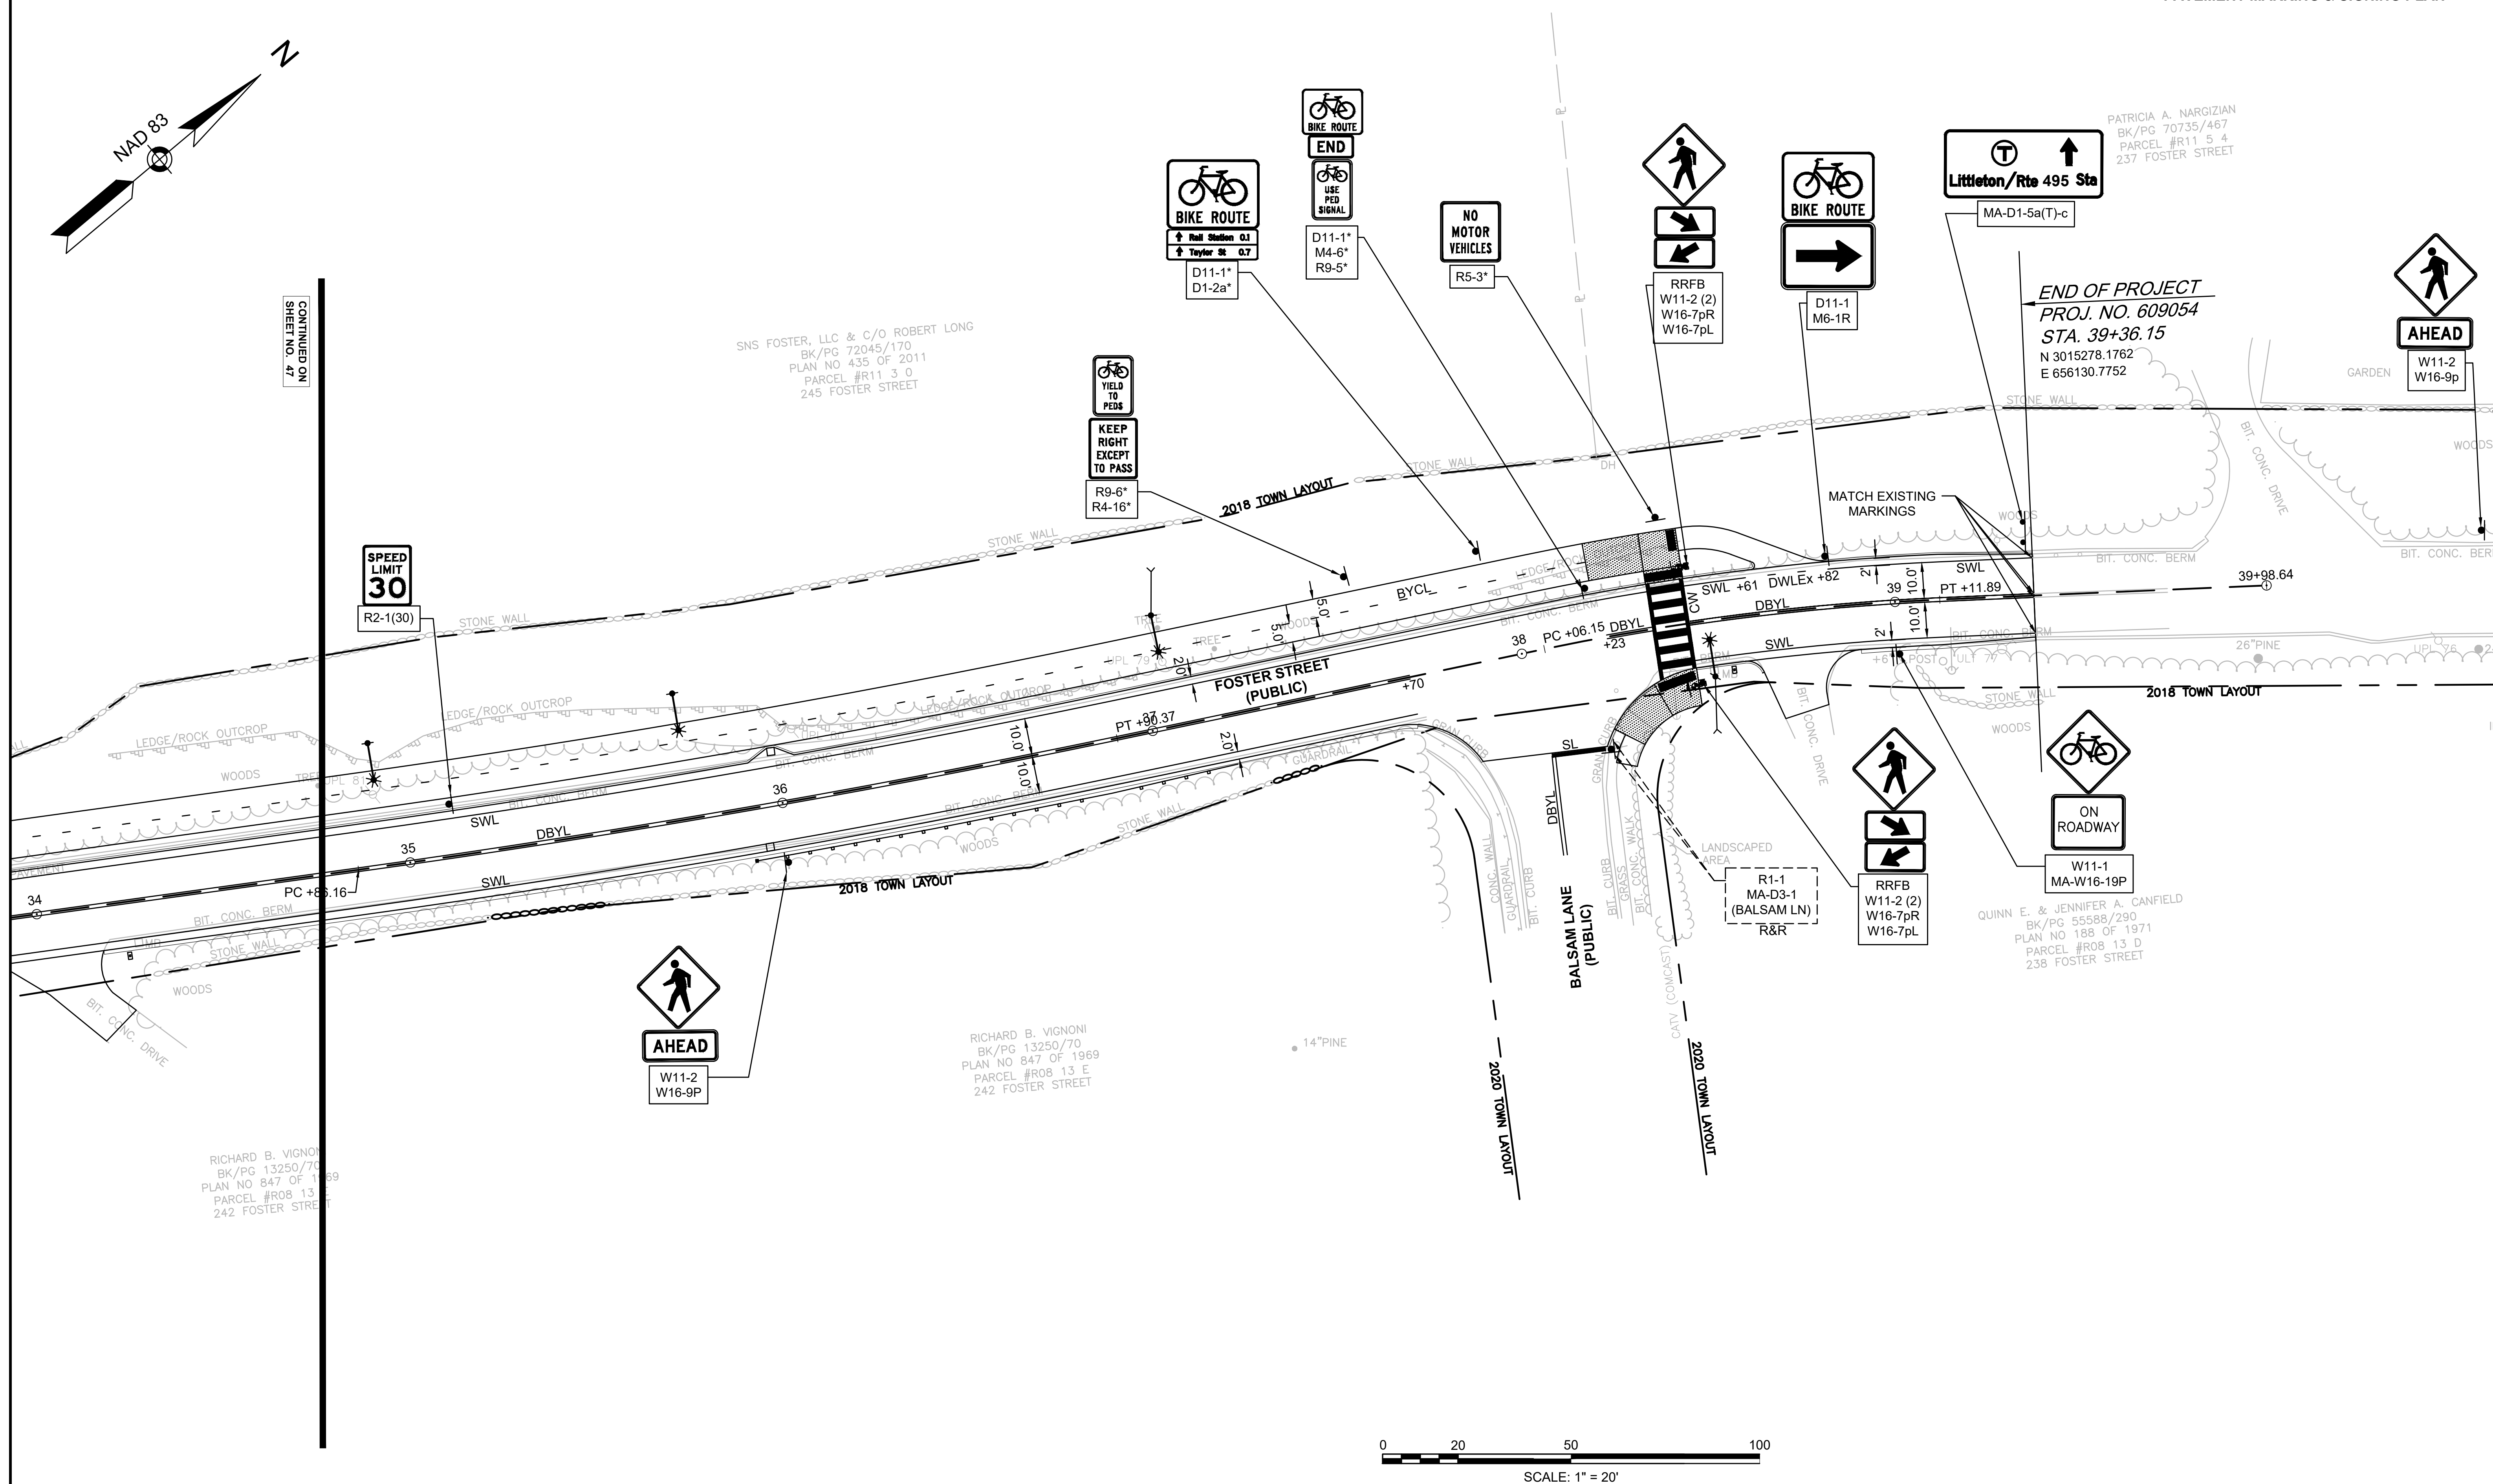

20170044A21 PVT01 DWG Plotted on 19-Apr-2023 1:55 AM

GENERAL NOTES:

- IF EXISTING PIPES SHOWN TO BE REMOVED ARE WITHIN THE LIMITS OF NEW PIPE TRENCH EXCAVATION, THEN THE REMOVAL COST OF THE OLD PIPES SHALL BE INCLUDED IN THE UNIT COST FOR THE NEW PIPE THAT IS BEING INSTALLED. IF PIPES SHOWN TO BE REMOVED ARE OUTSIDE THE LIMITS OF NEW PIPE TRENCH (AS DETERMINED BY THE ENGINEER), THEN REMOVAL COST SHALL BE PAID UNDER ITEM 141. CLASS A TRENCH EXCAVATION.
- ALL PROPOSED (NEW) CATCH BASINS SHALL HAVE 4' SUMPS.
- ALL CATCH BASINS WITHIN THE PAVED ROADWAY SHALL HAVE CASCADE STYLE/BICYCLE SAFE GRATES UNLESS OTHERWISE NOTED ON THE PLANS.
- ALL ELEVATIONS, STATIONS, AND OFFSETS FOR ALL CATCH BASINS AND DRAINAGE MANHOLES COME FROM CENTER OF COVER OR GRATE.
- CONTRACTOR SHALL USE APPROPRIATELY SIZED RCP TO MATCH INTO EXISTING PIPES AS SHOWN.

ELECTRICAL NOTES:

- CONTRACTOR SHALL COORDINATE WITH LITTLETON LIGHT AND ELECTRIC DEPT. (LELD) ON THE TIMING OF TRANSFER FOR PRIMARY RISER AT UTILITY POLES #78, 99, 104, AND 105. DISRUPTION TO COMMERCIAL PROPERTIES SHALL BE MINIMIZED BY WEEKEND WORK OR THE USE OF GENERATORS.


TREE TRIMMING NOTES:

- LIMITS OF SELECTIVE CLEARING AND THINNING SHALL BE 10FT OFFSET BACK FROM ANY RESET OHW OR AS SHOWN ON CONSTRUCTION PLANS.

LITTLETON
RECONSTRUCTION OF FOSTER STREET

STATE	FED. AID PROJ. NO.	SHEET NO.	TOTAL SHEETS
MA	XXX-XXX(XXX)X	57	129
PROJECT FILE NO. 609054			

DRAINAGE & UTILITY PLANS REVISED 5/26/2022

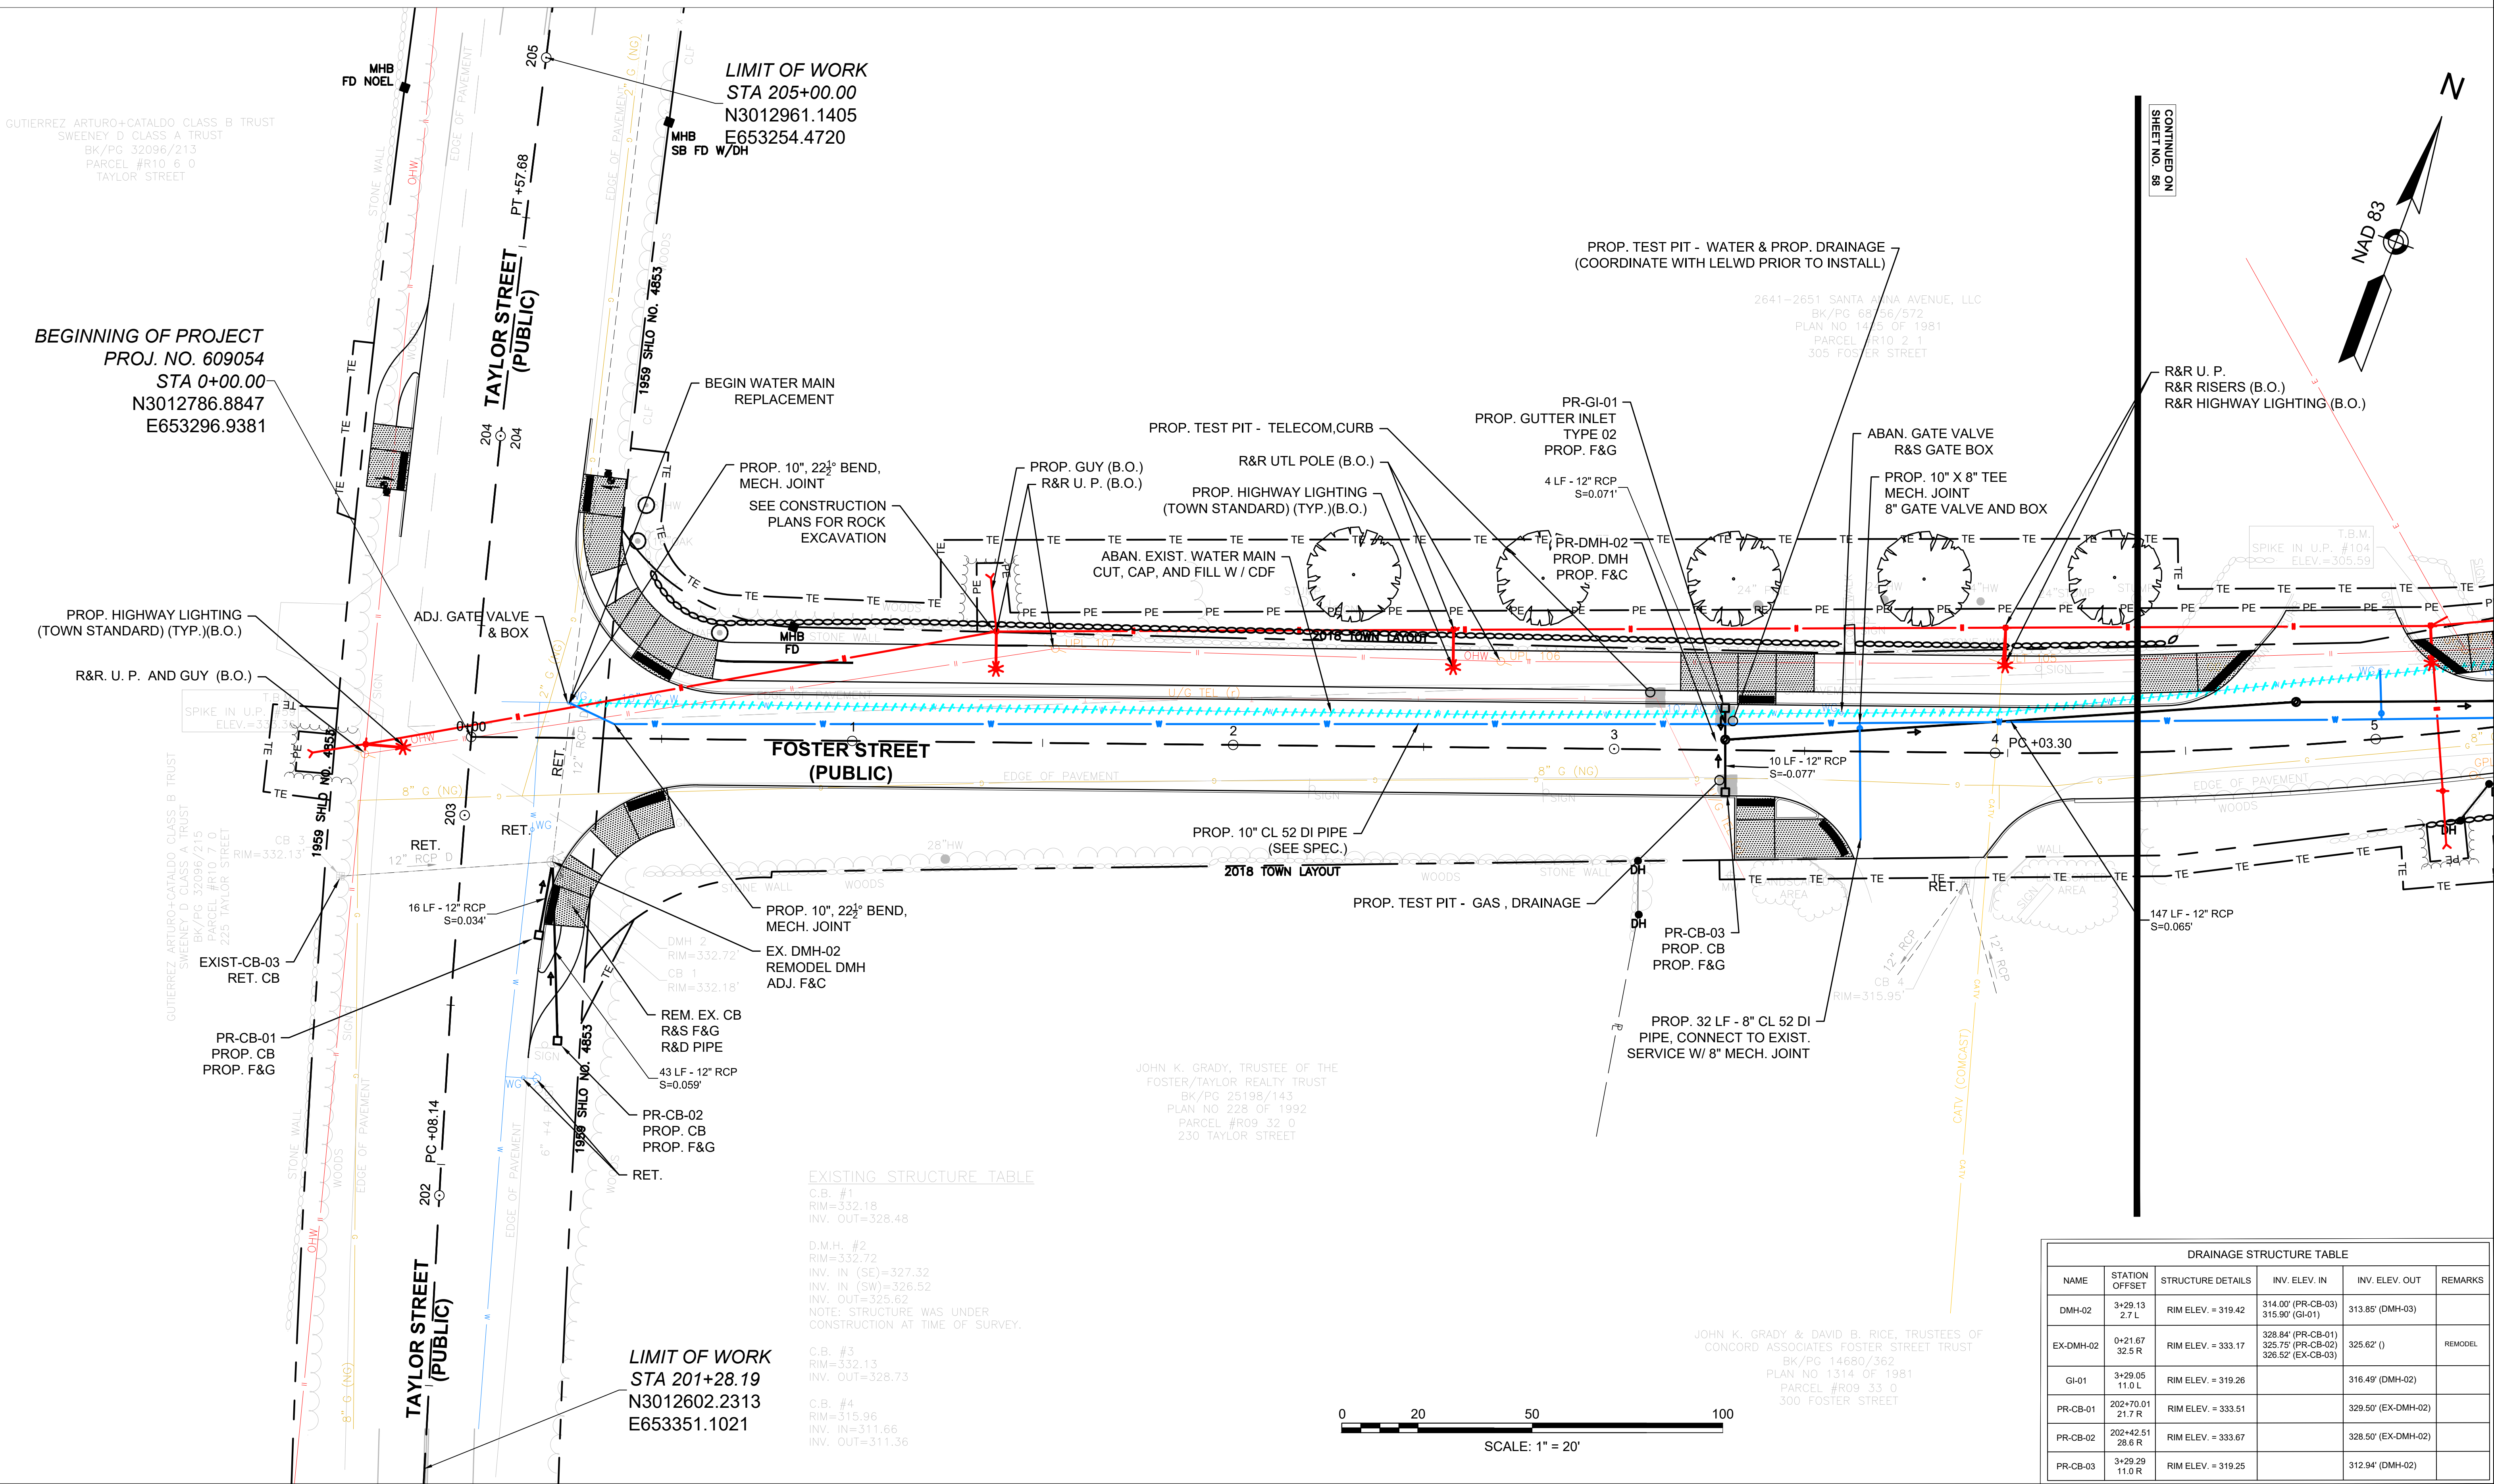


DRAINAGE STRUCTURE TABLE					
NAME	STATION OFFSET	STRUCTURE DETAILS	INV. ELEV. IN	INV. ELEV. OUT	REMARKS
DMH-02	3+29.13 2.7 L	RIM ELEV. = 319.42	314.00' (PR-CB-03) 315.90' (GI-01)	313.85' (DMH-03)	
EX-DMH-02	0+21.67 32.5 R	RIM ELEV. = 333.17	328.94' (PR-CB-01) 325.75' (PR-CB-02) 326.52' (EX-CB-03)	325.62' (I)	REMODEL
GI-01	3+29.05 11.0 L	RIM ELEV. = 319.26		316.49' (DMH-02)	
PR-CB-01	202+70.01 21.7 R	RIM ELEV. = 333.51		329.50' (EX-DMH-02)	
PR-CB-02	202+42.51 28.6 R	RIM ELEV. = 333.67		328.50' (EX-DMH-02)	
PR-CB-03	3+29.29 11.0 R	RIM ELEV. = 319.25		312.94' (DMH-02)	

- NOTES:
- SEE SHEET 57 FOR GENERAL UTILITY, ELECTRICAL AND TREE TRIMMING NOTES
 - * - CONTRACTOR TO MATCH EXISTING PIPE INVERT. INVERT GIVEN IS APPROXIMATE

LITTLETON
RECONSTRUCTION OF FOSTER STREET

STATE	FED. AID PROJ. NO.	SHEET NO.	TOTAL SHEETS
MA	XXX-XXX(XXX)X	58	129
PROJECT FILE NO.		609054	

DRAINAGE & UTILITY PLANS REVISED 5/26/2022

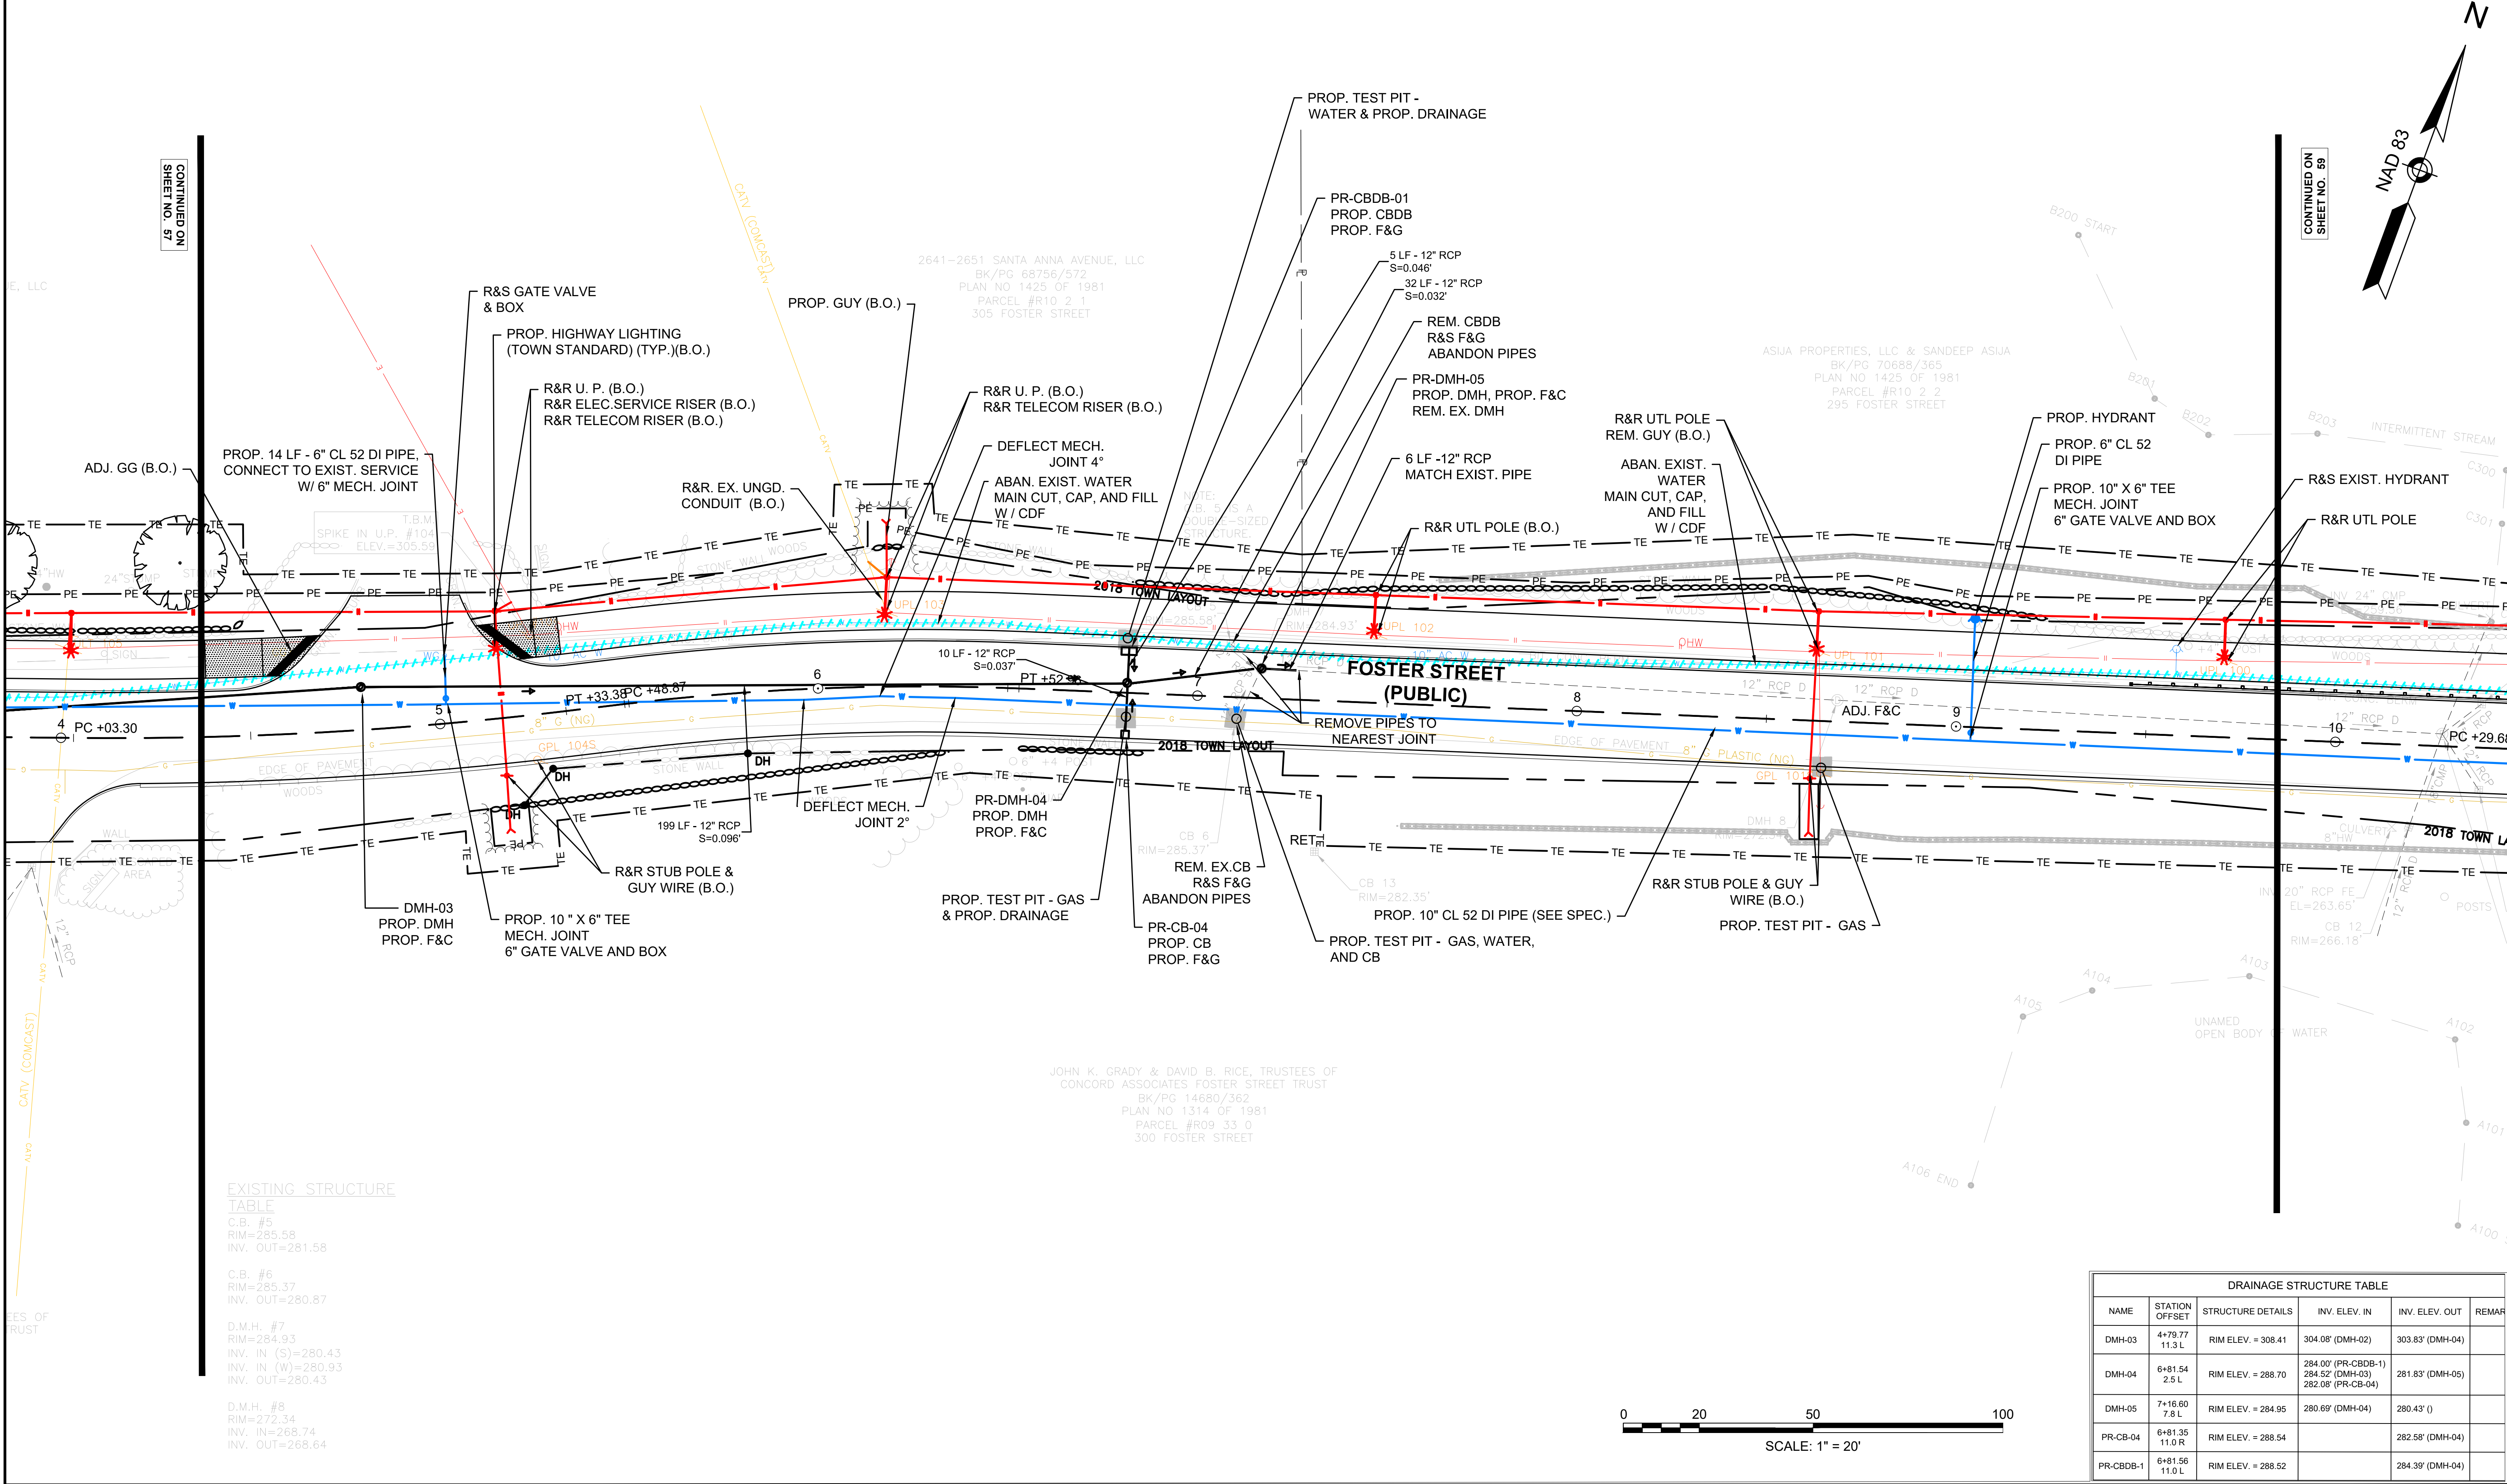

- | LITTLETON | | | |
|---------------------------------|--------------------|-----------|--------------|
| RECONSTRUCTION OF FOSTER STREET | | | |
| STATE | FED. AID PROJ. NO. | SHEET NO. | TOTAL SHEETS |
| MA | XXX-XXXX(XXX)X | 59 | 129 |
| PROJECT FILE NO. | | 609054 | |

EXISTING STRUCTURE TABLE

STRUCTURE	INVERT	OUTLET
C.B. #9	265.69	261.39
C.B. #10	265.16	261.66
C.B. #11	265.34	261.34
C.B. #12	266.18	264.18
C.B. #13	282.35	263.48
C.B. #14	254.44	250.94
C.B. #15	254.65	250.98
C.B. #16	253.58	250.38

DRAINAGE STRUCTURE TABLE

NAME	STATION	STRUCTURE DETAILS	INV. ELEV. IN	INV. ELEV. OUT	REMARKS
DMH-06	14+11.89	RIM ELEV. = 255.23	250.67' (PR-CB-06)	250.57' (FE-01)	
FE-01	14+16.61	RIM ELEV. = 251.75	250.08' (DMH-06)		
PR-CB-05	13+99.37	RIM ELEV. = 255.31		250.85' (DMH-06)	
PR-CB-06	14+05.22	RIM ELEV. = 255.23		250.94' (DMH-06)	


DRAINAGE STRUCTURE TABLE					
NAME	STATION OFFSET	STRUCTURE DETAILS	INV. ELEV. IN	INV. ELEV. OUT	REMARKS
DMH-06	14+11.89 6.8 L	RIM ELEV. = 255.23	250.67* (PR-CB-06) 250.67* (PR-CB-05)	250.57* (FE-01)	
FE-01	14+16.61 30.5 L	RIM ELEV. = 251.75	250.08* (DMH-06)		
PR-CB-05	13+99.37 11.0 R	RIM ELEV. = 255.31		250.85* (DMH-06)	
PR-CB-06	14+05.22 11.0 L	RIM ELEV. = 255.23		250.94* (DMH-06)	

- NOTES:
- SEE SHEET 57 FOR GENERAL UTILITY, ELECTRICAL AND TREE TRIMMING NOTES
 - * - CONTRACTOR TO MATCH EXISTING PIPE INVERT. INVERT GIVEN IS APPROXIMATE

LITTLETON
RECONSTRUCTION OF FOSTER STREET

STATE	FED. AID PROJ. NO.	SHEET NO.	TOTAL SHEETS
MA	XXX-XXX(XXX)X	60	129
PROJECT FILE NO. 609054			

DRAINAGE & UTILITY PLANS REVISED 5/26/2022

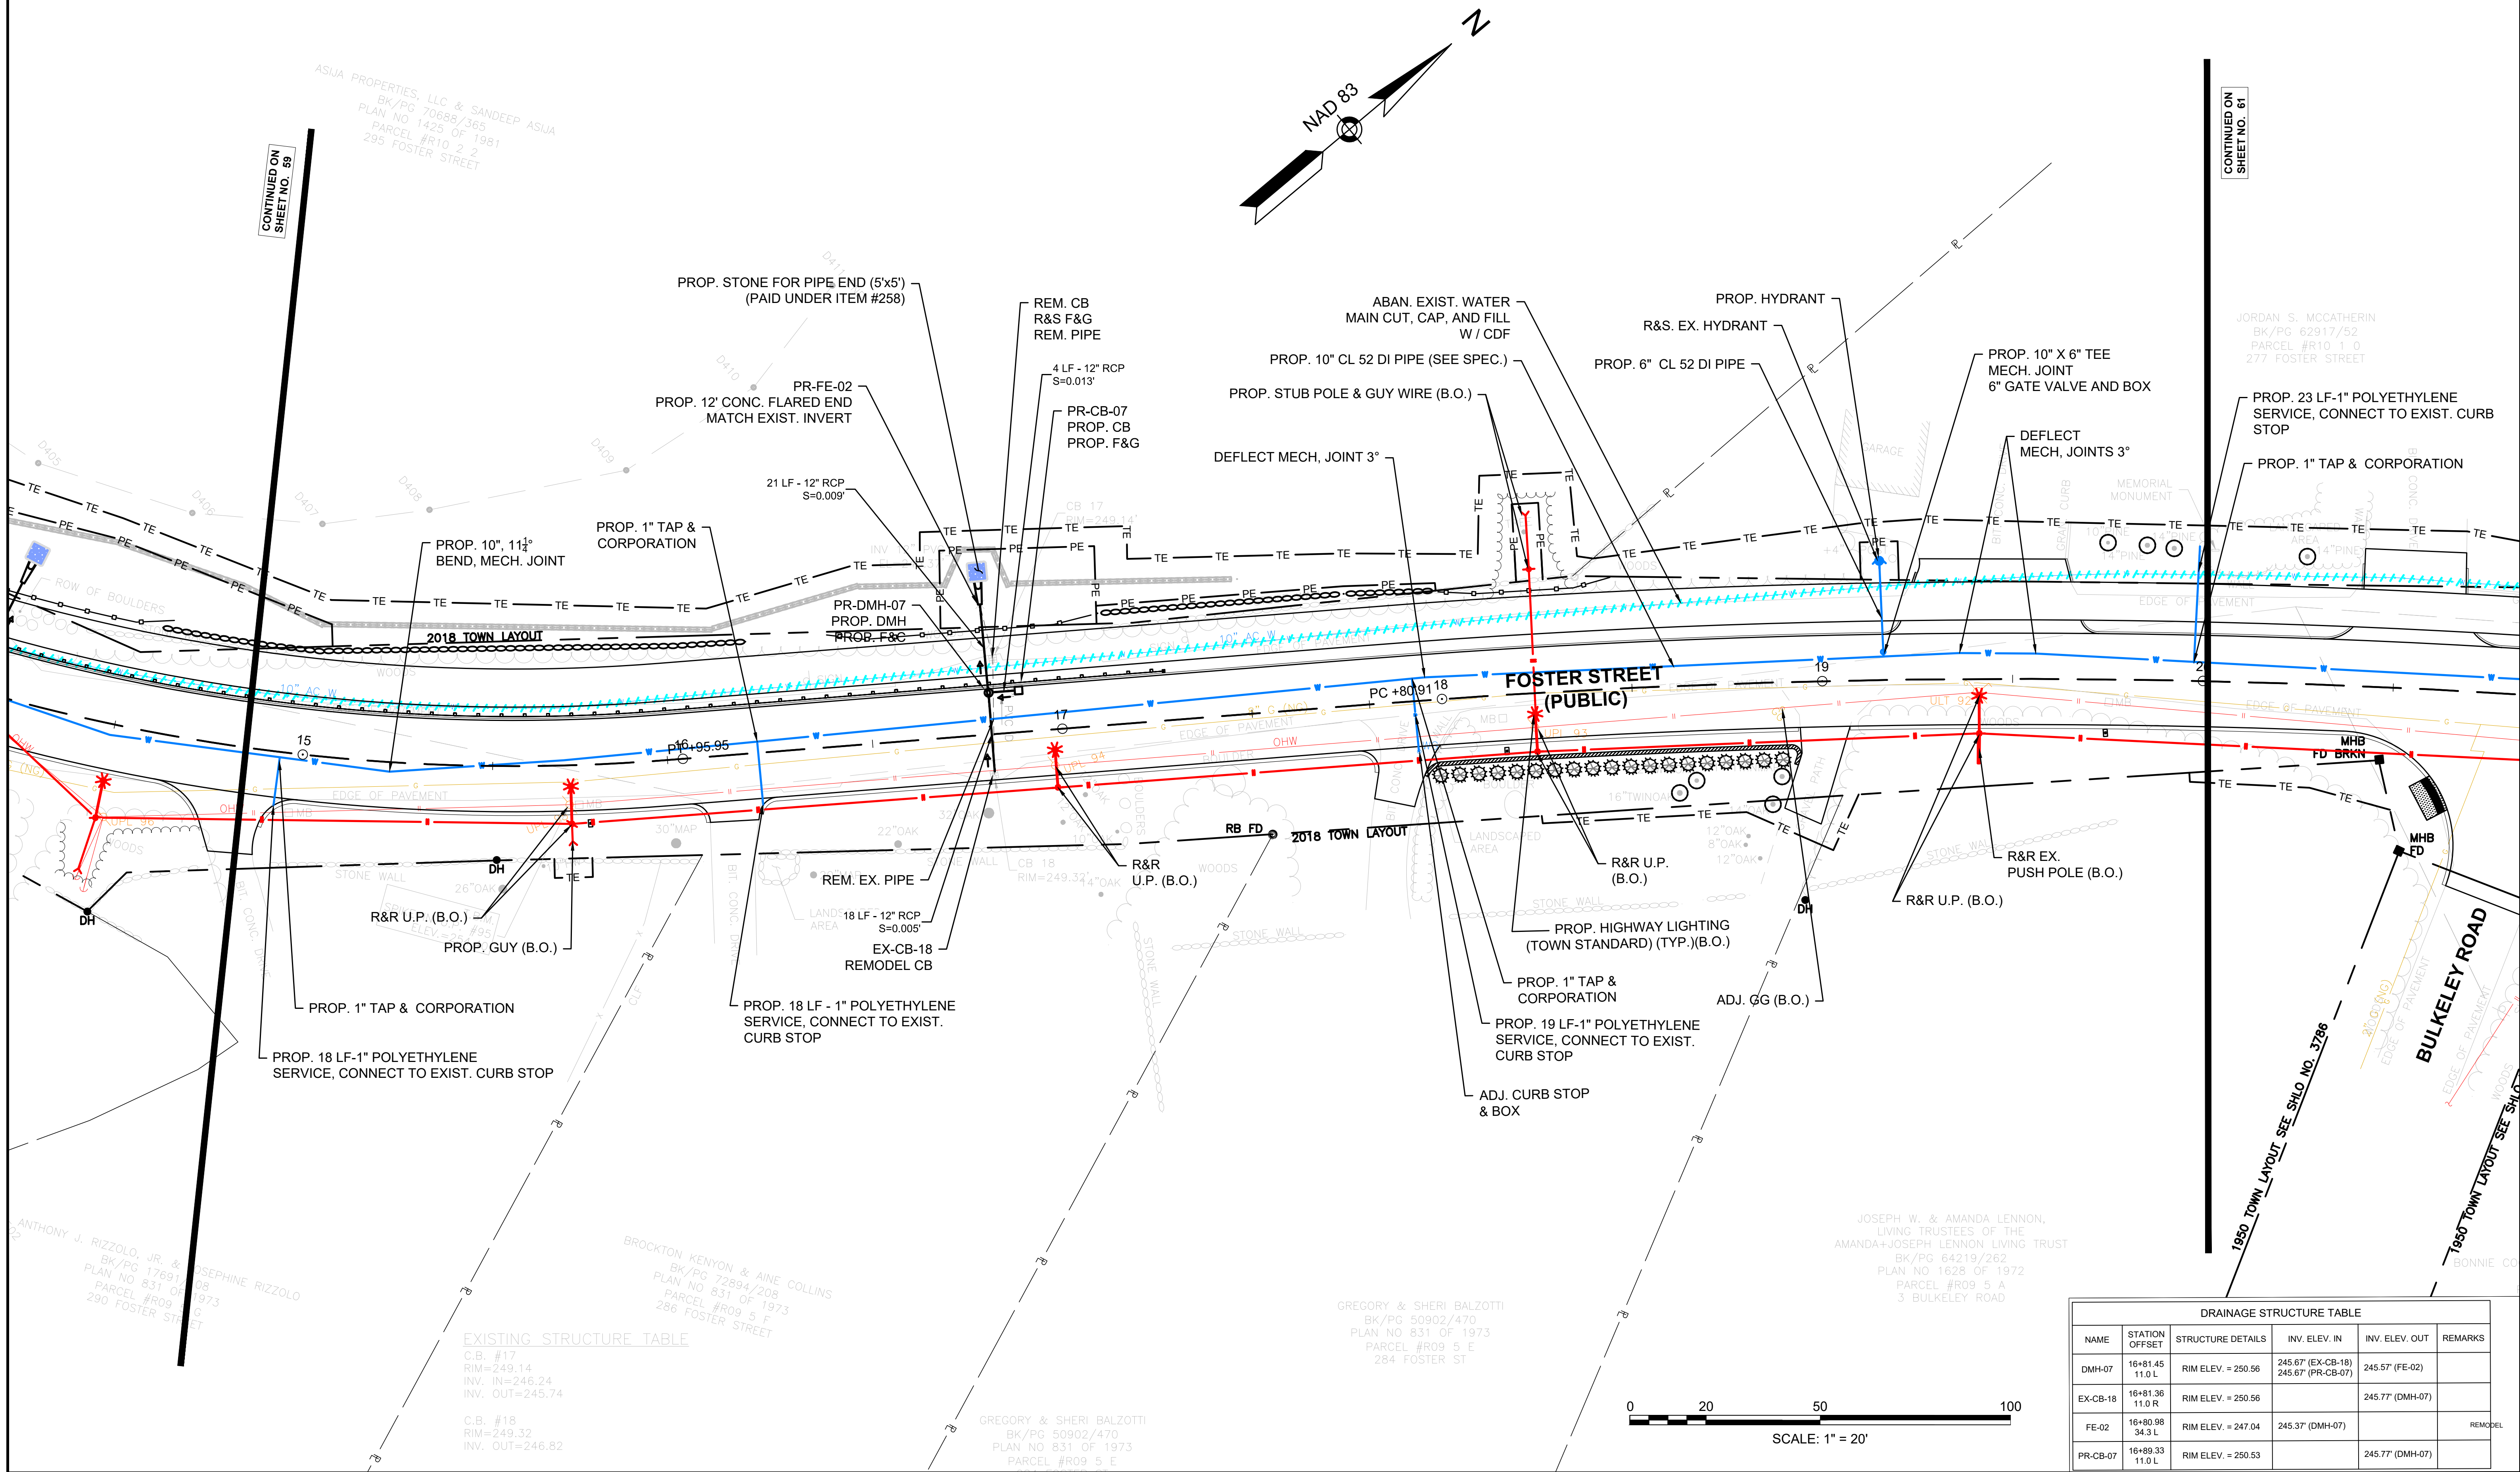

DRAINAGE STRUCTURE TABLE					
NAME	STATION OFFSET	STRUCTURE DETAILS	INV. ELEV. IN	INV. ELEV. OUT	REMARKS
DMH-07	16+81.45 11.0 L	RIM ELEV. = 250.56	245.67' (EX-CB-18) 245.67' (PR-CB-07)	245.57' (FE-02)	
EX-CB-18	16+81.36 11.0 R	RIM ELEV. = 250.56		245.77' (DMH-07)	
FE-02	16+80.98 34.3 L	RIM ELEV. = 247.04	245.37' (DMH-07)		REMODEL
PR-CB-07	16+80.33 11.0 L	RIM ELEV. = 250.53		245.77' (DMH-07)	


LITTLETON			
RECONSTRUCTION OF FOSTER STREET			
STATE	FED. AID PROJ. NO.	SHEET NO.	TOTAL SHEETS
MA	XXX-XXXX(XXX)X	61	129
PROJECT FILE NO.		609054	



LITTLETON			
RECONSTRUCTION OF FOSTER STREET			
STATE	FED. AID PROJ. NO.	SHEET NO.	TOTAL SHEETS
MA	XXX-XXXX(XXX)X	62	129
PROJECT FILE NO.		609054	



LITTLETON			
RECONSTRUCTION OF FOSTER STREET			
STATE	FED. AID PROJ. NO.	SHEET NO.	TOTAL SHEETS
MA	XXX-XXXX(XXX)X	63	129
PROJECT FILE NO.		609054	

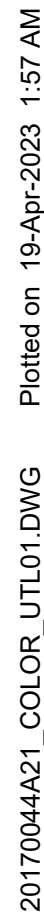


- NOTES:
- SEE SHEET 57 FOR GENERAL UTILITY, ELECTRICAL AND TREE TRIMMING NOTES
 - * - CONTRACTOR TO MATCH EXISTING PIPE INVERT. INVERT GIVEN IS APPROXIMATE

LITTLETON
RECONSTRUCTION OF FOSTER STREET

STATE	FED. AID PROJ. NO.	SHEET NO.	TOTAL SHEETS
MA	XXX-XXX(XXX)X	64	129
PROJECT FILE NO.		609054	


DRAINAGE & UTILITY PLANS REVISED 5/26/2022

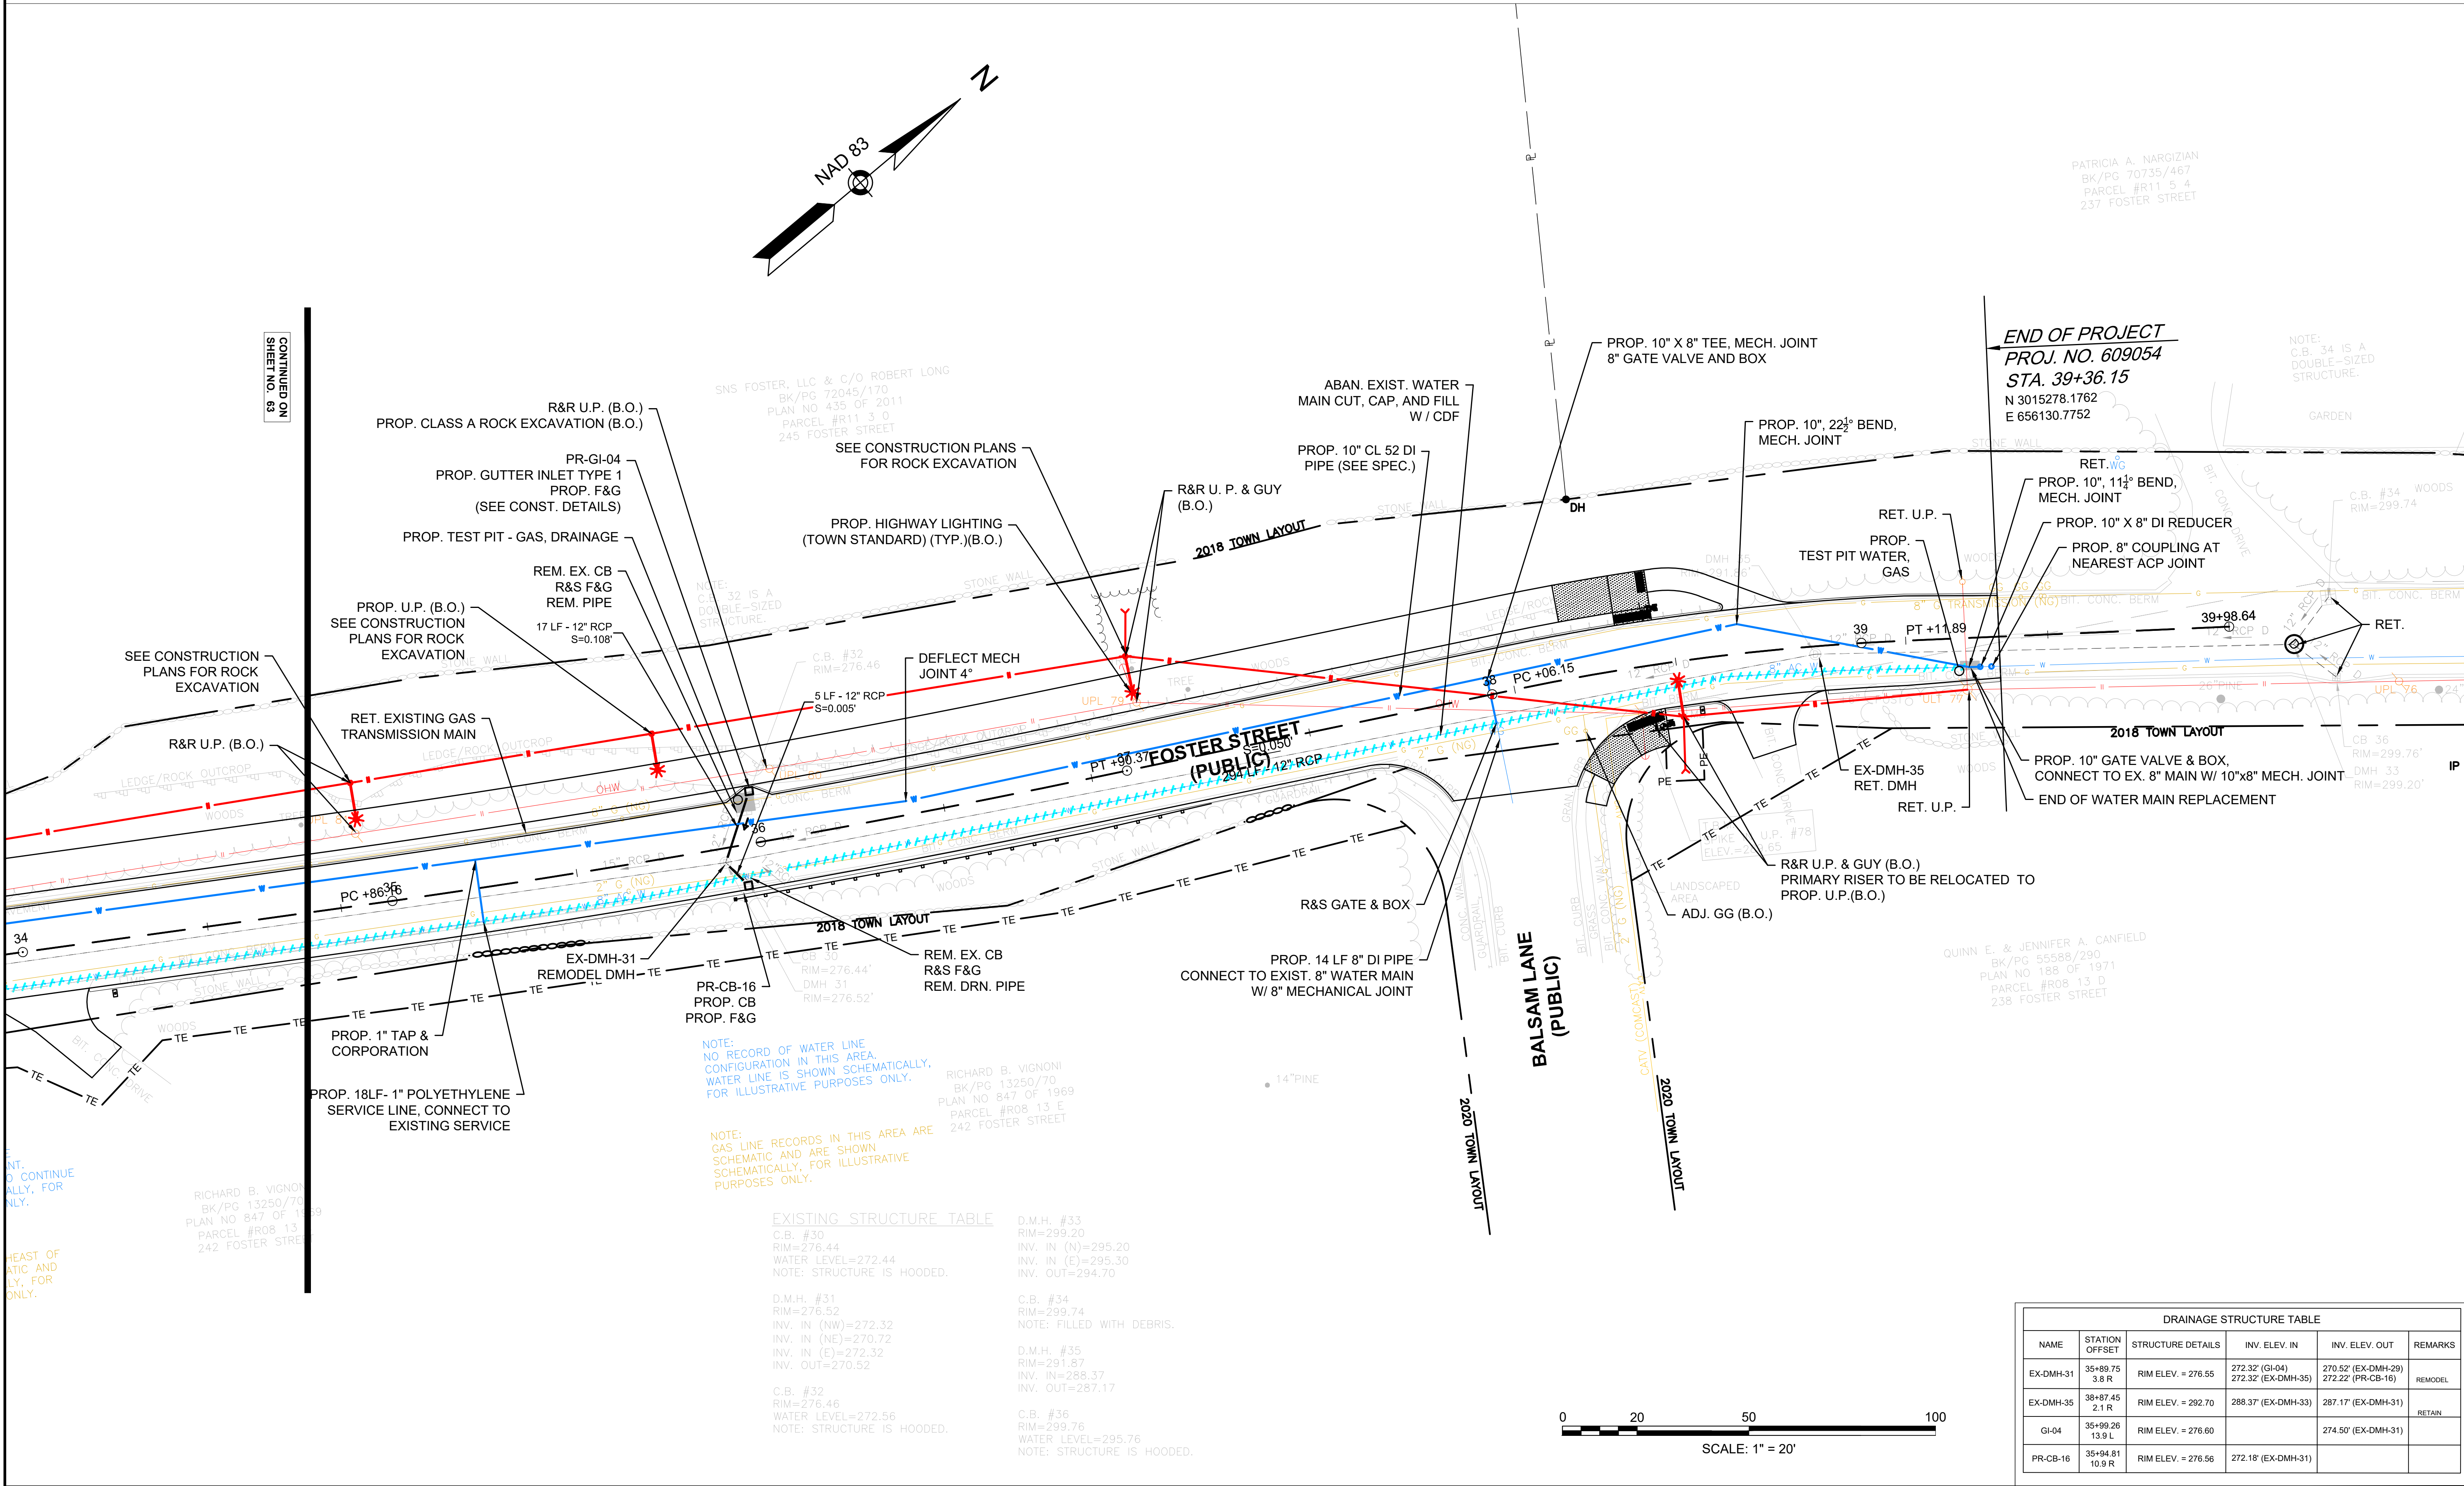

LITTLETON
RECONSTRUCTION OF FOSTER STREET

STATE	FED. AID PROJ. NO.	SHEET NO.	TOTAL SHEETS
MA	XXX-XXXX(XXX)X	65	129
PROJECT FILE NO. 609054			

DRAINAGE & UTILITY DETAILS

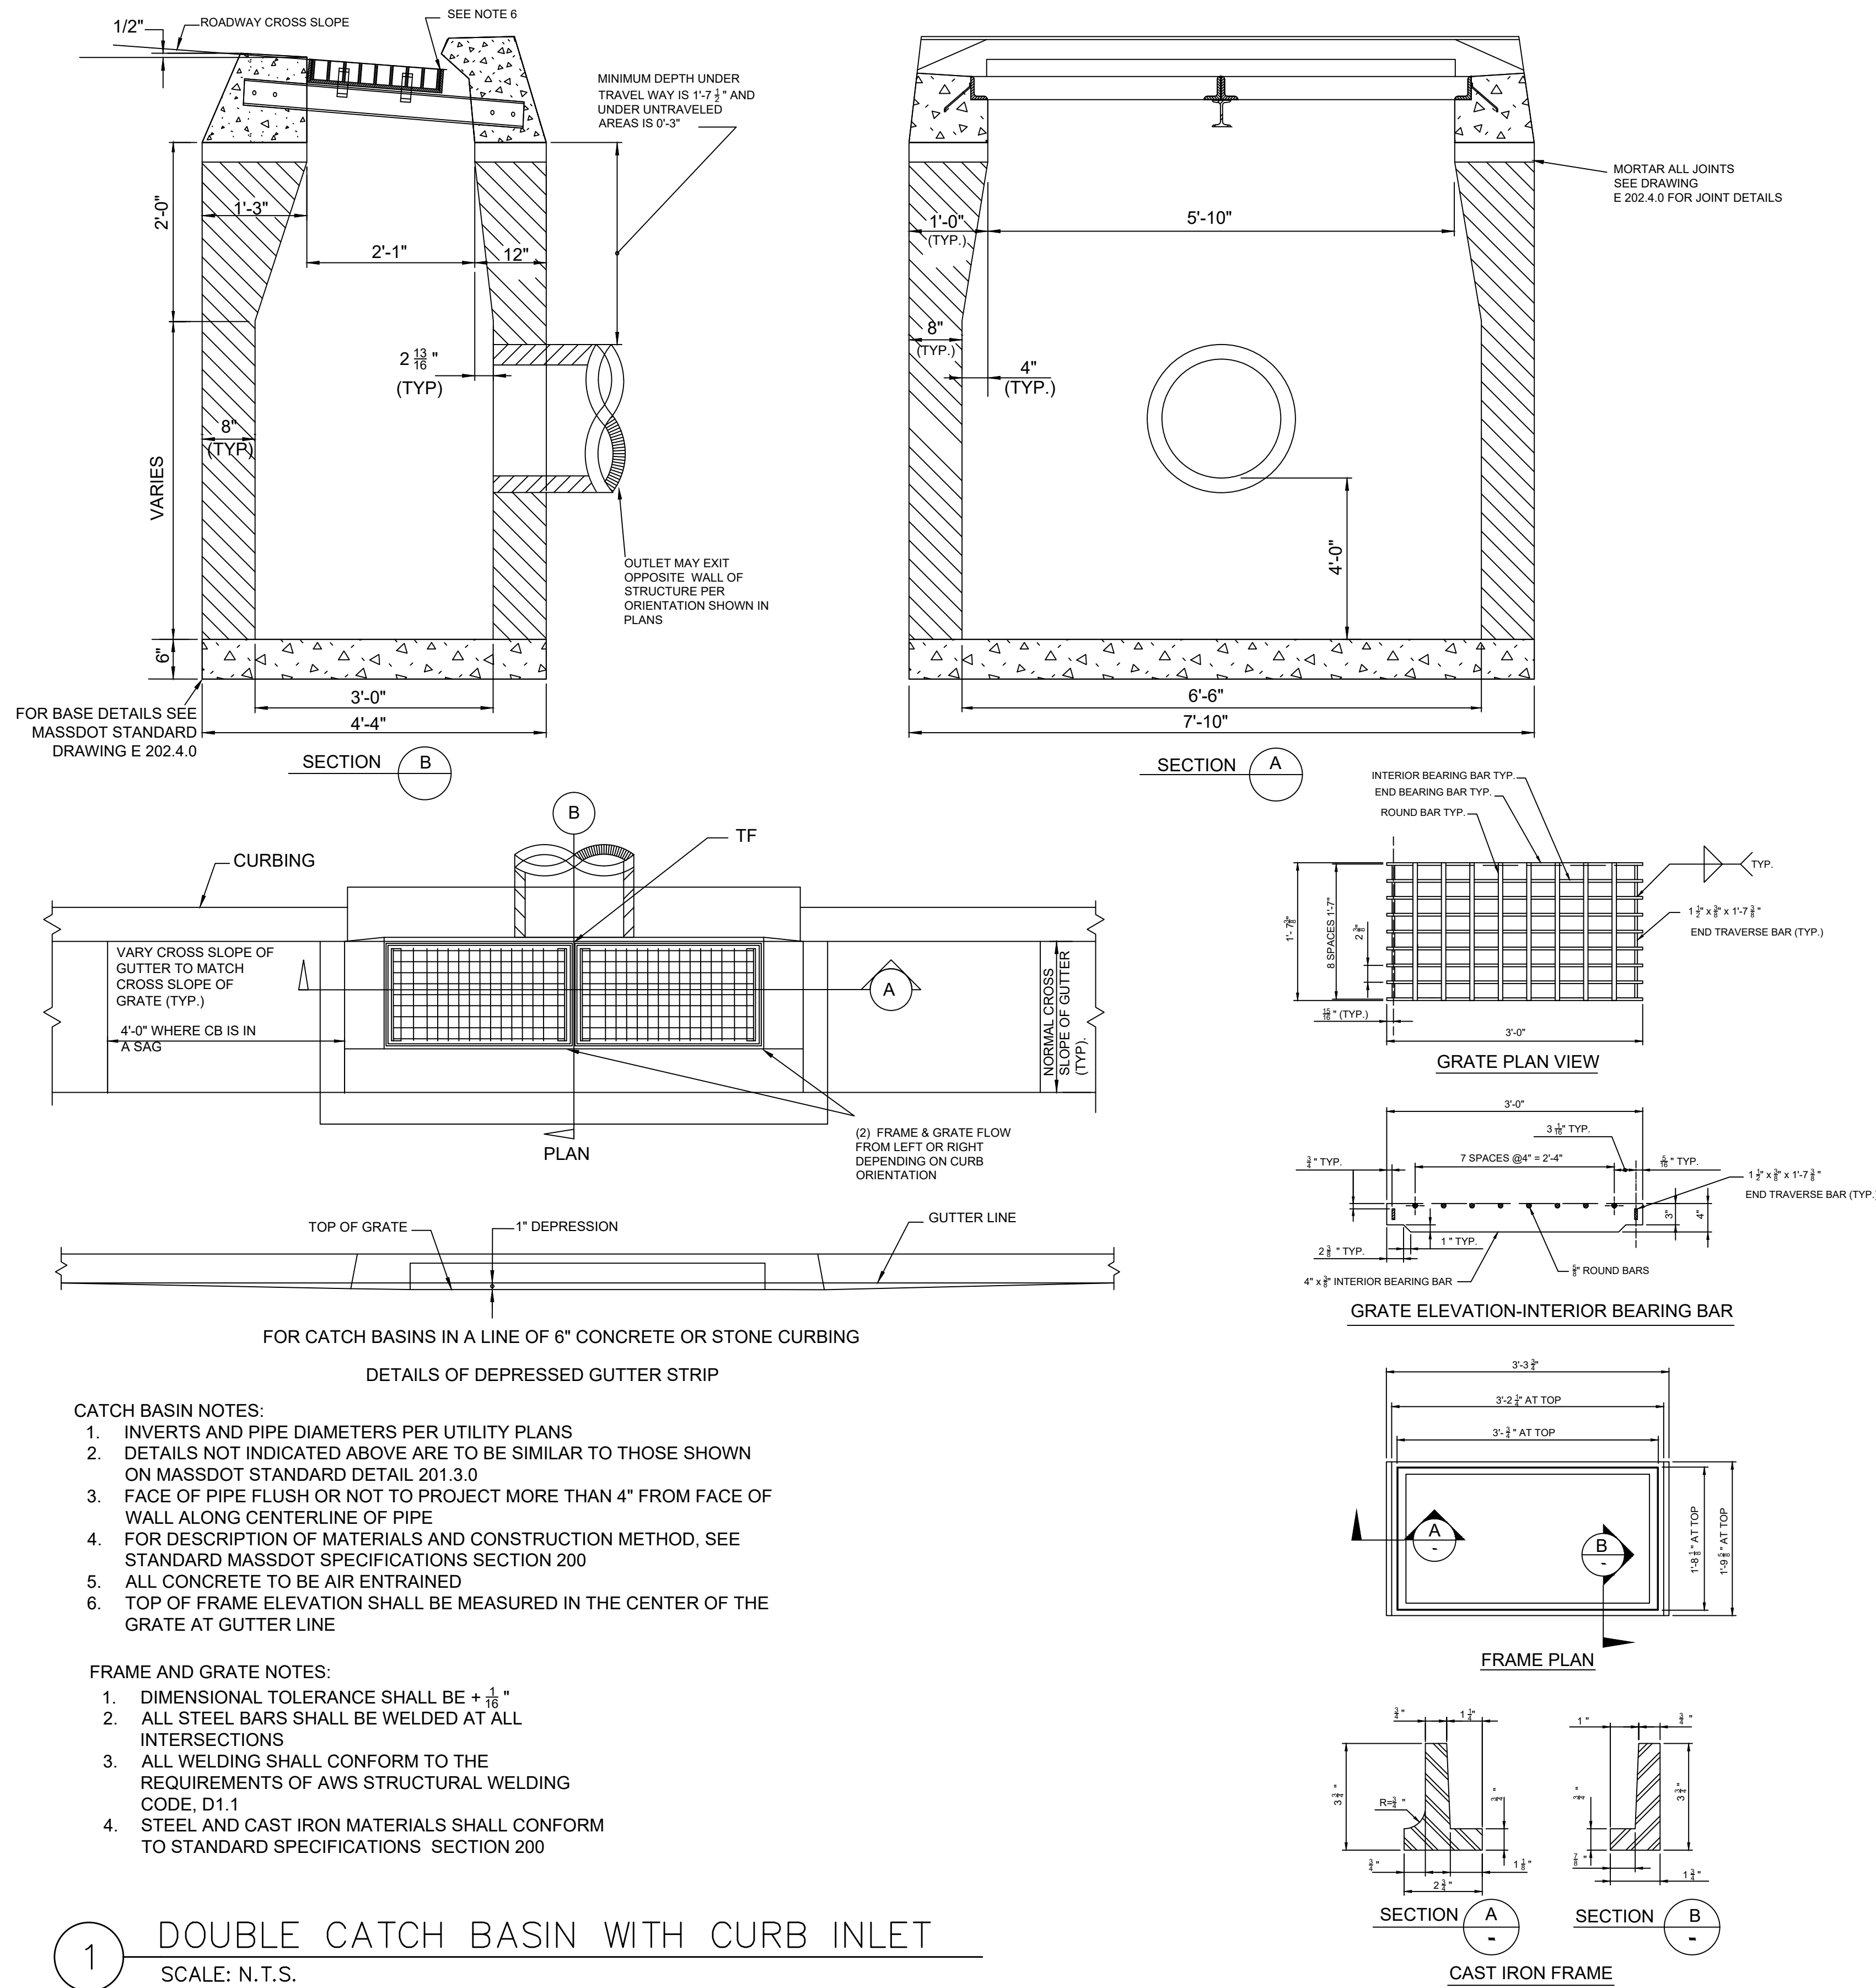


1 DOUBLE CATCH BASIN WITH CURB INLET
SCALE: N.T.S.

LITTLETON
RECONSTRUCTION OF FOSTER STREET


STATE	FED. AID PROJ. NO.	SHEET NO.	TOTAL SHEETS
MA	XXX-XXX(XXX)X	66	129
PROJECT FILE NO. 609054			

DRAINAGE & UTILITY DETAILS

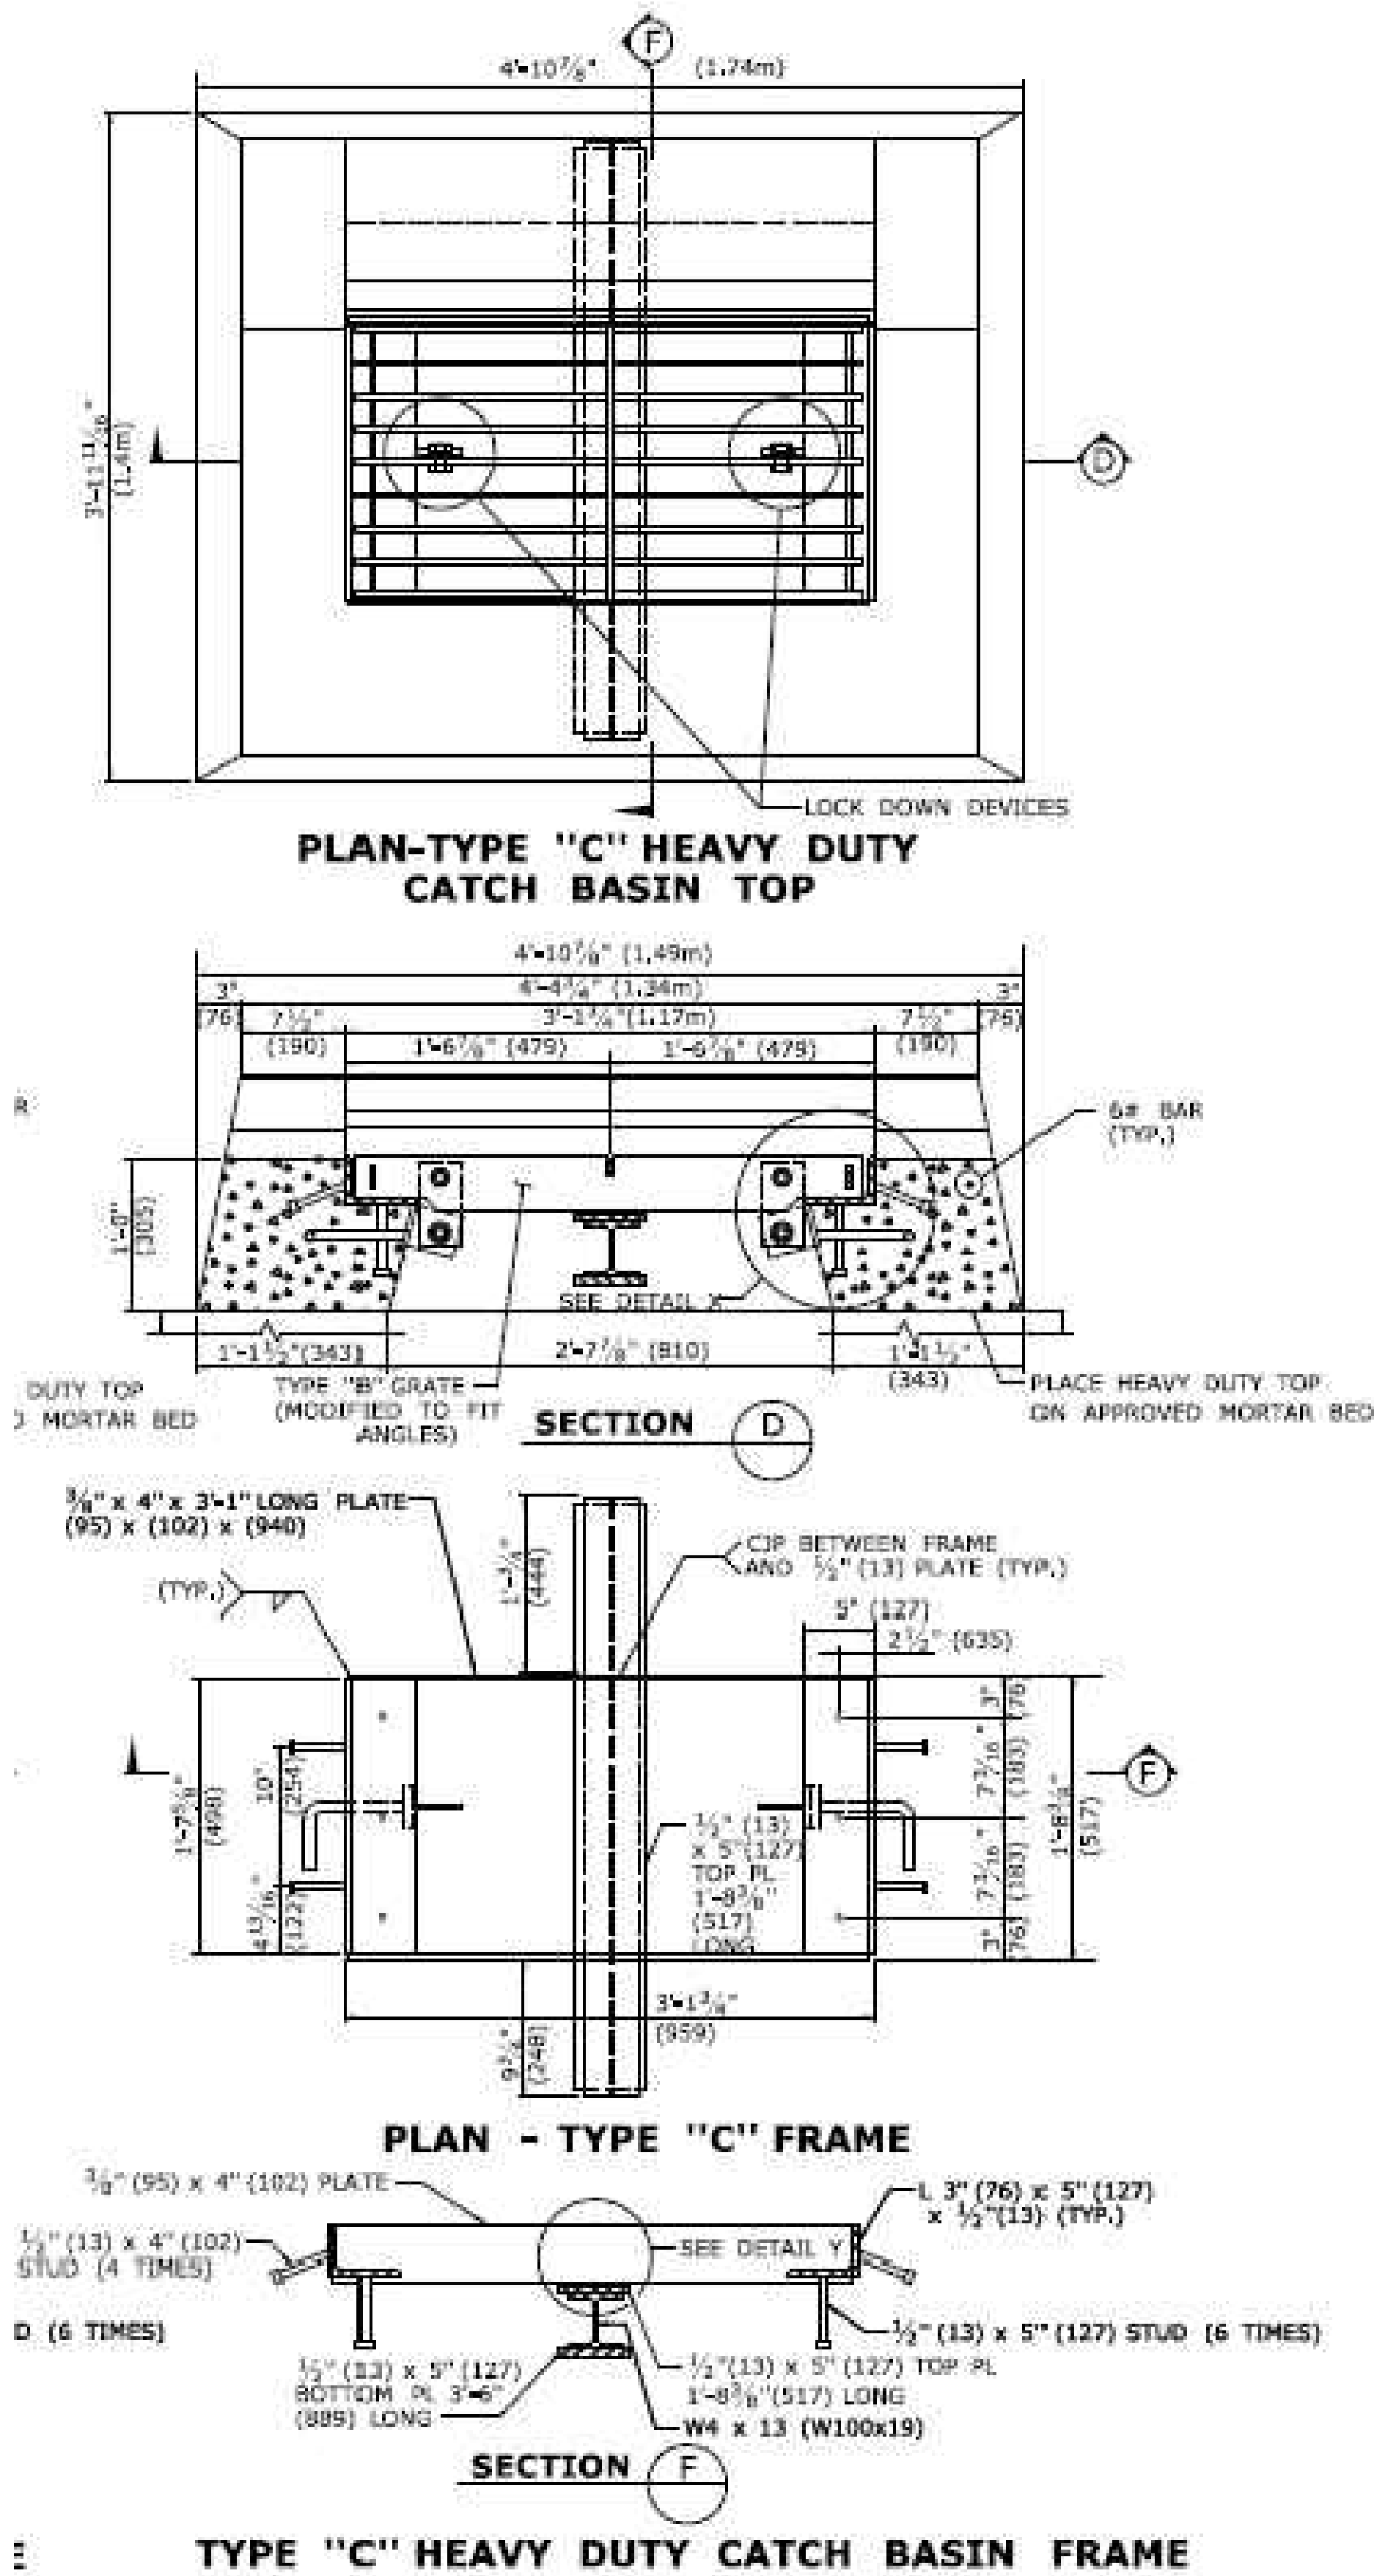


TYPE "C" HEAVY DUTY CATCH BASIN FRAME


2 DOUBLE CATCH BASIN FRAME
SCALE: N.T.S.

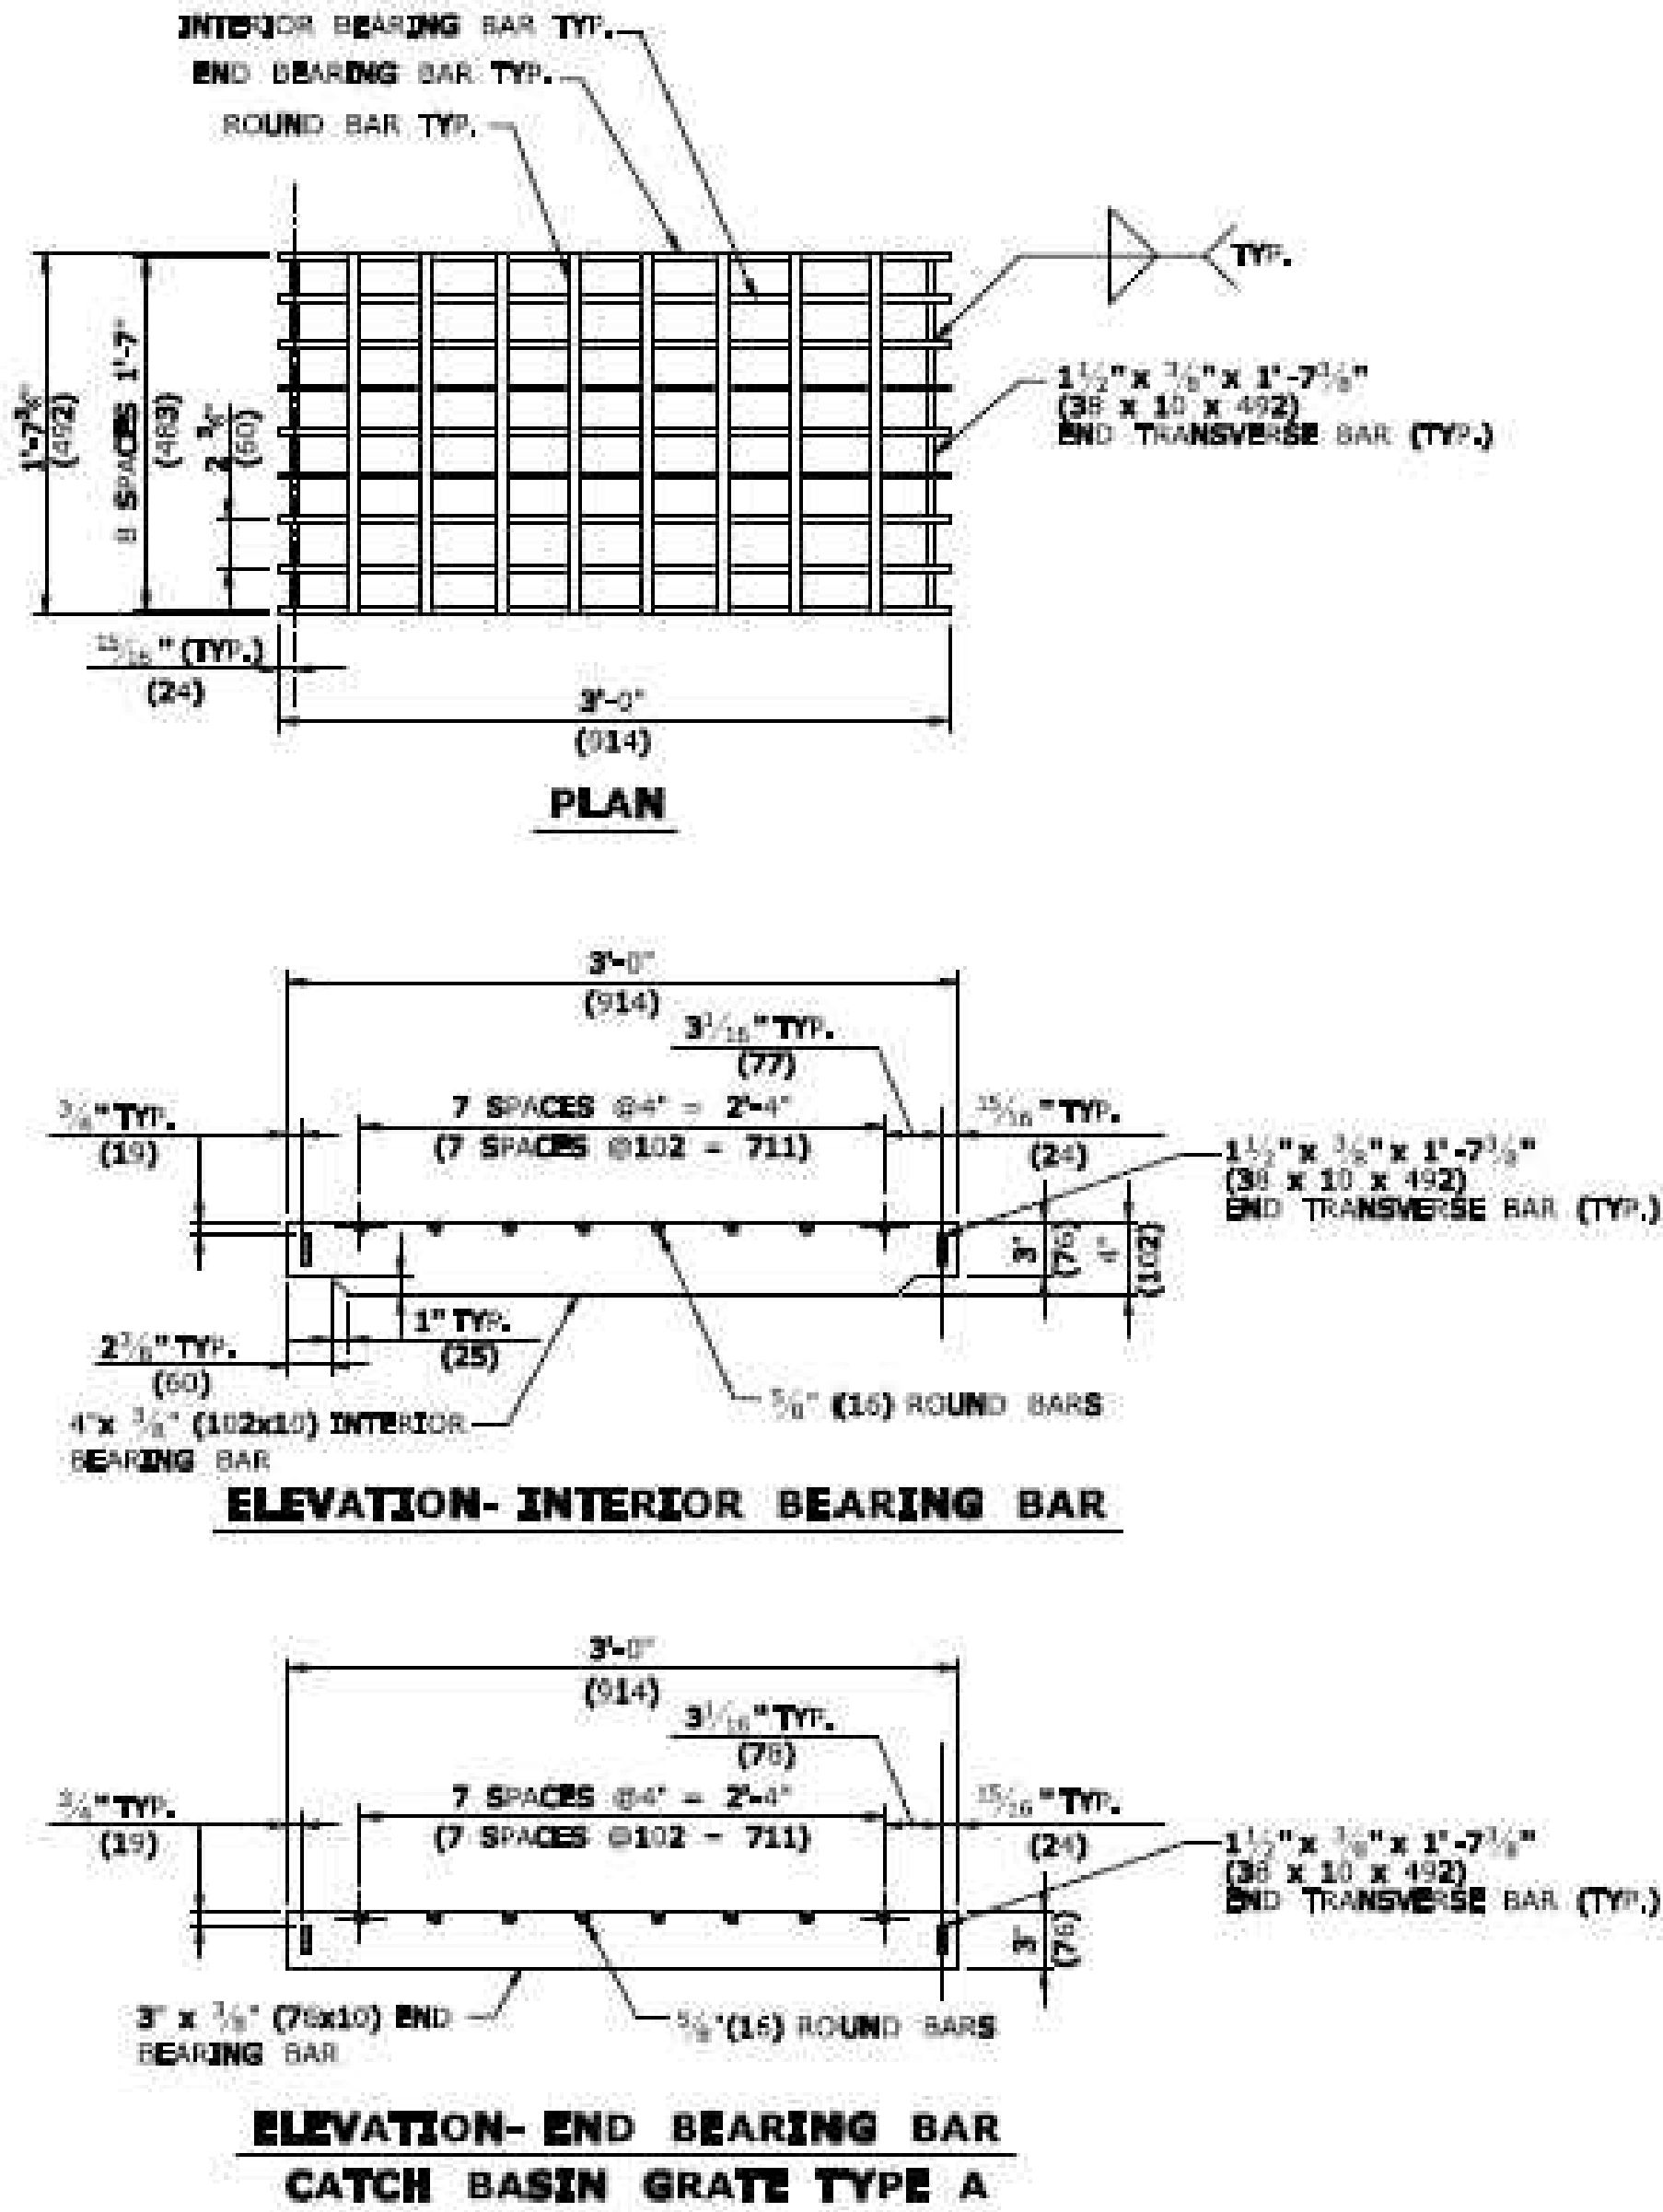


3 DOUBLE CATCH BASIN GRATE
SCALE: N.T.S.

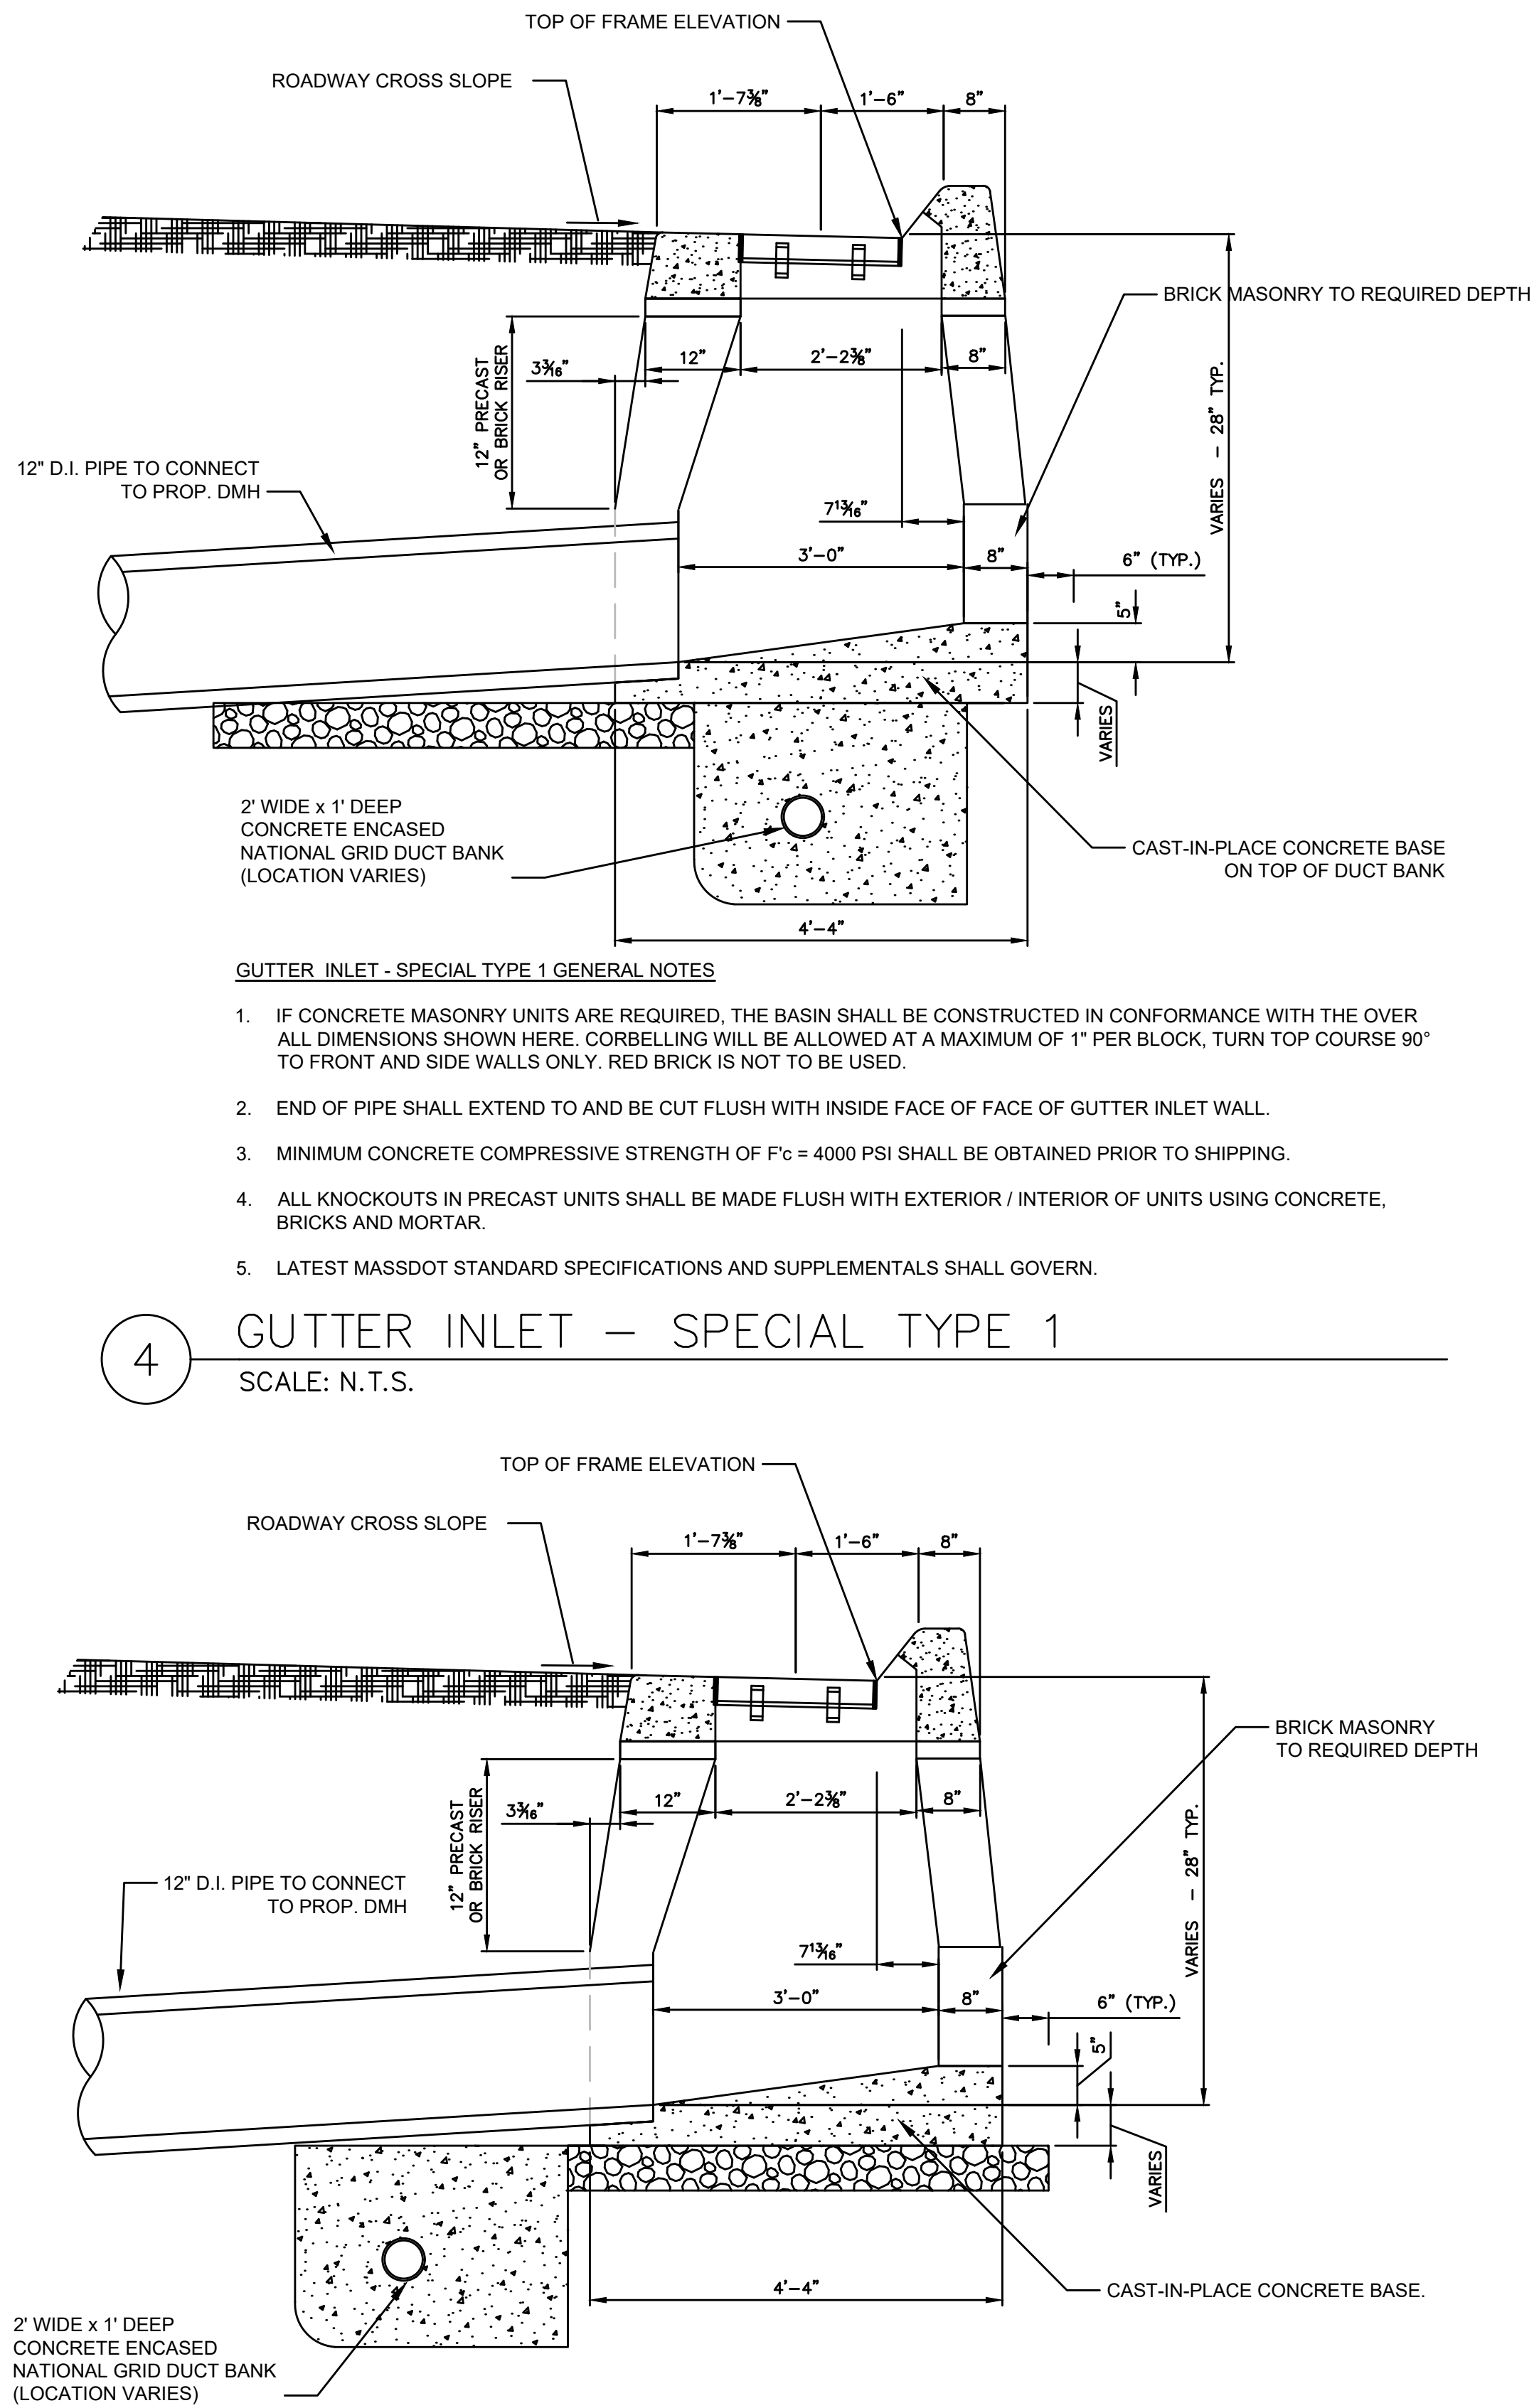


5 GUTTER INLET - SPECIAL TYPE 2
SCALE: N.T.S.

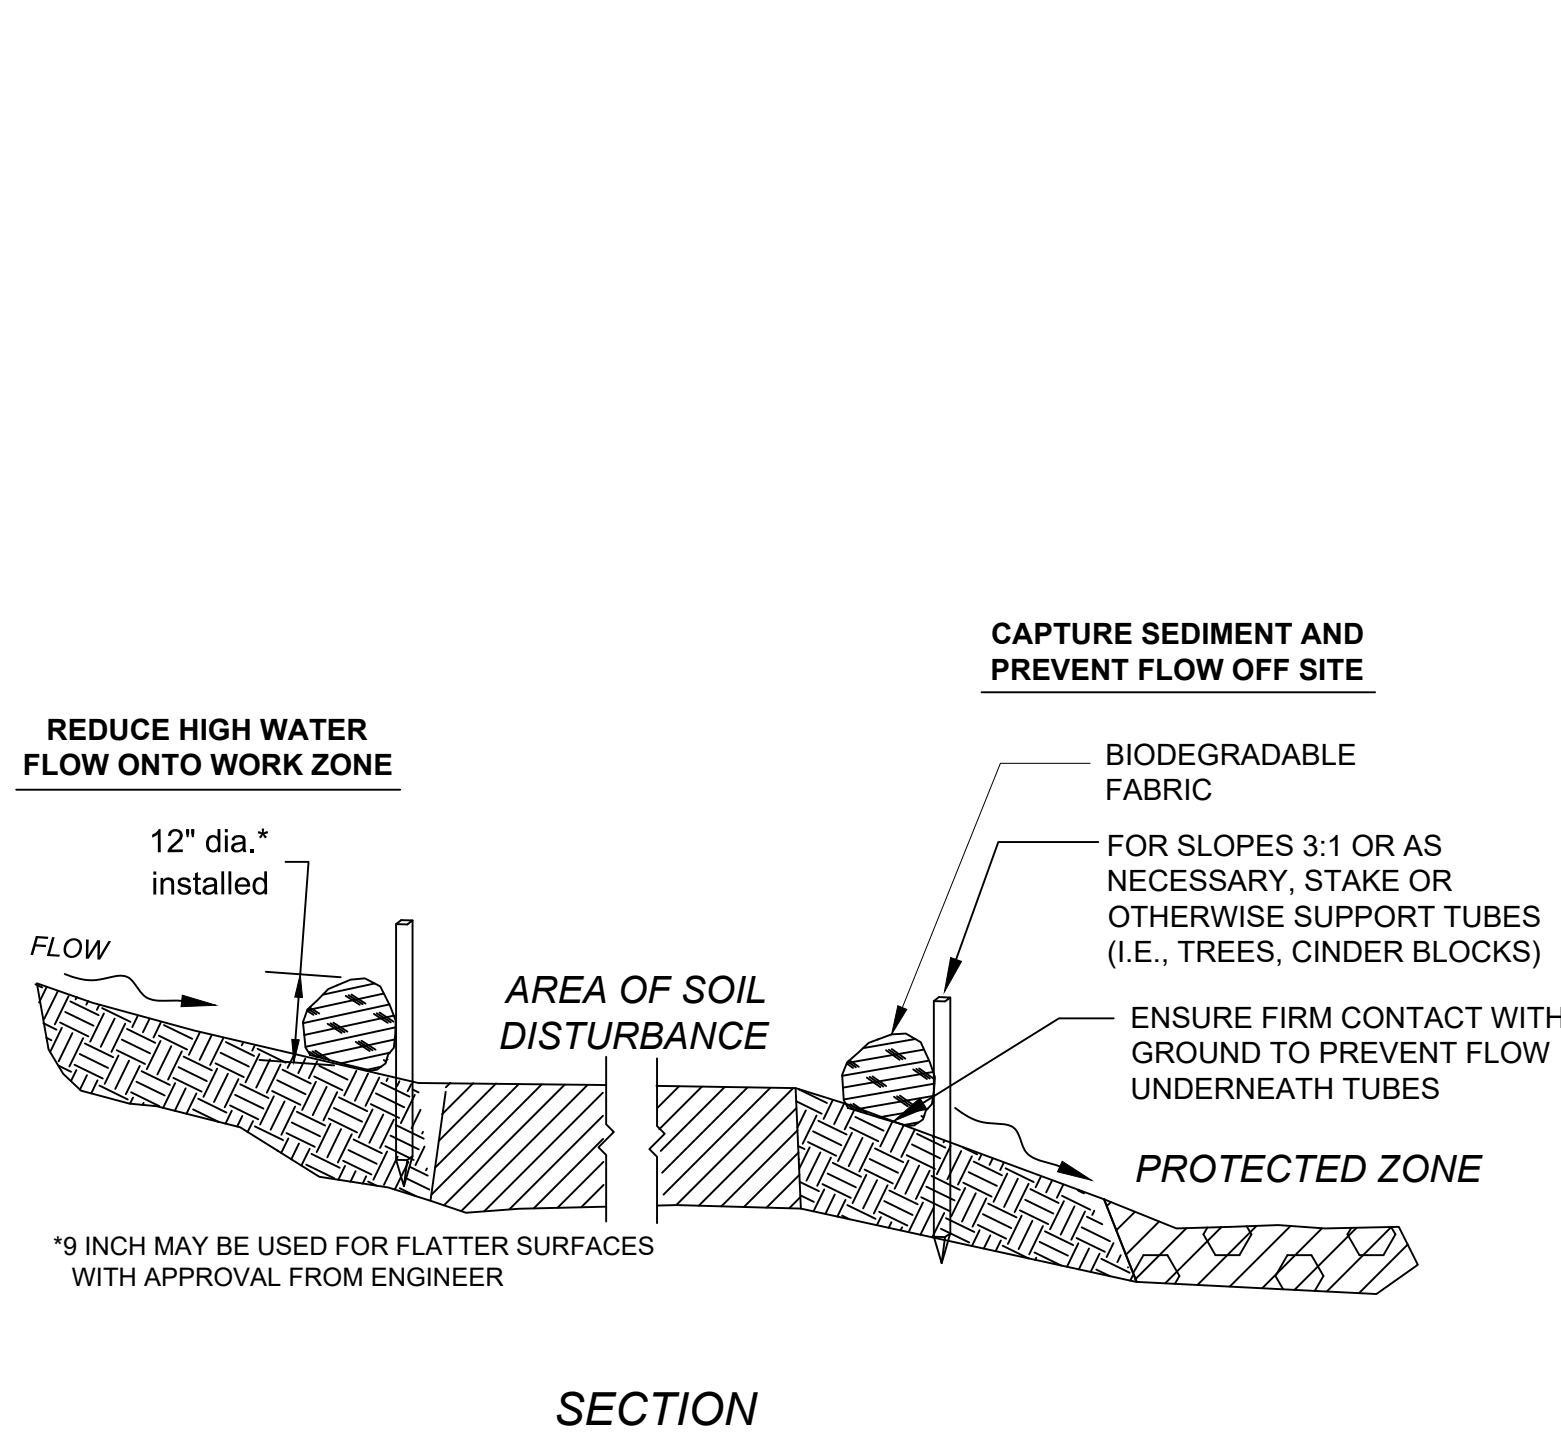


SEDIMENT BARRIER - COMPOST FILTER TUBES
NOT TO SCALE

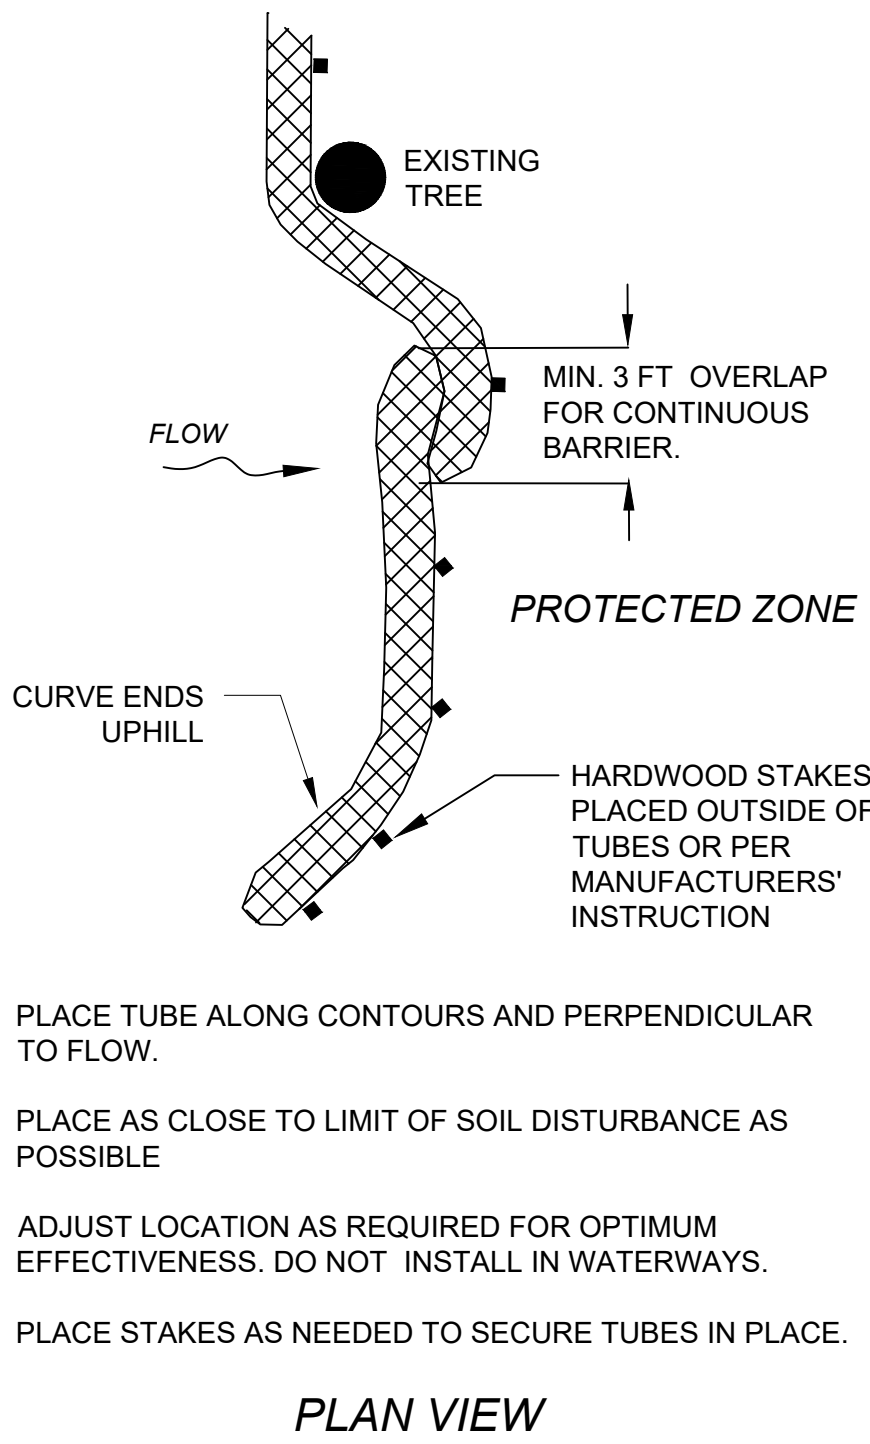


COMPOST FILTER TUBE
NOT TO SCALE

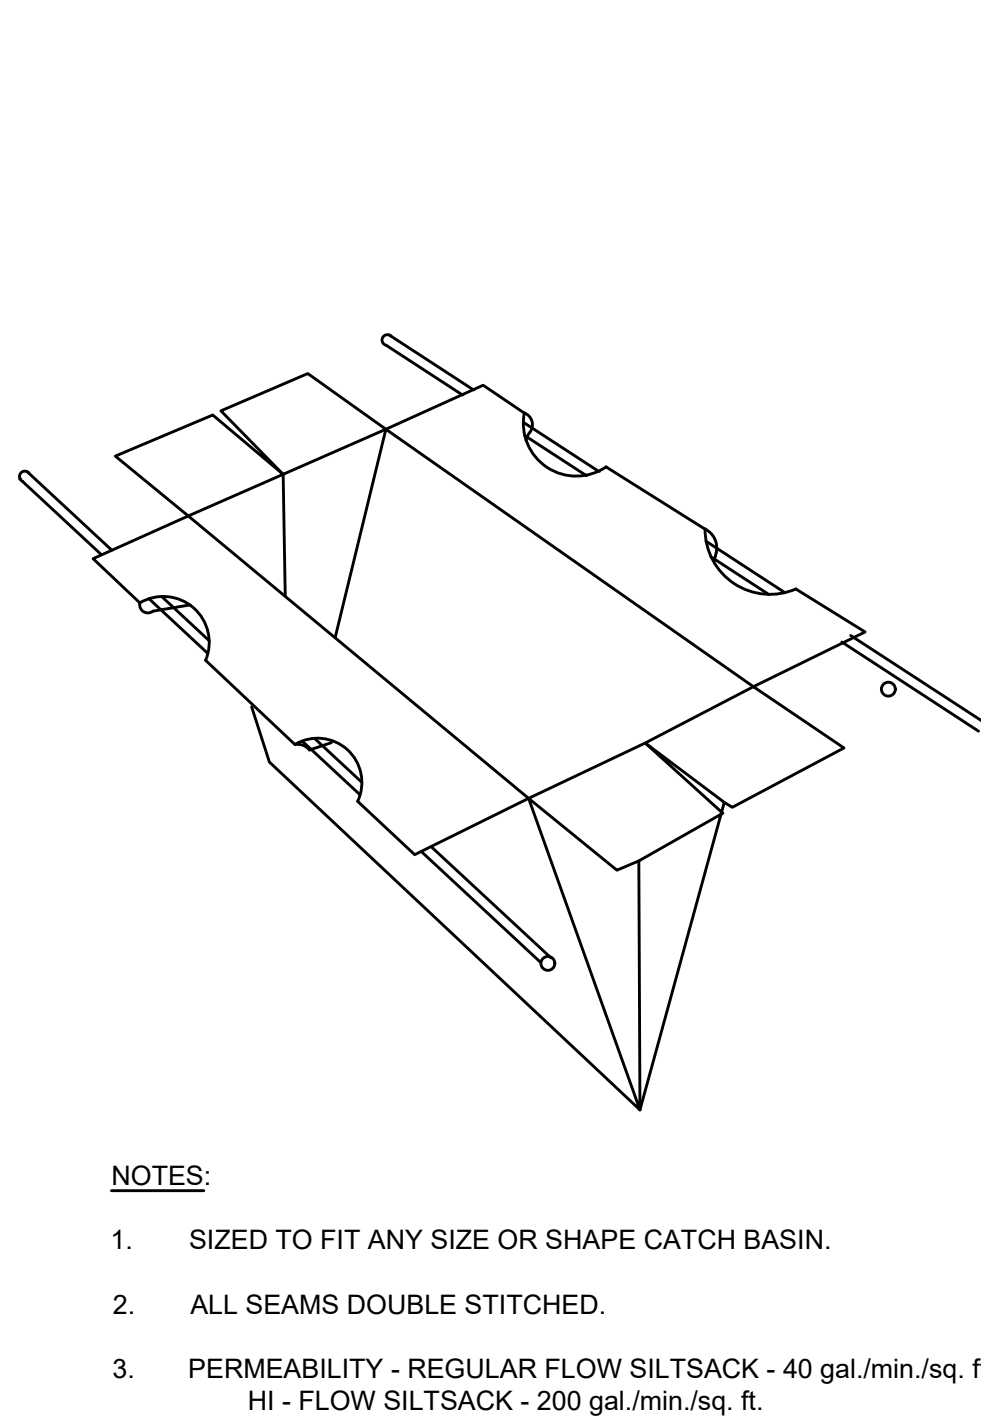


7 CATCH BASIN SILT SACK
SCALE: N.T.S.

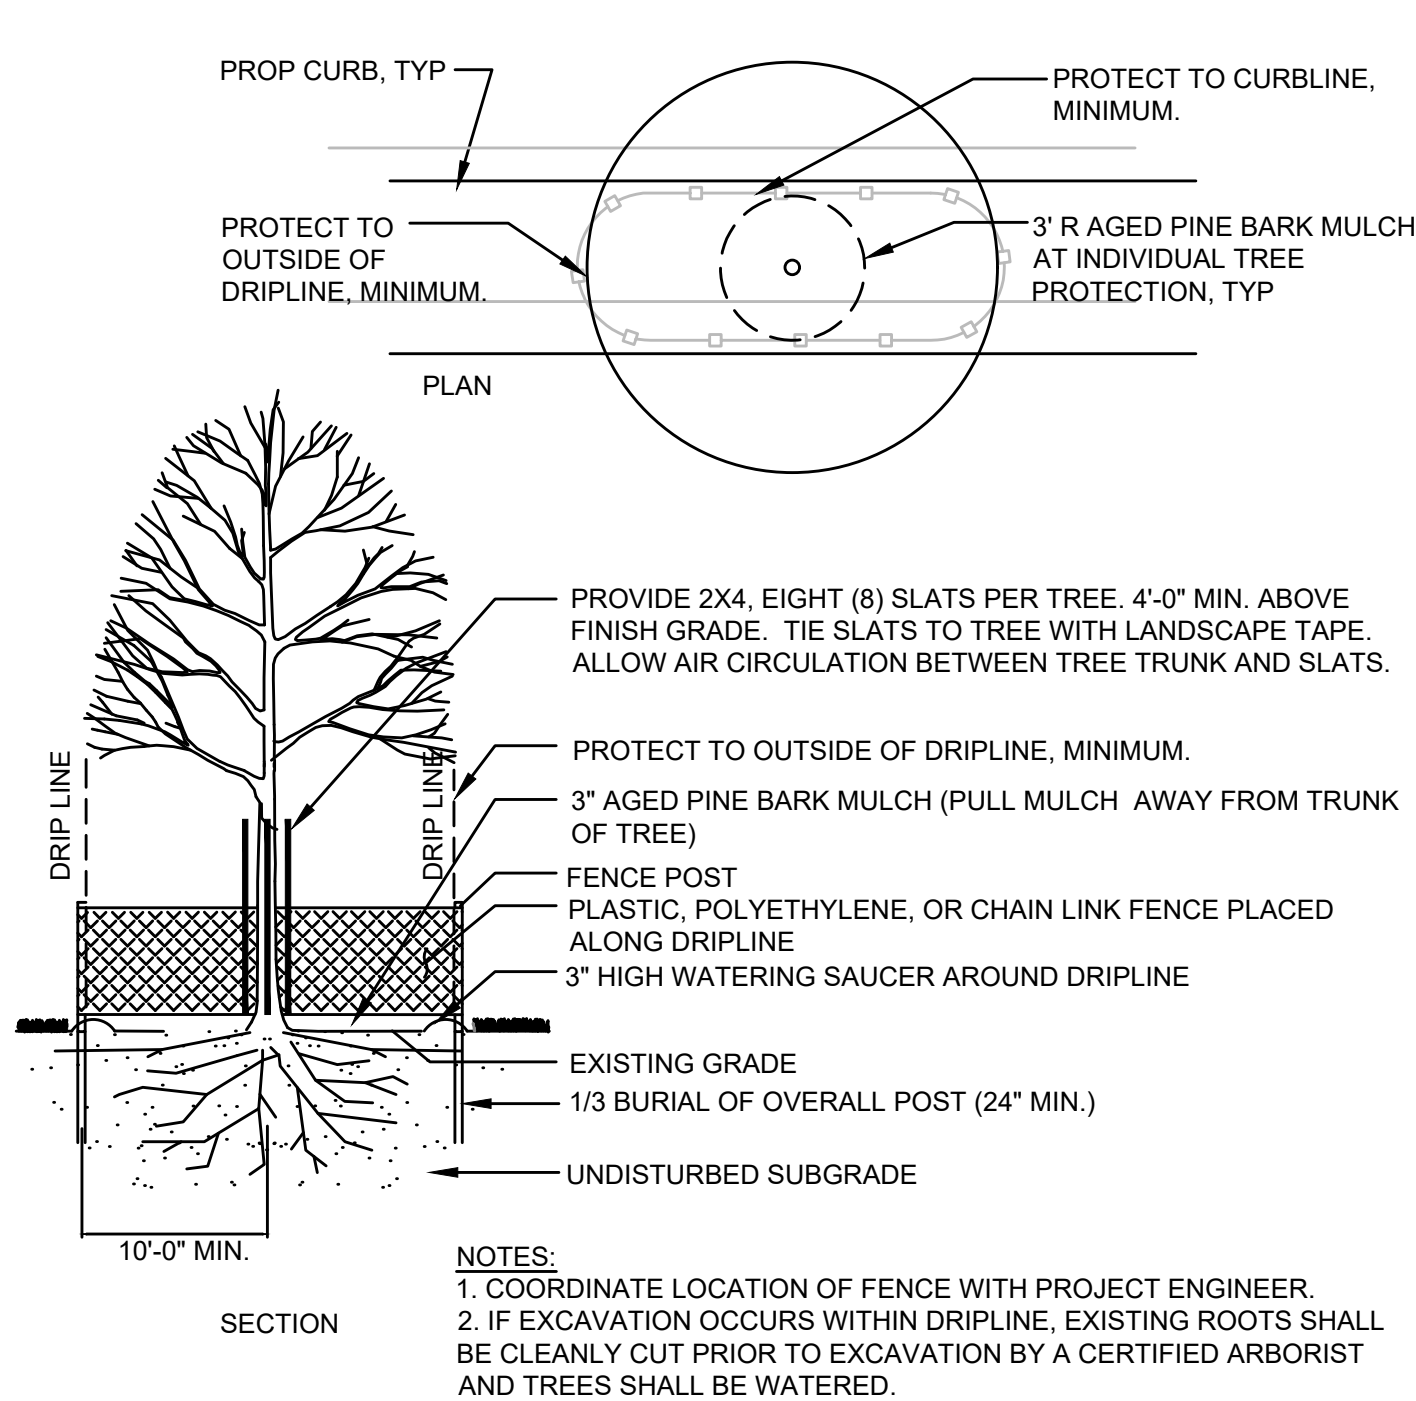


8 INDIVIDUAL TREE PROTECTION
SCALE: N.T.S.

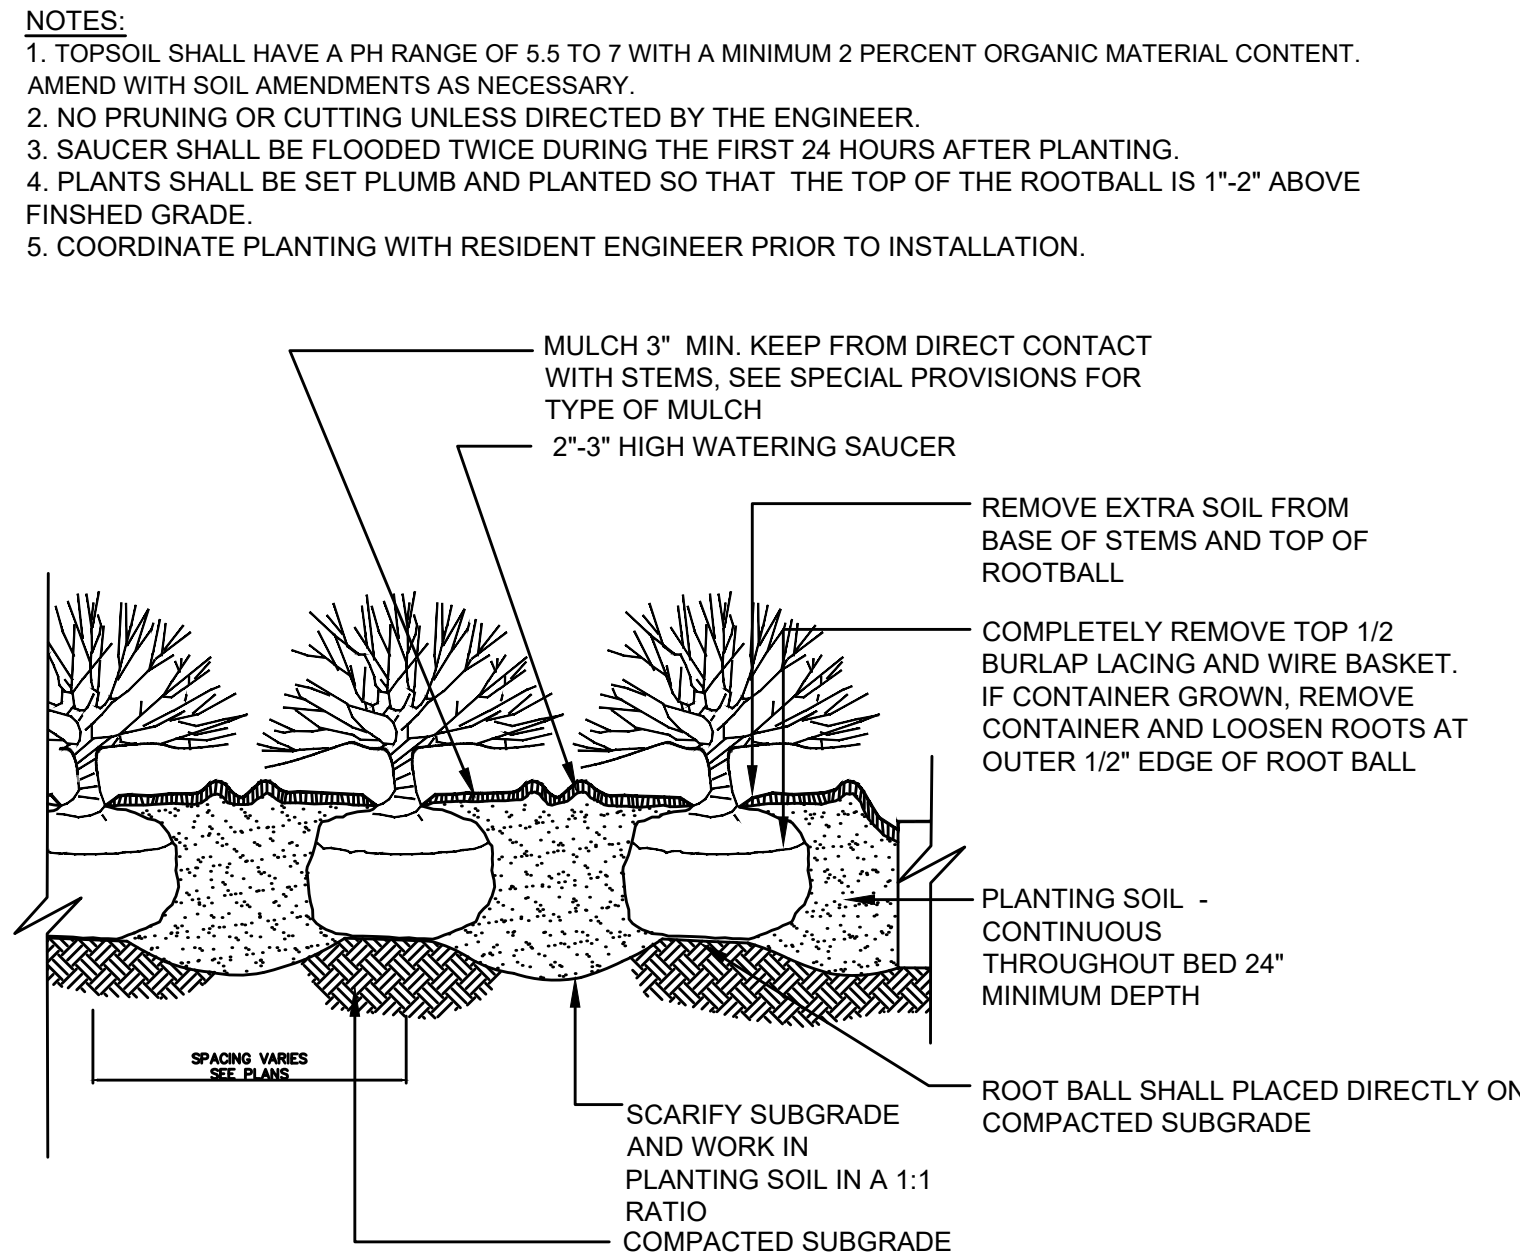


9 SHRUB AND PERENNIAL PLANTING
SCALE: N.T.S.

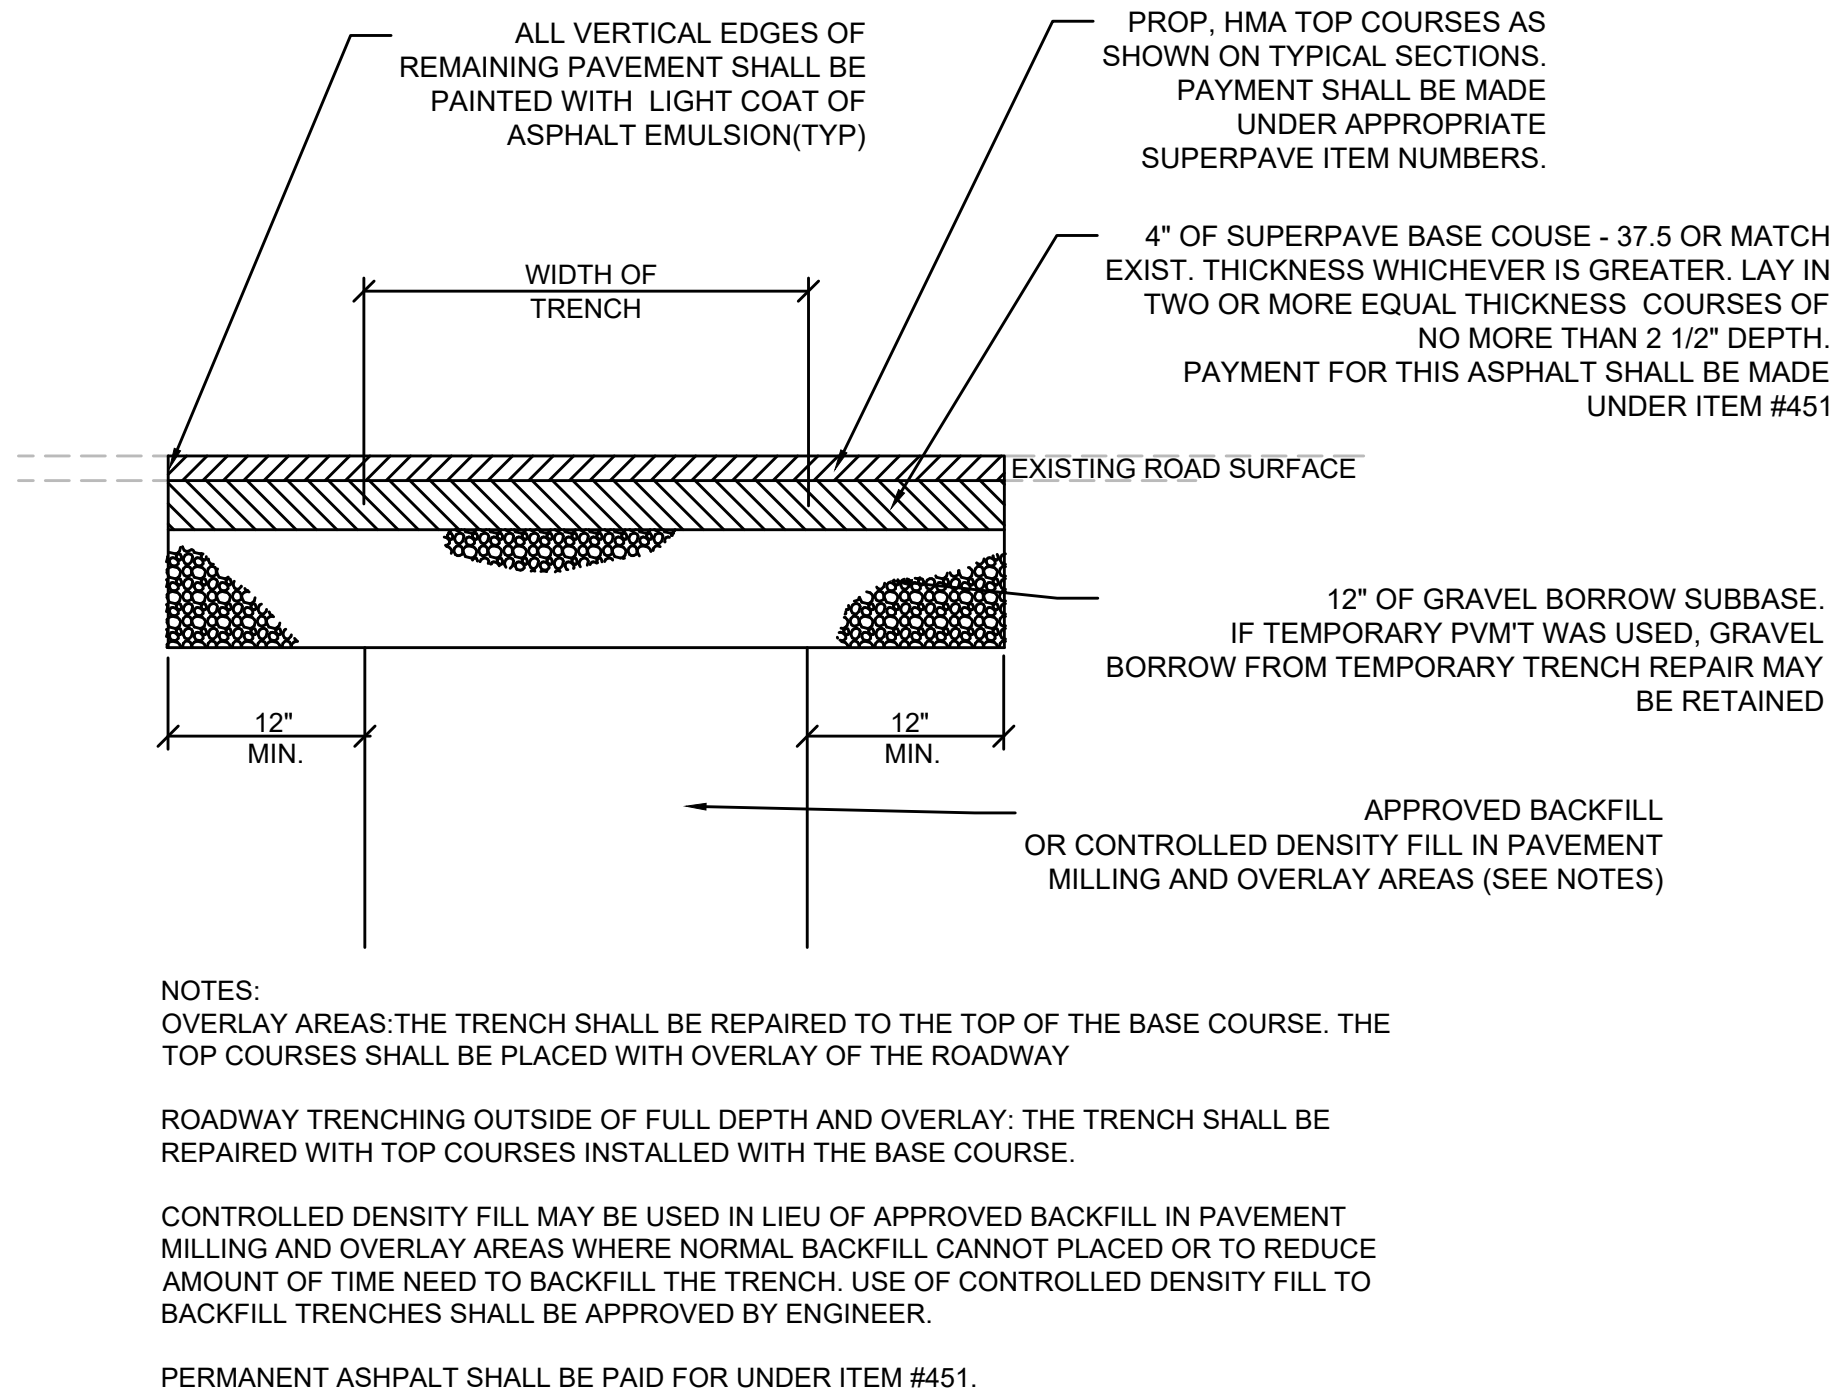

10 PERMANENT PAVEMENT TRENCH REPAIR IN ROADWAYS
SCALE: N.T.S.

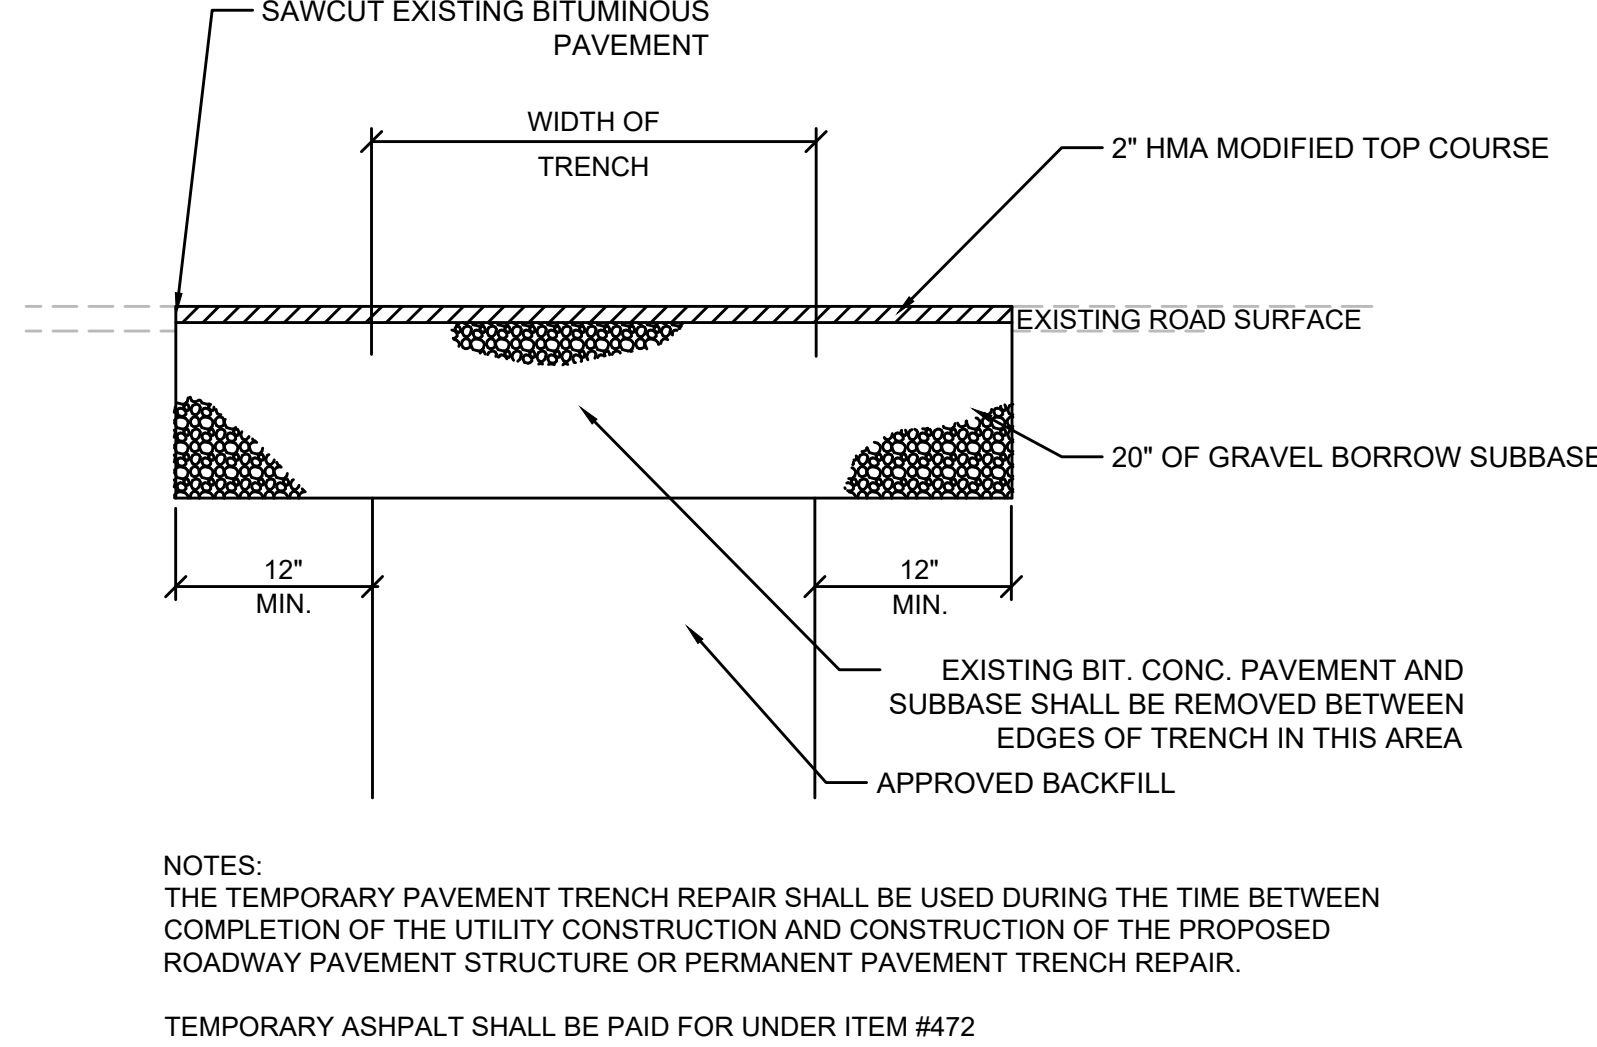


11 TEMPORARY PAVEMENT TRENCH REPAIR
SCALE: N.T.S.

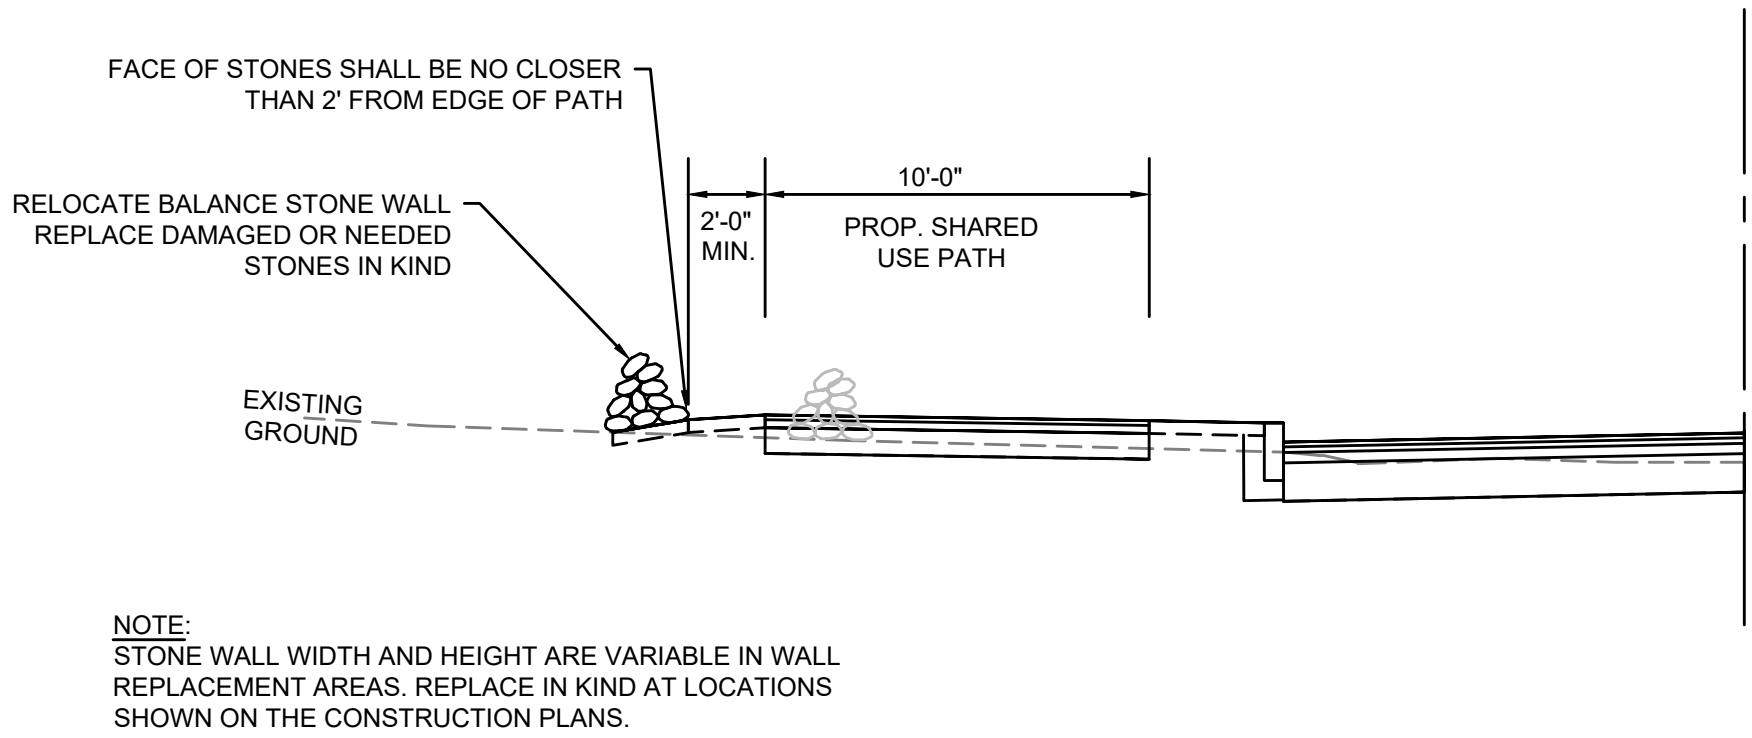

12

BALANCE STONE WALL
REMOVED AND REBUILT, DRY
SCALE: N.T.S.

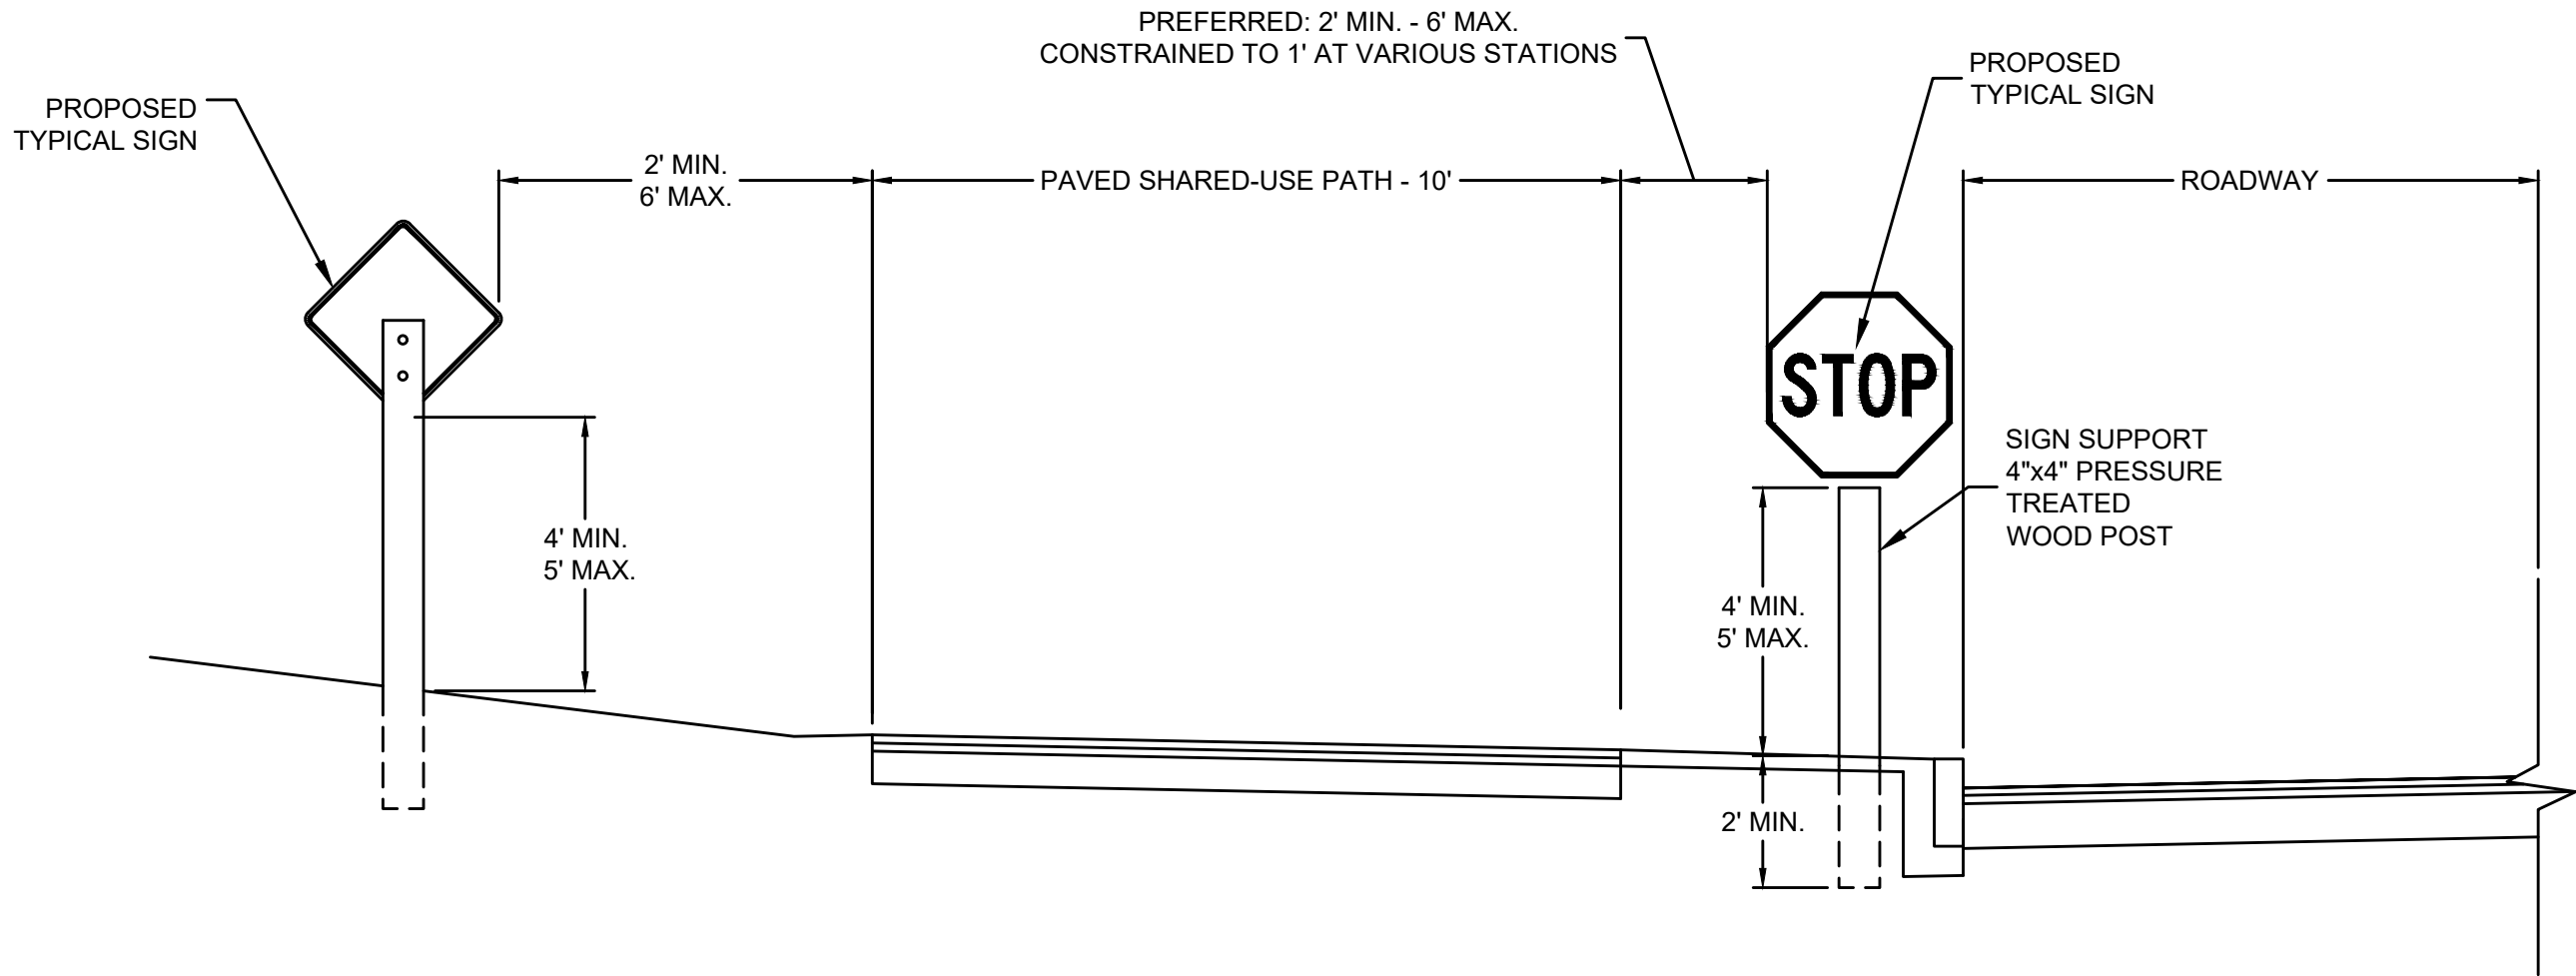


13

SHARED-USE PATH TYPICAL SIGN PLACEMENT
SCALE: N.T.S.


- NOTES:
1. ALL HARDWARE SHALL BE GALVANIZED.
 2. WOOD POSTS SHALL BE PAID FOR UNDER ITEM 847.11*.

STATE	FED. AID PROJ. NO.	SHEET NO.	TOTAL SHEETS
MA	XXX-XXX(XXX)X	69	129
PROJECT FILE NO. 609054			

CONSTRUCTION DETAILS

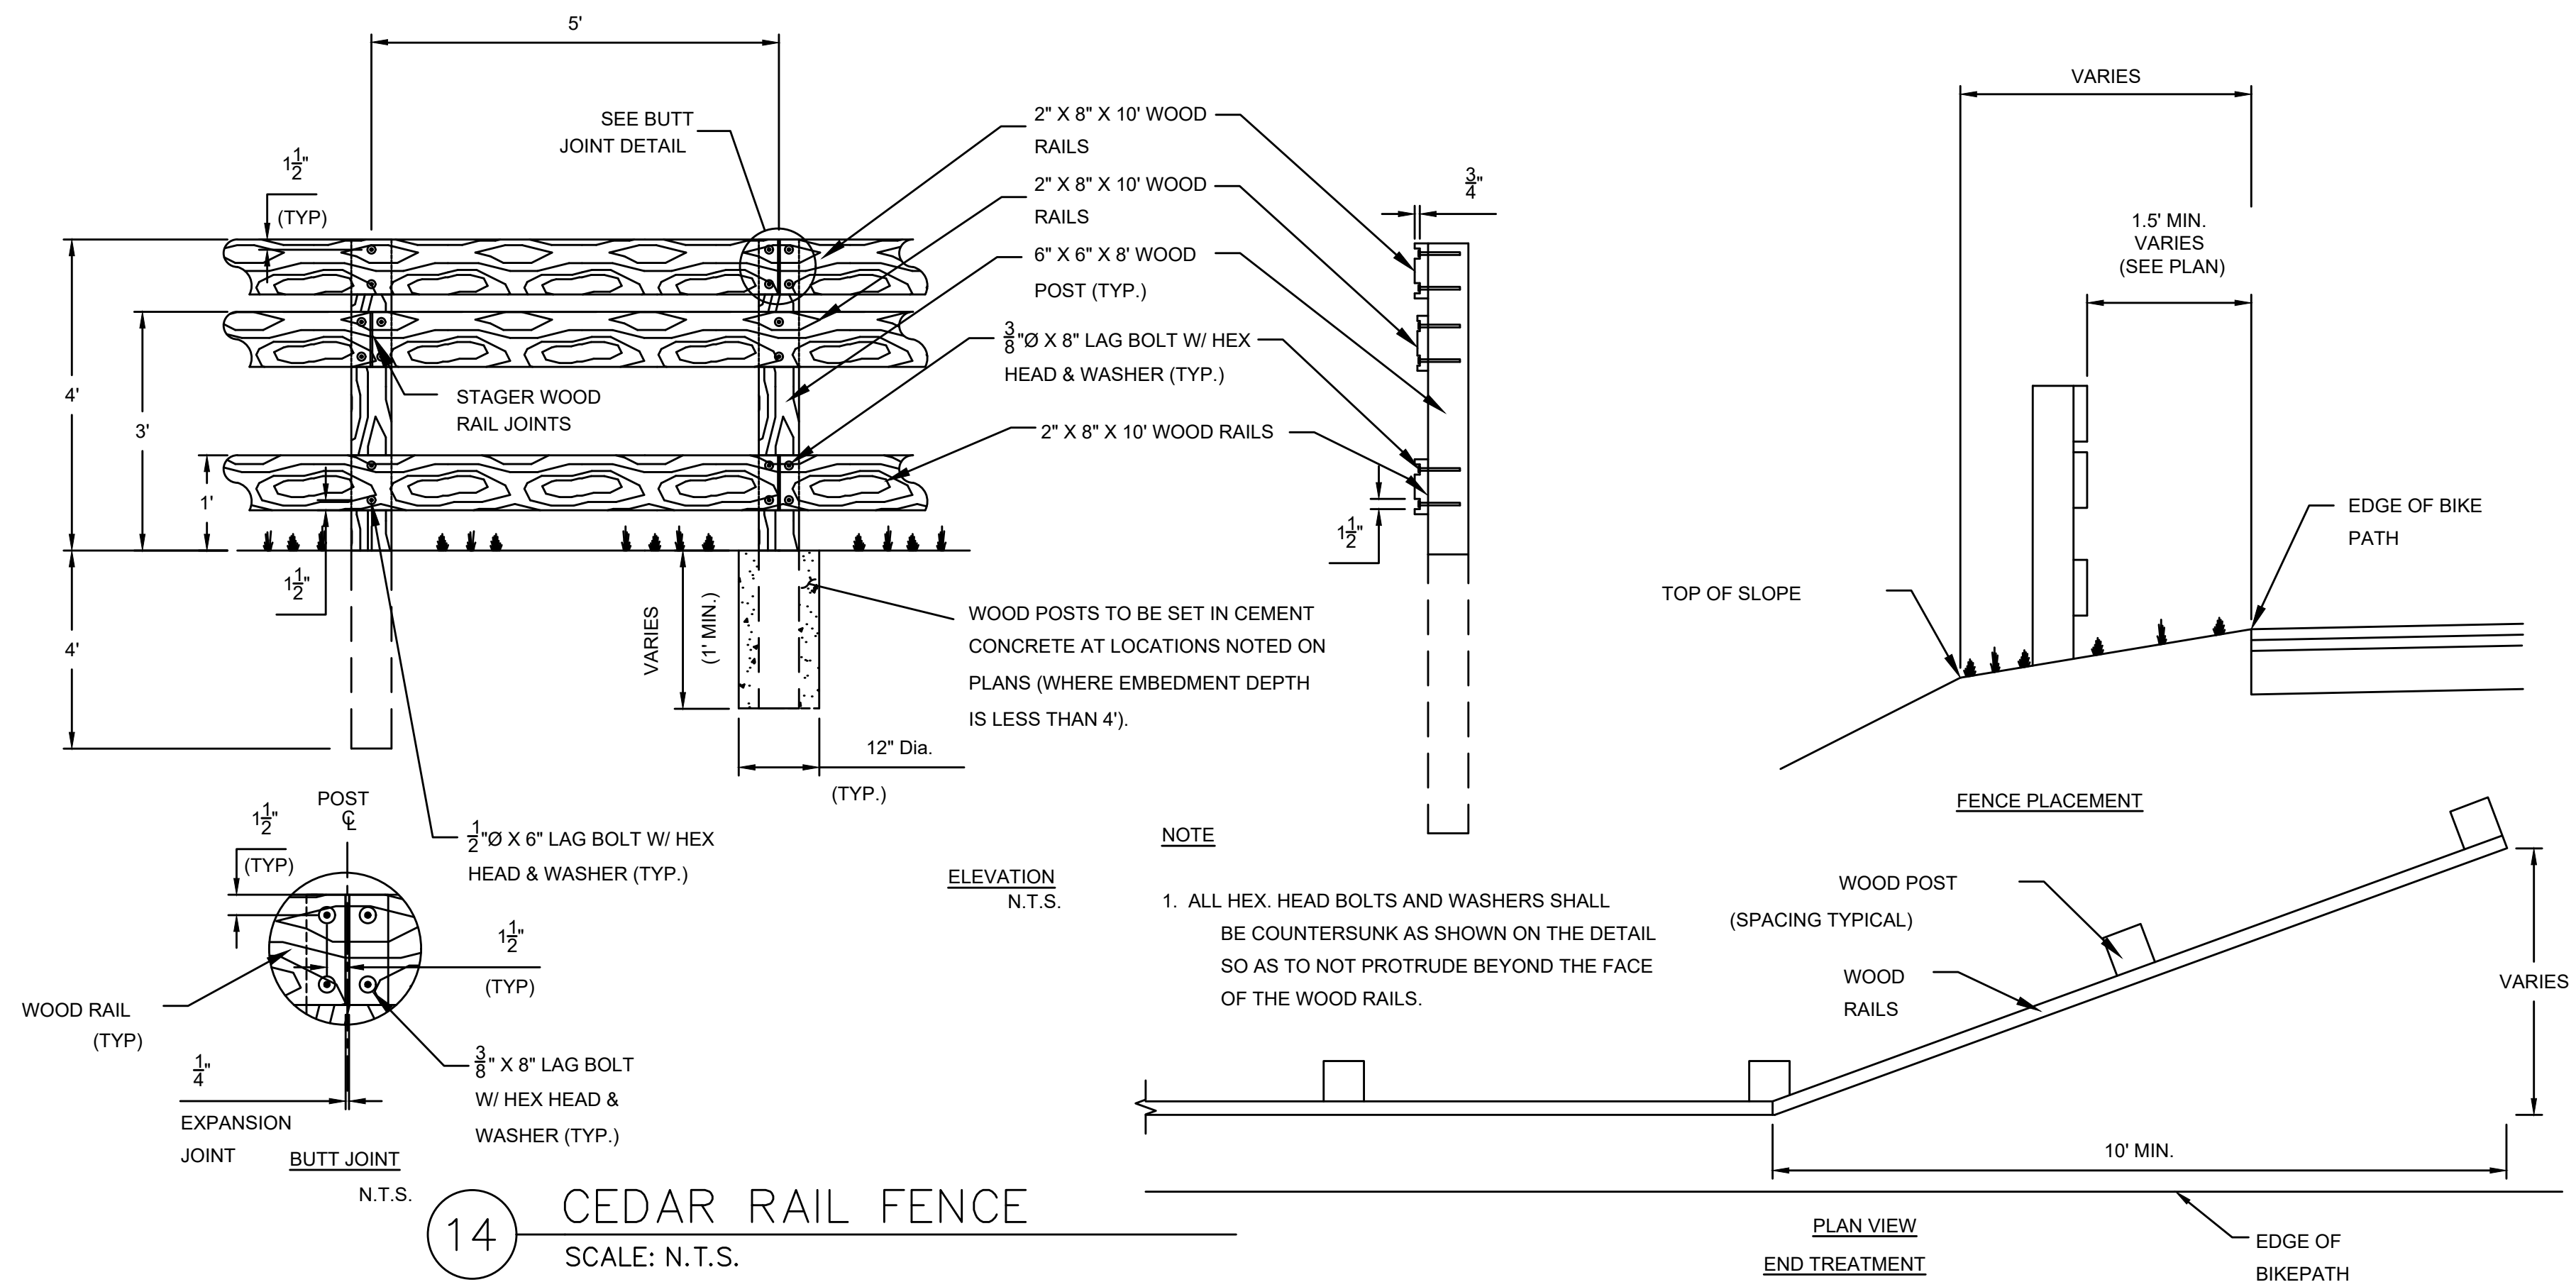

OPERATIONAL TIME BETWEEN ACTIVATION		
LOCATION #	STATION/ROADWAY	MINIMUM ALLOWABLE TIME BETWEEN ACTIVATION
1	203+87 TAYLOR ST	18s
2	38+45 FOSTER ST	12s
3	21+15 FOSTER ST	12s

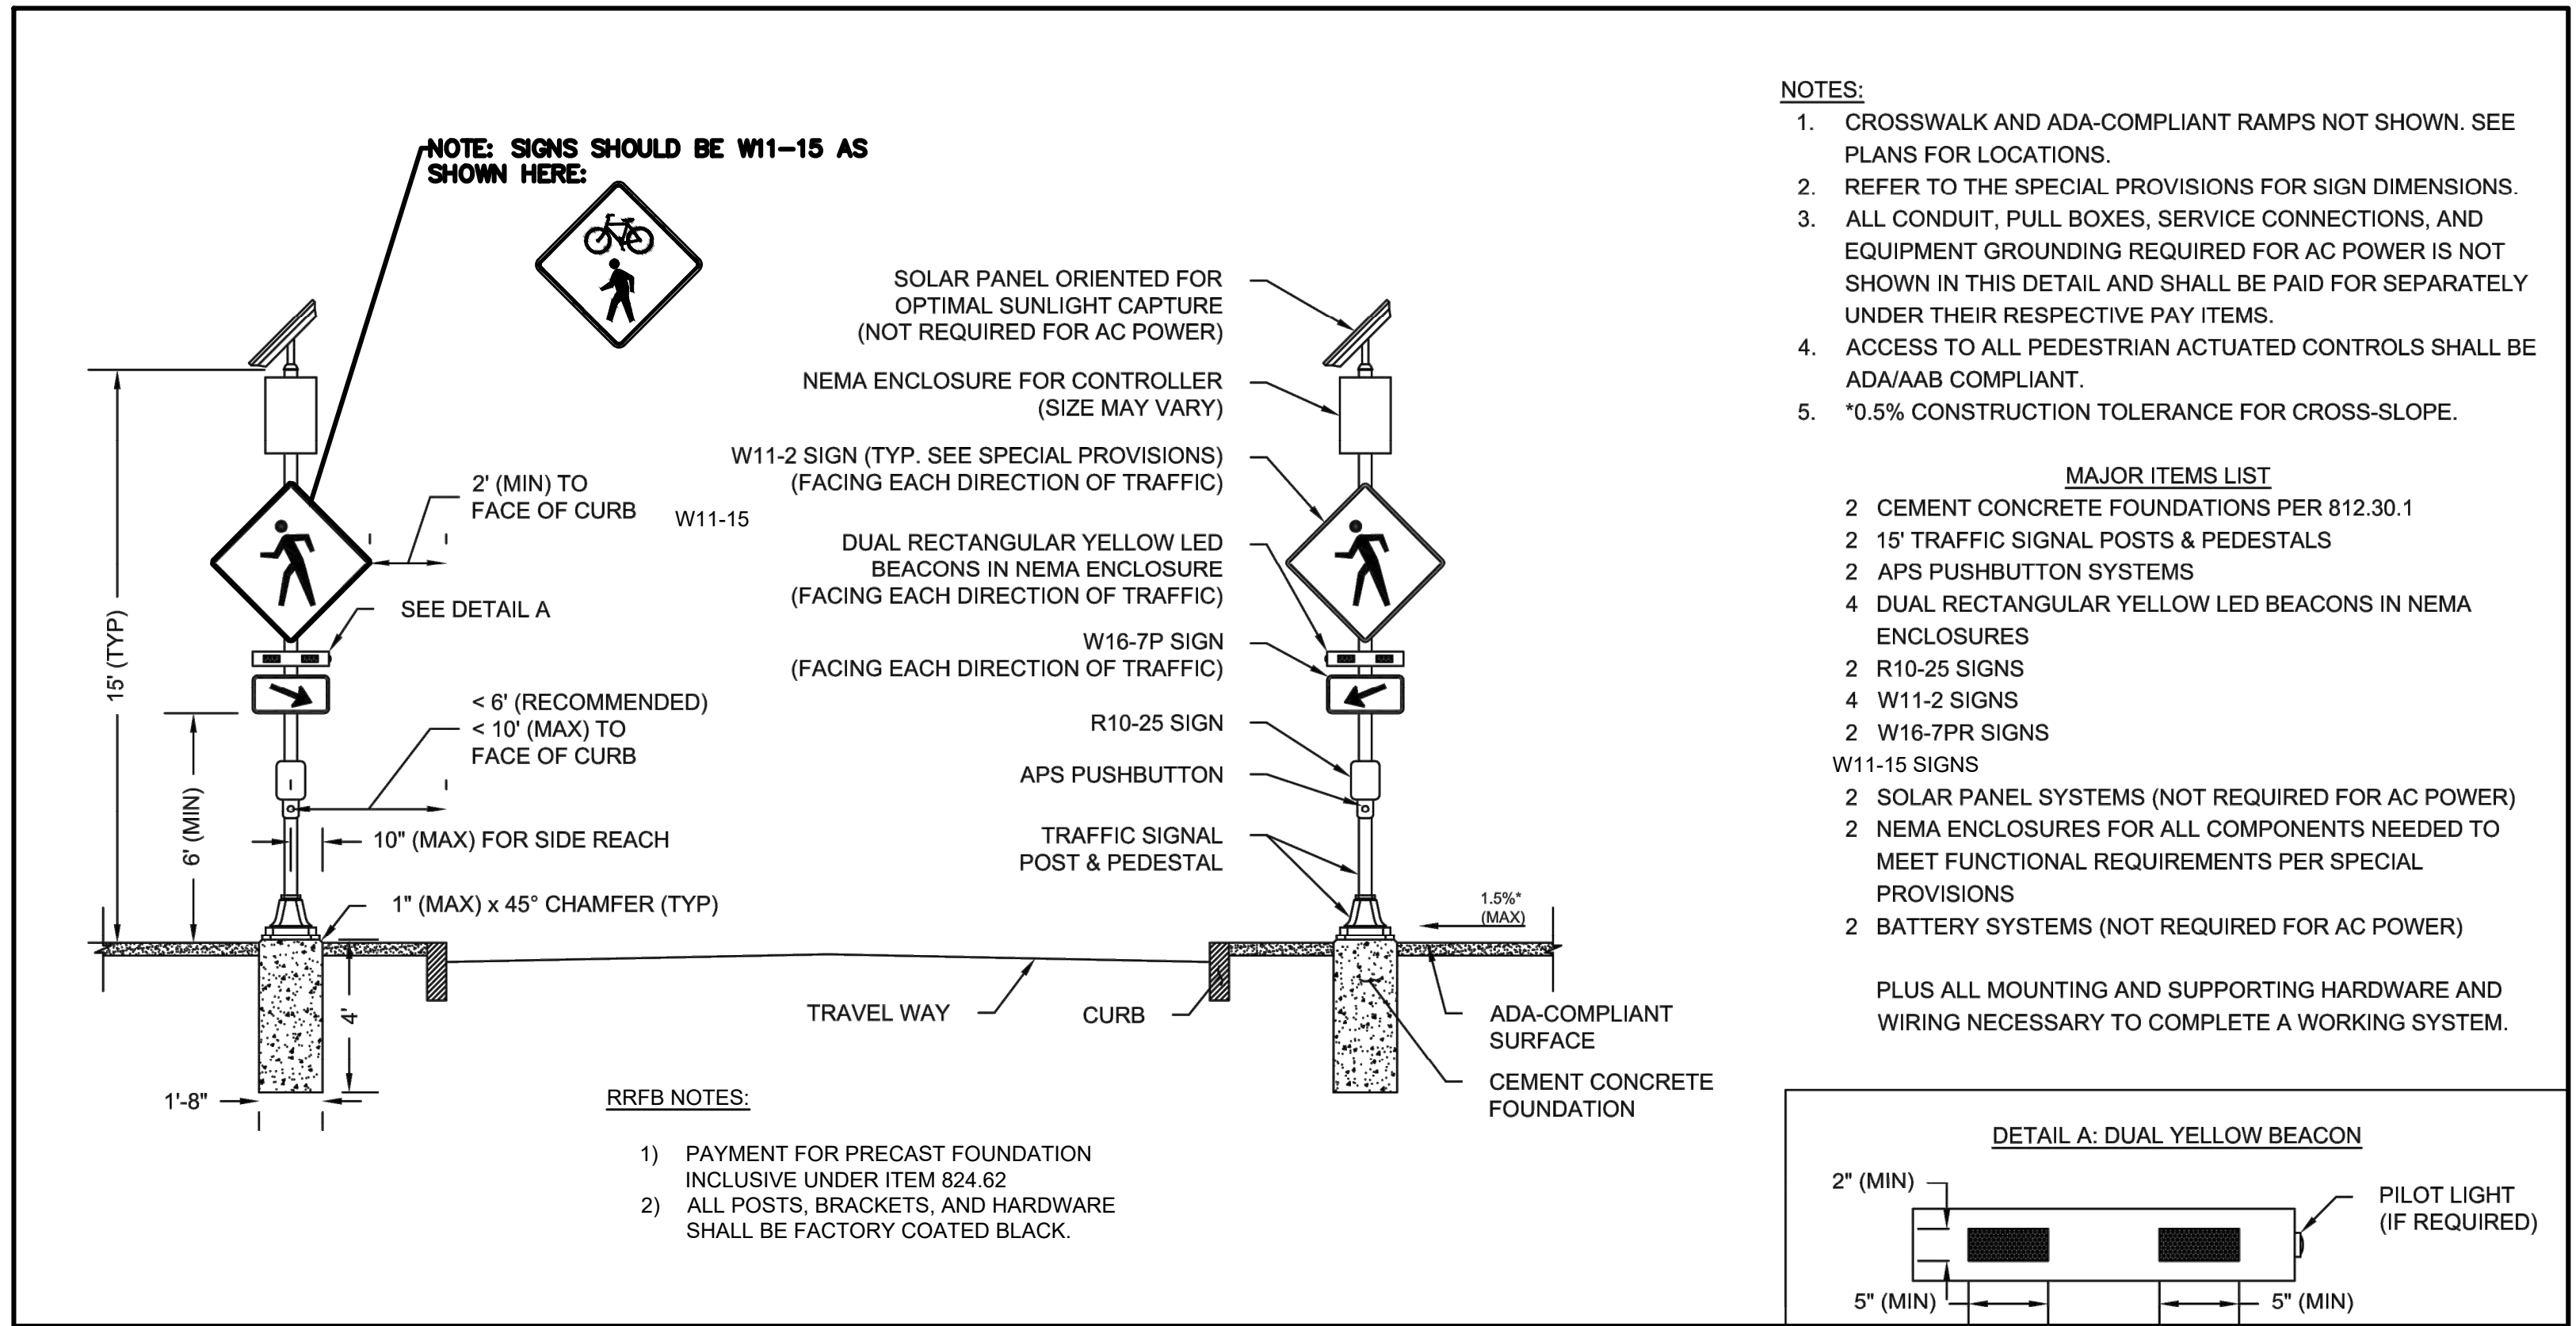

15 RECTANGULAR RAPID FLASHING BEACON (RRFB)
SCALE: N.T.S.

Appendix C

Notice To Abutters

NOTIFICATION TO ABUTTERS

Modified for Covid-19 Emergency Response

Notice of Intent or abbreviated Notice of Resource Area Delineation

Under MA Wetlands Protection Act and Littleton Wetlands Protection ByLaw (Chapter 171), this form must be completed and mailed, certified mail return receipt requested, to all abutters at their mailing addresses shown on the most recent Town Assessor's records as well as the owner (if not applicant).

In accordance with the MA Wetlands Protection Act and Littleton Wetlands Protection ByLaw Chapter 171-2D, you are hereby notified of a public hearing on the matter described below:

- A. The applicant has filed a Notice of Intent with the Littleton Conservation Commission for work in an area subject to protection under the Massachusetts Wetlands Protection Act and Littleton Wetlands Protection ByLaw.
- B. The name of the applicant is _____
- C. The address of the land where the activity is proposed is _____
- D. The work proposed is _____
Road reconstruction, shared-use path construction, water main replacement, catch basin replacement on Foster Street from Taylor Street to Balsam Lane, Intersection of Taylor Street and Foster Street, and Intersection of Grimes Lane and Foster Street
- E. Due to the Commonwealth and Town of Littleton's Covid-19 Emergency Response, it is anticipated that paper copies of the Notice of Intent will not be available for inspection. Copies of the Notice of Intent may be examined at the Conservation Commission webpage at <https://www.littletonma.org/conservation>, under "Conservation Calendar" at least 48 hours before the meeting. If you click on the day of the meeting in the Calendar, you will be lead to a link showing posted project information. If you have questions you can contact the Littleton Conservation Commission (contact information at the end of this notice).
- F. Due to the Commonwealth and Town of Littleton's Covid-19 Emergency Response, it is anticipated that paper copies of the Notice of Intent will not be available for distribution. Copies of the Notice of Intent may be obtained electronically from (check one) the ____ applicant or ____ the applicant's representative by calling ____ - ____ - ____ during the following times:

Fuss & O'Neill, Inc.
- G. The public hearing will be held on _____. Information regarding the date and time of the public hearing may be obtained from the Littleton Conservation Commission (see contact info at the end of this notice).

- H. Notice of the public hearing, including date, will be published at least five business days in advance in a paper of local circulation. The agenda, noting times will be posted at Town Hall and at <https://www.littletonma.org/conservation> under "Conservation Calendar" at least 48 hours in advance of the meeting. It is currently anticipated that this meeting will be held entirely remotely, pursuant to Governor Baker's March 12, 2020 Order Suspending Certain Provisions of the Open Meeting Law and Governor Baker's March 15, 2020 Order imposing strict limitations on the number of people that may gather in one place. If the meeting is held remotely, instructions for remote viewing of, and participation in, the meeting will be included in the agenda and may also be obtained from the Littleton Conservation Commission.

You may contact the Littleton Conservation Commission Coordinator (Amy Green; agreen@littletonma.org; 978-540-2428), or the Massachusetts Department of Environmental Protection/ Central Region (508-792-7650) at 8 New Bond Street, Worcester, MA 01606) for information about this application



**TOWN OF LITTLETON
BOARD OF ASSESSORS**

P.O. BOX 1305
LITTLETON, MA 01460
(978) 540-2410
FAX: (978) 952-2321

Date: June 21, 2023

Re: Certified List of Abutters Conservation Commission

Applicant: Aaron Keegan
Name of Firm: Fuss & O'Neill, Inc.
Mailing Address 1550 Main Street Suite 400

Subject Parcel Location: Roadway; Foster Street 238-305 & Taylor Street 221-241
Subject Parcel No.: Roadway
Subject Owner Name: Town of Littleton

M.G.L. Chapter 131: Section 40 "Any person filing a notice of intention with a conservation commission shall at the same time give written notification thereof, by delivery in hand or certified mail, return receipt requested, to all abutters within one hundred feet of the property line of the land where the activity is proposed, but not limited to, owners of land directly opposite said proposed activity on any public or private street or way, and in another municipality or across a body of water. When a notice of intent proposes activities on land under water bodies and waterways or on a tract of land greater than 50 acres, written notification shall be given to all abutters within 100 feet of the proposed project site. For the purposes of this action, "project site" shall mean lands where the following activities are proposed to take place: dredging, excavating, filling, grading, the erection, reconstruction or expansion of a building or structure, the driving of pilings, the construction or improvement of roads or other ways and the installation of drainage, sewerage and water systems, and "land under water bodies and waterways" shall mean the bottom of, or land under, the surface of the ocean or an estuary, creek, river stream, pond or lake. When a notice of intent proposes activity on a linear shaped project site longer than 1,000 feet in length, notification shall be given to all abutters within 1,000 feet of the proposed project site. If the linear project site takes place wholly within an easement through another person's land, notice shall also be given to the landowner. Said notification shall be at the applicant's expense, and shall state where copies of the notice of intention may be examined and obtained and where information regarding the date, time and place of the public hearing may be obtained. Proof of such notification, with a copy of the notice mailed or delivered, shall be filed with the conservation commission."

I hereby certify the attached list of abutter (s) as stated in the M.G.L. Chapter 131, Section 40.

Number of Abutter (s) 161

Certified by:


April Iannacone, Assistant Assessor

RTE 2	R06 2 0	234 FOSTER ST	R08 13 C	14 FRASER ST	R08 15 14
COMMONWEALTH OF MASSACHUSETTS MASS DOT 10 PARK PLAZA-REAL ESTATE DEPT BOSTON, MA 02116	LUC: 911	2021 JACOBS-ANDERSON FAMILY TR TRUSTEE JACOBS DEBORAH 234 FOSTER ST LITTLETON, MA 01460	LUC: 101	RIZZA MEGAN A RIZZA CHRISTOPHER D 14 FRASER ST LITTLETON, MA 01460	LUC: 101
212 FOSTER ST	R08 11 0	238 FOSTER ST	R08 13 D	16 FRASER ST	R08 15 15
JOURIS WILLIAM E INV TRUST JOURIS MARION E INV TRUST 212 FOSTER ST LITTLETON, MA 01460	LUC: 101	CANFIELD QUINN E CANFIELD JENNIFER A 238 FOSTER ST LITTLETON, MA 01460	LUC: 101	RICHARD MATTHEW J RICHARD CATHERINE E 16 FRASER ST LITTLETON, MA 01460	LUC: 101
216 FOSTER ST	R08 12 0	242 FOSTER ST	R08 13 E	1 FRASER ST	R08 15 16
RAUSA PAUL A/K/A RAUSA PAUL W RAUSA REBECCA A/K/A REBECCA R 216 FOSTER ST LITTLETON, MA 01460	LUC: 101	VIGNONI RICHARD B 242 FOSTER ST LITTLETON, MA 01460	LUC: 101	XIA WENYU SHEN LINMING 1 FRASER ST LITTLETON, MA 01460	LUC: 101
FIR LN	R08 13 0	230 FOSTER ST	R08 14 0	3 FRASER ST	R08 15 17
TOWN OF LITTLETON PO BOX 1305 LITTLETON, MA 01460	LUC: 930	BAUCOM ALLAN 230 FOSTER ST LITTLETON, MA 01460	LUC: 101	KOSINSKI-COLLINS MELISSA S COLLINS JOHN A IV 3 FRASER ST LITTLETON, MA 01460	LUC: 101
5 FIR LN	R08 13 2	260 FOSTER ST	R08 15 0	5 FRASER ST	R08 15 18
LAFERTY CRAIG WILLIAM JR LAFERTY KRISTIN MELENEY 5 FIR LN LITTLETON, MA 01460	LUC: 101	DURKEE FARM BUILDERS INC 487 GROTON RD WESTFORD, MA 01886	LUC: 101	STEVENS CLIFFORD S STEVENS TIFFANY D 5 FRASER ST LITTLETON, MA 01460	LUC: 101
3 FIR LN	R08 13 3	31 GRIMES LN	R08 15 1	7 FRASER ST	R08 15 19
BELIN EVGENI KUKLINA POLINA 3 FIR LN LITTLETON, MA 01460	LUC: 101	BRANDON & KARA GUSTAFSON 2021 GUSTAFSON BRANDON FORD 31 GRIMES LN LITTLETON, MA 01460	LUC: 101	SHARMA MANOJ K SHARMA PUJA 7 FRASER ST LITTLETON, MA 01460	LUC: 101
1 FIR LN	R08 13 4	6 FRASER ST	R08 15 10	BALSAM LN	R08 15 2
TODD & JENNIFER SHULMAN REV TR SHULMAN TODD L, TRUSTEE 1 FIR LN LITTLETON, MA 01460	LUC: 101	KARNATI V V REDDY 2017 REV TR KARNATI KAVITHA 2017 REV TR 6 FRASER ST LITTLETON, MA 01460	LUC: 101	LITTLETON TOWN OF 37 SHATTUCK ST LITTLETON, MA 01460	LUC: 930
1 DOUGLAS RD	R08 13 5	8 FRASER ST	R08 15 11	8 SPRUCE ST	R08 15 20
GE JIJUN SUN YUQING 1 DOUGLAS RD LITTLETON, MA 01460	LUC: 101	ROTHLEUTNER KRISTOFFER BRICE ROTHLEUTNER LAURIE ANN 8 FRASER ST LITTLETON, MA 01460	LUC: 101	CROAL SEAN C CROAL KATHLEEN A 8 SPRUCE ST LITTLETON, MA 01460	LUC: 101
220 FOSTER ST	R08 13 A	10 FRASER ST	R08 15 12	6 SPRUCE ST	R08 15 21
CYNTHIA G DUBE REV TRUST DUBE GREGORY P & CYNTHIA G TRS 220 FOSTER ST LITTLETON, MA 01460	LUC: 101	ZHANG YULIAN 10 FRASER ST LITTLETON, MA 01460	LUC: 101	AHUJA NEERAJ S AHUJA KIRAN N 6 SPRUCE ST LITTLETON, MA 01460	LUC: 101
224 FOSTER ST	R08 13 B	12 FRASER ST	R08 15 13	4 SPRUCE ST	R08 15 22
BLANCHARD JOHN BLANCHARD TERESA 224 FOSTER STREET LITTLETON, MA 01460	LUC: 101	ZHENG MINXING CHAN LAI SIM 12 FRASER ST LITTLETON, MA 01460	LUC: 101	PEDDI SRINIVASA PEDDI PRASUNA 4 SPRUCE ST LITTLETON, MA 01460	LUC: 101

2 SPRUCE ST	R08 15 23	15 GRIMES LN	R08 15 39	FRASER ST	R08 15 A
ALLA PAVAN KUMAR	LUC: 101	GALLO JOSEPH MICHAEL	LUC: 101	DURKEE FARM BUILDERS INC	LUC: 132
JAVVADI SAI SWETHA		GALLO ALEXANDRA A		487 GROTON RD	
2 SPRUCE ST		15 GRIMES LN		WESTFORD, MA 01886	
LITTLETON, MA 01460		LITTLETON, MA 01460			
3 SPRUCE ST	R08 15 24	FRASER ST	R08 15 4	264 FOSTER ST	R08 37 0
DEVIREDDY NARAYAN	LUC: 101	LITTLETON TOWN OF	LUC: 930	BOSTON & MAINE RAILROAD	LUC: 901
DEVIREDDY APARNA S		37 SHATTUCK ST		C/O GUILFORD TRANSPORTATION	
3 SPRUCE ST		LITTLETON, MA 01460		IRON HORSE PARK	
LITTLETON, MA 01460				TAX DEPT 67 HIGH ST	
5 SPRUCE ST	R08 15 25	11 GRIMES LN	R08 15 40	NO BILLERICA, MA 01862	
SANMARCO CARLOS A CANDIOTTI	LUC: 101	POPE CAREY NAT	LUC: 101	196 FOSTER ST	R08 8 0
ANDRADE DE VASCONCELOS D A		POPE JING LIU		LITTLETON, MA 01460	LUC: 101
5 SPRUCE ST		11 GRIMES LN			
LITTLETON, MA 01460		LITTLETON, MA 01460			
7 SPRUCE ST	R08 15 26	7 GRIMES LN	R08 15 41	198 FOSTER ST	R08 8 1
LU JIANHONG	LUC: 101	KELA AMITKUMAR B	LUC: 101	GRANT ANDREW F	LUC: 101
NI QUANHONG		KACHOLIYA MOUSHMI		GRANT LORI G	
7 SPRUCE ST		7 GRIMES LN		198 FOSTER STREET	
LITTLETON, MA 01460		LITTLETON, MA 01460		LITTLETON, MA 01460	
9 SPRUCE ST	R08 15 27	3 GRIMES LN	R08 15 42	202 FOSTER ST	R08 9 0
KRUPNIK ERIC F	LUC: 101	ROSHAN RAKESH	LUC: 101	VIRTUE-STRACKE FAMILY TRUST	LUC: 101
BEAUDOIN JENNIFER A		PANKAJ SWARNICA		TRUSTEE STRACKE JOHN	
9 SPRUCE ST		3 GRIMES LN		202 FOSTER ST	
LITTLETON, MA 01460		LITTLETON, MA 01460		LITTLETON, MA 01460	
11 SPRUCE ST	R08 15 28	GRIMES LN	R08 15 5	204 FOSTER ST	R08 9 2
MORRISON JODY	LUC: 101	LITTLETON TOWN OF	LUC: 930	LITTLETON TOWN OF	LUC: 930
MORRISON KAREN		37 SHATTUCK ST		PO BOX 1305	
11 SPRUCE ST		LITTLETON, MA 01460		LITTLETON, MA 01460	
LITTLETON, MA 01460					
BALSAM LN	R08 15 3	GRIMES LN	R08 15 6	206 FOSTER ST	R08 9 3
LITTLETON TOWN OF	LUC: 930	LITTLETON TOWN OF	LUC: 930	LITTLETON TOWN OF	LUC: 930
37 SHATTUCK ST		37 SHATTUCK ST		PO BOX 1305	
LITTLETON, MA 01460		LITTLETON, MA 01460		LITTLETON, MA 01460	
27 GRIMES LN	R08 15 36	7 BALSAM LN	R08 15 7	208 FOSTER ST	R08 9 A
LODER FAMILY TRUST	LUC: 101	MITCHELL ANDREW JAMES	LUC: 101	SULLIVAN CONOR	LUC: 101
TRUSTEE LODER CORY R		LEEDO DESIREE MARIE		SULLIVAN SAMANTHA	
27 GRIMES LN		7 BALSAM LN		208 FOSTER ST	
LITTLETON, MA 01460		LITTLETON, MA 01460		LITTLETON, MA 01460	
23 GRIMES LN	R08 15 37	9 BALSAM LN	R08 15 8	2 BULKELEY RD	R09 1 0
ARMSTRONG WILLIAM	LUC: 101	ANDERSEN MARK A	LUC: 101	COOPER BONNIE	LUC: 101
ARMSTRONG ASHLEY		ANDERSEN JULIE		MAHER-COOPER GINNY M	
23 GRIMES LN		9 BALSAM LN		2 BULKELEY RD	
LITTLETON, MA 01460		LITTLETON, MA 01460		LITTLETON, MA 01460	
19 GRIMES LN	R08 15 38	2 FRASER ST	R08 15 9	6 BULKELEY RD	R09 1 A
ARUMUGASAMY JEEVANANDAM	LUC: 101	FORSBERG JAMES M	LUC: 101	HORNE ALEXANDER C	LUC: 101
JEEVANANDAM VAIJAYANTHIMALA		FORSBERG MEGAN		MCLEOD SAMANTHA	
19 GRIMES LN		2 FRASER ST		6 BULKELEY RD	
LITTLETON, MA 01460		LITTLETON, MA 01460		LITTLETON, MA 01460	

10 BULKELEY RD	R09 2 0	238 TAYLOR ST	R09 31 0	BULKELEY RD	R09 5 0
WHEELER JOHN L + KAREN L CO-TR OF THE J + K REALTY TRUST 63 JUNIPER CREEK BLVD PINEHURST, NC 28374	LUC: 105	MACLEOD DOUGLAS S MACLEOD LOLA F 238 TAYLOR ST LITTLETON, MA 01460	LUC: 101	WEBSTER LYLE D WEBSTER GRETCHEN O 33 BULKELEY RD LITTLETON, MA 01460	LUC: 601
12 BULKELEY RD	R09 2 1	236 TAYLOR ST	R09 31 1	17 BULKELEY RD	R09 5 2
CLARK KEVIN J CLARK LAN 12 BULKELEY RD LITTLETON, MA 01460	LUC: 101	CURRAN JAMES P RIGALI YOLANDA M 236 TAYLOR ST LITTLETON, MA 01460	LUC: 101	GRAY DANA C GRAY KARIN M 17 BULKELEY ROAD LITTLETON, MA 01460	LUC: 101
15 CRANE RD	R09 24 0	240 TAYLOR ST	R09 31 2	33 BULKELEY RD	R09 5 3
PALERMO JR PAUL A PALERMO CARRIE J 15 CRANE RD LITTLETON, MA 01460	LUC: 101	SCULLY KATHLEEN K 240 TAYLOR ST LITTLETON, MA 01460	LUC: 101	WEBSTER LYLE D WEBSTER GRETCHEN O 33 BULKELEY RD LITTLETON, MA 01460	LUC: 101
13 CRANE RD	R09 25 2	242 TAYLOR ST	R09 31 3	19 BULKELEY RD	R09 5 4
MEUNIER JONATHAN P MEUNIER KATELYN R 34 BAY DR SUDBURY, MA 01776	LUC: 106	DRINKWATER LAURA J 242 TAYLOR ST LITTLETON, MA 01460	LUC: 101	PRATAPA RADHA K PUTCHA VEENA S 19 BULKELEY RD LITTLETON, MA 01460	LUC: 101
8 CRANE RD	R09 28 0	244 TAYLOR ST	R09 31 4	23 BULKELEY RD	R09 5 5
ARMSTRONG JOANNIE L STORMWIND BRIAN L 8 CRANE ROAD LITTLETON, MA 01460	LUC: 101	MOHLENHOFF BENJAMIN A MOHLENHOFF BROOKE E 244 TAYLOR ST LITTLETON, MA 01460	LUC: 101	PAVLOVIC DRAGANA KARLSSON JONAS 23 BULKELEY ROAD LITTLETON, MA 01460	LUC: 101
253 TAYLOR ST	R09 29 0	230 TAYLOR ST	R09 32 0	21 BULKELEY RD	R09 5 6
PARTHASARATHY VIJAYAN NAGENDRA BHAVANA 253 TAYLOR ST LITTLETON, MA 01460	LUC: 101	GRADY JOHN K TRUSTEE OF FOSTER/TAYLOR REALTY TRUST CONCORD ASSC- 323 WEST MAIN ST AYER, MA 01432	LUC: 441	THE FENTON FAMILY TRUST TRUSTEE FENTON JAMES T 21 BULKELEY RD LITTLETON, MA 01460	LUC: 101
4 LIBERTY SQ	R09 29 A	232 TAYLOR ST	R09 32 A	25 BULKELEY RD	R09 5 7
CANNISTRARO CHANG FAM TR CANNISTRARO DD & CHANG JC-TRS 4 LIBERTY SQUARE LITTLETON, MA 01460	LUC: 101	GRADY J, D RICE TRUSTEES OF CONCORD ASSOC FOSTER ST TRUST 323 WEST MAIN STREET AYER, MA 01432	LUC: 403	WEBSTER LYLE D WEBSTER GRETCHEN O 33 BULKELEY RD LITTLETON, MA 01460	LUC: 016
1247 HILL RD	R09 29 C	300 FOSTER ST	R09 33 0	3 BULKELEY RD	R09 5 A
MCHUTCHEON JOHN P+ELIZABETH TR JOHN/ELIZABETH MCHUTCHEON LVG 1247 HILL RD LITTLETON, MA 01460-2000	LUC: 101	GRADY JOHN K, RICE DAVID B OF CONCORD ASSCS FOSTER ST TR 323 WEST MAIN STREET AYER, MA 01432	LUC: 404	LENNON JOSEPH W+AMANDA TRS OF AMANDA+JOSEPH LENNON LIVING TR 3 BULKELEY RD LITTLETON, MA 01460	LUC: 101
BULKELEY RD	R09 3 0	234 TAYLOR ST	R09 34 0	7 BULKELEY RD	R09 5 B
LITTLETON CONSERVATION TRUST P O BOX 594 LITTLETON, MA 01460	LUC: 950	PREMIER HEALTHCARE GROUP, LLC 234 TAYLOR ST LITTLETON, MA 01460	LUC: 400	WARD KEITH A 7 BULKELEY RD LITTLETON, MA 01460	LUC: 101
LIBERTY SQ	R09 30 0	OFF BULKELEY RD	R09 4 0	11 BULKELEY RD	R09 5 C
LITTLETON TOWN OF PARK DEPARTMENT PO BOX 1305 LITTLETON, MA 01460	LUC: 930	BOSTON & MAINE RAILROAD C/O GUILFORD TRANSPORTATION IRON HORSE PARK TAX DEPT 67 HIGH ST NO BILLERICA, MA 01862	LUC: 901	WALSH JR VANCE J V 11 BULKELEY RD LITTLETON, MA 01460	LUC: 101

15 BULKELEY RD	R09 5 D	10 CRANE RD	R09 6 P	1250 HILL RD	R10 19 0
CROWLEY JENNIFER L TRUSTEE OF 15 BULKELEY ROAD REALTY TRUST 15 BULKELEY ROAD LITTLETON, MA 01460	LUC: 101	BERTOLINO VINCENT & MELISSA H 10 CRANE RD LITTLETON, MA 01460	LUC: 101	SONI DEEPAK DHILLON SHUBHLAKHAN KAUR 1250 HILL RD LITTLETON, MA 01460	LUC: 101
284 FOSTER ST	R09 5 E	14 BULKELEY RD	R09 7 2	305 FOSTER ST	R10 2 1
BALZOTTI GREGORY BALZOTTI SHERI 284 FOSTER STREET LITTLETON, MA 01460	LUC: 101	MURPHY JOHN E 14 BULKELEY RD LITTLETON, MA 01460	LUC: 101	2641-2651 SANTA ANNA AVE LLC 80 ERDMAN WAY SUITE 301 LEOMINSTER, MA 01453	LUC: 404
286 FOSTER ST	R09 5 F	20 BULKELEY RD	R09 7 4	295 FOSTER ST	R10 2 2
KENYON BROCKTON COLLINS AINE 286 FOSTER ST LITTLETON, MA 01460	LUC: 101	KUMAR SUMIT KUMAR ANGELINE G 20 BULKELEY RD LITTLETON, MA 01460	LUC: 101	ASIJA PROPERTIES LLC C/O SANDEEP ASIJA 440 CENTRAL STREET ACTON, MA 01720	LUC: 404
290 FOSTER ST	R09 5 G	277 FOSTER ST	R10 1 0	1252 HILL RD	R10 20 0
RIZZOLO ANTHONY J RIZZOLO JOSEPHINE 290 FOSTER ST LITTLETON, MA 01460	LUC: 101	MCCATHERIN JORDAN S 277-279 FOSTER ST LITTLETON, MA 01460	LUC: 104	KLOCK JAMES CAMPBELL-KLOCK PRISCILLA 1252 HILL RD LITTLETON, MA 01460	LUC: 101
14 CRANE RD	R09 6 0	215 TAYLOR ST	R10 10 0	1254 HILL RD	R10 21 0
SLUYSKI KRISTEN L 14 CRANE RD LITTLETON, MA 01460	LUC: 101	CHB LITTLETON LLC 20 GARDEN ST DANVERS, MA 01923	LUC: 104	MARRESE CHRISTOPHER R MARRESE NANCY A 1254 HILL RD LITTLETON, MA 01460	LUC: 101
16 CRANE RD	R09 6 A	205 TAYLOR ST	R10 11 0	1256 HILL RD	R10 22 0
HILSINGER NANCY L TRUSTEE OF NANCY L HILSINGER INVSTMT TR 16 CRANE RD LITTLETON, MA 01460	LUC: 101	CMH LITTLETON LLC 20 GARDEN ST DANVERS, MA 01923	LUC: 316	MORRISON BRUCE A MORRISON NANCY L 1256 HILL RD LITTLETON, MA 01460	LUC: 101
20 CRANE RD	R09 6 B	153 TAYLOR ST	R10 14 0	247 TAYLOR ST	R10 23 0
STALL ROBERT A 20 CRANE RD LITTLETON, MA 01460	LUC: 101	LITTLETON WATER DEPARTMENT 39 AYER RD LITTLETON, MA 01460	LUC: 930	SHIMMEL GARY A + KATHLEEN M TRUSTEES OF ATS REALTY TRUST 456 NEWTOWN RD LITTLETON, MA 01460-2206	LUC: 101
24 CRANE RD	R09 6 C	151 TAYLOR ST	R10 14 1	3 WESTVIEW RD	R10 3 0
MCCURDY III ALEXANDER S MCCURDY BRENDA M 24 CRANE ROAD LITTLETON, MA 01460	LUC: 101	LML LITTLETON LLC 401 EDGEWATER PLACE, SUITE 265 WAKEFIELD, MA 01880	LUC: 401	GUTIERREZ ARTURO+CATALDO CLASS B TRS, SWEENEY D CLASS A TR C/O THE GUTIERREZ COMPANY 200 WHEELER ROAD BURLINGTON, MA 01803	LUC: 440
28 CRANE RD	R09 6 D	MONARCH DR	R10 16 B	1 WESTVIEW RD	R10 3 1
DIMASE JOHN F W DIMASE LOIS B 28 CRANE ROAD LITTLETON, MA 01460	LUC: 101	VMD INDUSTRIAL V LLC 733 TURNPIKE ST, ROUTE 114 NORTH ANDOVER, MA 01845	LUC: 440	GUTIERREZ ARTURO+CATALDO CLASS B TRS, SWEENEY D CLASS A TR C/O THE GUTIERREZ COMPANY 200 WHEELER ROAD BURLINGTON, MA 01803	LUC: 440
12 CRANE RD	R09 6 N	200 TAYLOR ST	R10 18 0	2 WESTVIEW RD	R10 3 2
GARBERO PETRA V 12 CRANE RD LITTLETON, MA 01460	LUC: 101	FLETCHER JOHN L /JAMES L TR FLETCHER TRUST NO 1 192 DEPOT RD PO BOX 401 EAST TEMPLETON, MA 01438-0401	LUC: 410	GUTIERREZ ARTURO+CATALDO CLASS B TRS, SWEENEY D CLASS A TR C/O THE GUTIERREZ COMPANY 200 WHEELER ROAD BURLINGTON, MA 01803	LUC: 440

11 WESTVIEW RD	R10 3 3	193 FOSTER ST	R11 11 1	134 TAYLOR ST	R11 27 0
LUC: 440		LUC: 109		LUC: 410	
GUTIERREZ ARTURO+CATALDO CLASS		CARROLL KEITH S		TAYLOR STREET HOLDINGS LLC	
B TRS, SWEENEY D CLASS A TR		CARROLL LISA M		53 MIDLAND DR	
C/O THE GUTIERREZ COMPANY		193 FOSTER ST		WALTHAM, MA 02451	
200 WHEELER ROAD		LITTLETON, MA 01460			
BURLINGTON, MA 01803					
MONARCH DR	R10 4 0	FOSTER ST	R11 2 0	245 FOSTER ST	R11 3 0
LUC: 601		LUC: 901		LUC: 441	
HARVARD SPORTSMENS CLUB INC		BOSTON & MAINE RAILROAD		SNS FOSTER LLC	
P.O.BOX 114		C/O GUILFORD TRANSPORTATION		C/O ROBERT LONG	
HARVARD, MA 01451		IRON HORSE PARK		30 HARWOOD AV	
		TAX DEPT 67 HIGH ST		LITTLETON, MA 01460	
		NO BILLERICA, MA 01862			
241 TAYLOR ST	R10 5 0	18 TROT RD	R11 23 16	215 FOSTER ST	R11 3 1
LUC: 014		LUC: 932		LUC: 101	
MORRISON BRUCE AL		LITTLETON TOWN OF		AQUINO KENNETH C	
241 TAYLOR ST		CONSERVATION COMMISSION		BETEAU WANDA JANE	
LITTLETON, MA 01460		PO BOX 1305		215 FOSTER ST	
		LITTLETON, MA 01460		LITTLETON, MA 01460	
TAYLOR ST	R10 6 0	6 TROT RD	R11 23 2	217 FOSTER ST	R11 3 2
LUC: 440		LUC: 101		LUC: 101	
GUTIERREZ ARTURO+CATALDO CLASS		HELMAN TIMOTHY		HORN KRISTIN H	
B TRS, SWEENEY D CLASS A TR		6 TROT ROAD		LAUFFENBURGER CHRISTOPHER J	
C/O THE GUTIERREZ COMPANY		LITTLETON, MA 01460		217 FOSTER ST	
200 WHEELER ROAD				LITTLETON, MA 01460	
BURLINGTON, MA 01803					
225 TAYLOR ST	R10 7 0	8 TROT RD	R11 23 3	219 FOSTER ST	R11 3 3
LUC: 440		LUC: 101		LUC: 101	
GUTIERREZ ARTURO+CATALDO CLASS		GRANT JONATHAN H		TJIONAS GEORGE A	
B TRS, SWEENEY D CLASS A TR		GRANT KATE M		BOUMITRI MICHELLE M	
C/O THE GUTIERREZ COMPANY		8 TROT ROAD		219 FOSTER ST	
200 WHEELER ROAD		LITTLETON, MA 01460		LITTLETON, MA 01460	
BURLINGTON, MA 01803					
219 TAYLOR ST	R10 8 0	10 TROT RD	R11 23 4	221 FOSTER ST	R11 3 4
LUC: 101		LUC: 101		LUC: 101	
FOSS WILLIAM R, FOSS JANICE M		ABETZ WENDY		GRACE JULIE DAHLBERG	
CHARLTON ELIZABETH A		10 TROT ROAD		GRACE FRANK P	
219 TAYLOR ST		LITTLETON, MA 01460		221 FOSTER ST	
LITTLETON, MA 01460				LITTLETON, MA 01460	
265 FOSTER ST	R11 1 0	12 TROT RD	R11 23 5	263 FOSTER ST	R11 3 5
LUC: 401		LUC: 101		LUC: 972	
VAF I 265 FOSTER LLC		KINGSLEY SCOTT M + CASSONDRA L		MASS BAY TRANS AUTHORITY	
14241 DALLAS PKWY, SUITE 650		CO-TR SCOTT+CASSONDRA KINGSLEY		TEN PARK PLAZA	
DALLAS, TX 75254		12 TROT ROAD		BOSTON, MA 02116	
		LITTLETON, MA 01460			
REAR FOSTER ST	R11 1 2	14 TROT RD	R11 23 6	150 TAYLOR ST	R11 30 0
LUC: 441		LUC: 101		LUC: 950	
VAF I 265 FOSTER LLC		HIGGINS FAMILY 2021 REVOCABLE		NEW ENGLAND FORESTRY FNDTN INC	
14241 DALLAS PKWY, SUITE 650		HIGGINS KENNETH E, TRUSTEE		PO BOX 1346	
DALLAS, TX 75254		14 TROT ROAD		LITTLETON, MA 01460	
		LITTLETON, MA 01460			
REAR FOSTER ST	R11 1 3	16 TROT RD	R11 23 7	N/W OF 495	R11 31 0
LUC: 441		LUC: 101		LUC: 950	
VAF I 265 FOSTER LLC		16 TROT ROAD NOMINEE REALTY TR		LITTLETON CONSERVATION TRUST	
14241 DALLAS PKWY, SUITE 650		ANDERSON ERIC, TRUSTEE		P O BOX 594	
DALLAS, TX 75254		16 TROT RD		LITTLETON, MA 01460	
		LITTLETON, MA 01460			
191 FOSTER ST	R11 11 0	OFF TAYLOR ST	R11 26 0	237 FOSTER ST	R11 5 4
LUC: 304		LUC: 950		LUC: 101	
NASHOBA VALLEY SNF REAL ESTATE		LITTLETON CONSERVATION TRUST		NARGIZIAN PATRICIA A	
INVESTORS LLC		PO BOX 594		P.O. BOX 1003	
3570 KEITH ST		LITTLETON, MA 01460		LITTLETON, MA 01460-1003	
NW CLEVELAND, TN 37312					

233 FOSTER ST	R11 6 0
CAREW MICHAEL J	LUC: 101
WEINER MICHELLE B	
233 FOSTER ST	
LITTLETON, MA 01460	
225 FOSTER ST	R11 7 0
KIERNAN KAREN A	LUC: 101
KIERNAN TODD D	
225 FOSTER ST	
LITTLETON, MA 01460	
211 FOSTER ST	R11 8 0
RICHARDSON TODD P	LUC: 101
RICHARDSON MEREDITH K	
211 FOSTER ST	
LITTLETON, MA 01460	
201 FOSTER ST	R11 9 0
CONLON MARK D	LUC: 101
SCHOPF-CONLON LISA R	
201 FOSTER ST	
LITTLETON, MA 01460	
203 FOSTER ST	R11 9 1
MCDONALD MICHAEL ADAM	LUC: 101
MACISAAC KELLY ANN	
203 FOSTER STREET	
LITTLETON, MA 01460	
3 JILLIAN WAY	R11 9 2
SCHOFIELD FRANK B	LUC: 101
SCHOFIELD MAURA C	
3 JILLIAN WAY	
LITTLETON, MA 01460	
5 JILLIAN WAY	R11 9 3
VASUDEVAN MADHUSUDHANAN	LUC: 101
MADHUSUDHAN SRIVIDYA	
5 JILLIAN WAY	
LITTLETON, MA 01460	
4 JILLIAN WAY	R11 9 4
ASLAM SAMI	LUC: 101
AZAM SEEMA	
4 JILLIAN WAY	
LITTLETON, MA 01460	
2 JILLIAN WAY	R11 9 5
YOUNG FAMILY REALTY TRUST	LUC: 101
TRUSTEE YOUNG BRIAN S	
2 JILLIAN WAY	
LITTLETON, MA 01460	
1 JILLIAN WAY	R11 9 B
FRIEDMAN MICHAEL P	LUC: 101
LEE SOYOUNG	
1 JILLIAN WY	
LITTLETON, MA 01460	

1 HARWOOD AV	U41 23 0
BOSTON & MAINE RAILROAD	LUC: 901
C/O GUILFORD TRANSPORTATION	
IRON HORSE PARK	
67 HIGH ST	
NO BILLERICA, MA 01862	

Appendix D

Wetland Delineation Report



Massachusetts Inland Resource Area Delineation Report

Report Date: September 11, 2018

Prepared For: Mr. Chris Stoddard, P.E., Director of Public Works, Highway Department
P.O. Box 1305
39 Ayer Road (Rte. 2A)
Littleton, MA 01460

Site Address/Location: Foster Street, Littleton, MA
42.518314°N, 71.503733°W

Inspection Date(s): July 19, 2018

Regulated Inland Wetland Resource Areas:

- | | |
|---|---|
| <input checked="" type="checkbox"/> Bank | <input checked="" type="checkbox"/> Bordering Vegetated Wetland (BVW) |
| <input checked="" type="checkbox"/> Land Under Water Bodies and Waterways | <input type="checkbox"/> Land Subject to Flooding (BLSF/ILSF) |
| <input type="checkbox"/> Riverfront Area | <input type="checkbox"/> Isolated Vegetated Wetland |
| <input checked="" type="checkbox"/> Buffer Zone | <input type="checkbox"/> Estimated Habitats of Rare Wildlife |
| <input type="checkbox"/> Vernal Pool (Certified and/or Potential) | <input type="checkbox"/> Priority Habitats of Rare Species |

Delineated Resource Area Field Numbering Sequence [as depicted on the attached Resource Map]:

Bank/LUWW: A100-116, F600-602 (R&L)
BVW: B200-205, C300-309, D400-405, E500-503

Inland resource areas were delineated in accordance with applicable local, state and federal statutes, as detailed within the Resource Area Description attachment. This delineation does not constitute an official wetland boundary until such time as it is accepted and approved by local, state or federal regulatory agencies.

146 Hartford Road
Manchester, CT
06040
t 860.646.2469
800.286.2469
f 860.533.5143
www.fando.com

Connecticut
Massachusetts
Rhode Island
South Carolina

The wetlands delineation was conducted by:

Robin Casioppo
Wetland Scientist/Soil Scientist



Massachusetts Inland Resource Area Delineation Report
Resource Area Description

ATTACHMENTS

- Resource Area Description
- DEP Bordering Vegetated Wetland (310 CMR 10.55)
Delineation Field Forms
- NRCS Soil Map and Soil Report
- Resource Area Sketch Map
- MassGIS: OLIVER generated FEMA Map

Massachusetts Inland Resource Area Delineation Report Resource Area Description

Introduction

Fuss & O'Neill Inc. performed a wetland resource area field inspection and delineation at Foster Street ("Site") located off Taylor Street in Littleton, Massachusetts. The field inspection and delineation occurred on July 19, 2018. The purpose of the delineation was to locate the jurisdictional limits of areas regulated under the Wetlands Protection Act (M.G.L. c. 131 sec. 40) and associated Wetlands Protection Act Regulations (310 CMR 10).

Bank and Vegetated Bordering Wetlands (BVW) inland wetland resource areas were identified and delineated during the field investigation. Consecutively numbered flags were placed in the field to demarcate these resource area boundaries. Regulated Buffer Zone on the Property is measured horizontally from the boundaries of BVWs and intermittent watercourse Banks.

Maps retrieved from MassGIS were used to determine if specific regulated inland wetland resources have been mapped and/or documented on the Property. MassGIS maps do not depict Massachusetts Natural Heritage and Endangered Species Program (NHESP) Priority Habitats of Rare Species, Certified Vernal Pools, Potential Vernal Pools or Bordering Land Subject to Flooding (see additional details regarding FEMA Flood Zones below) on the Site. A detailed description of each regulated resource area present on the Site is provided below.

Resource Areas

Bank: Regulatory Framework and Delineation Methodology

Bank is defined under 310 CMR 10.54(2)(c) as "the portion of the land surface which normally abuts and confines a water body. It occurs between a water body and a vegetated bordering wetland and adjacent flood plain, or, in the absence of these, it occurs between a water body and an upland." Fuss & O'Neill Inc. performed a delineation of Bank within the area of interest using consecutively numbered flags placed in the field to demarcate the Bank of an intermittent stream, as well as the Bank of a small unnamed pond and its associated downstream channel.

Bank: Resource Description

Bank was located in the field by the first observable break in topography between water bodies and the adjacent BVW or upland. Water bodies on the property include the small unnamed pond and the associated downstream intermittent stream. The delineated Bank along the intermittent watercourses coincided with the Mean Annual High-Water Line (MAHWL)/bankfull, as defined under 310 CMR 10.58 (2)(a)(2). No evidence of riverine characteristics was noted along the pond bank during the inspection (i.e., no discernible direction of flow, no evidence of scour, etc.).

Land under Water Bodies and Waterways (LUWW)

Massachusetts Inland Resource Area Delineation Report Resource Area Description

LUWW is defined under 310 CMR 10.56 (2)(a) as “the land beneath any creek, river, stream, pond or lake. Said land may be composed of organic muck or peat, fine sediments, rocks or bedrock.” The boundary of LUWW is defined as the mean annual low water level (310 CMR 10.56 (2)(c)). LUWW was not specifically field delineated. For the intents and purposes of this resource area delineation, the delineated Banks of the pond and intermittent watercourse are analogous to the limits of LUWW.

Bordering Vegetated Wetlands (BVW): Regulatory Framework and Delineation Methodology

As stated in 310 CMR (2)(a), “Bordering Vegetated Wetlands are freshwater wetlands which border on creeks, rivers, streams, ponds and lakes. The types of freshwater wetlands are wet meadows, marshes, swamps and bogs. Bordering Vegetated Wetlands are areas where the soils are saturated and/or inundated such that they support a predominance of wetland indicator plants. The ground and surface water regime and the vegetation community which occur in each type of freshwater wetland are specified in M.G.L. c 131 sec. 40.”

Fuss & O'Neill Inc. inspected the Site for bordering vegetated wetlands in accordance with methodology provided in the Massachusetts DEP handbook, Delineating Bordering Vegetated Wetlands under the Massachusetts Wetlands Protection Act, (March 1995), the 1987 Corps of Engineers Wetlands Delineation Manual, and the Regional Supplement to the Corps of Engineers Wetlands Delineation Manual: Northcentral and Northeast Region (Version 2.0. January 2012). Data regarding vegetation, soils, and hydrology was gathered to complete the required MassDEP BVW delineation field forms. Wetlands are categorized in accordance with Classification of Wetlands and Deepwater Habitats of the United States (Cowardin et.al. 1979).

Hydric soil determinations were made in accordance with Field Indicators for Identifying Hydric Soils in New England (NEIWPCC, 2018). The Wetland Indicator Status for plant species was ascertained using the USACE Northcentral and Northeast 2014 Regional Wetland Plant List (Lichvar et al., 2014).

BVW: Resource Area Description

Vegetation

Six (6) BVWs were identified on the Site. Four of the six BVWs on the Site are classified as palustrine forested wetlands. Common vegetation identified within forested BVWs includes [common name/scientific name (indicator status)]: Red Maple/*Acer rubrum* (FAC), highbush blueberry/*Vaccinium corymbosum* (FACW), bittersweet/*Celastrus orbiculatus* (UPL), poison ivy/*Toxicodendron radicans* (FAC), silky dogwood/*Swida amomum* (FACW), gray dogwood/*Swida racemosa* (FAC), glossy false buckthorn/*Frangula alnus* (FAC), arrowwood/*Viburnum dentatum* (FACW), elderberry/*Sambucus nigra* (FACW),

Massachusetts Inland Resource Area Delineation Report Resource Area Description

spicebush/*Lindera benzoin* (FACW), sweet pepperbush/*Clethra alnifolia* (FAC), multiflora rose/*Rosa multiflora* (FACU), cinnamon fern/*Osmundastrum cinnamomeum* (FACW), sensitive fern/*Onoclea sensibilis* (FACW), Jack-in-the-pulpit/*Arisaema triphyllum* (FAC), skunk-cabbage/*Symplocarpus foetidus* (OBL), false hellebore/*Veratrum viride* (FACW), and jewelweed/*Impatiens capensis* (FACW).

The remaining two BVWs are classified as palustrine emergent wet meadows. Common vegetation identified within emergent wet meadow BVWs includes [common name/scientific name (indicator status)]: arrowwood, silky dogwood, poison ivy, sensitive fern, cinnamon fern, jewelweed, royal fern/*Osmunda regalis* (OBL), soft rush/*Juncus effusus* (OBL), tall meadow rue/*Thalictrum pubescens* (FACW), and blue flag iris/*Iris versicolor* (OBL).

Hydrology

The BVWs identified on the southern portion of the site are hydrologically connected to the on-site pond and another small pond adjacent to the Site. The intermittent stream associated with the on-site pond flows north from the pond and is conveyed through a culvert beneath Foster Street. The stream leads to a wetland system north of Foster Street. Two BVWs on the central portion of the site are hydrologically connected to an intermittent stream that runs parallel to Route 2. The remaining two BVWs are hydrologically connected to one another via a culvert and are supported by an intermittent stream that enters the site from the east. Evidence of surface water and soil saturation include: direct observation of surface water, water stained leaves and tree trunks, sediment deposition, free water in test holes, saturated soils, and hydric soils.

Soils

The Natural Resource Conservation Service (NRCS) mapped soil types on the Property include: Canton, Paxton, Urban Land, Udorthents, Swansea muck, Charlton, and Hollis series. Detailed information regarding each of these soil series is included within the NRCS Soil Map and Soil Report attachment. Results of the detailed field analyses of soils on the Property were generally consistent with the published NRCS soil mapping.

Buffer Zone

Buffer Zone is defined in 310 CMR 10.04 as "that area of land extending 100 feet horizontally outward from the boundary of any area specified in 310 CMR 10.02(1)(a)." Buffer Zone within the area of interest is associated with BVW and Bank. The buffer zone on the Property contains upland forested areas, residential and commercial properties, and various municipal roads. Common vegetation within the Buffer Zone includes: beech/*Fagus grandifolia* (FACU), red maple, red oak/*Quercus rubra* (FACU), eastern white pine/*Pinus strobus* (FACU), gray birch/*Betula populifolia* (FAC), Virginia creeper/*Parthenocissus quinquefolia* (FACU), poison ivy, grape/*Vitis labrusca* (FACU), bittersweet, multiflora rose, sassafras/*Sassafras albidum* (FACU),

Massachusetts Inland Resource Area Delineation Report Resource Area Description

staghorn sumac/*Rhus hirta* (UPL), brambles/*Rubus* spp., greenbriar/*Smilax rotundifolia* (FAC), tatarian honeysuckle/*Lonicera tatarica* (FACU), whorled bedstraw/*Galium mollugo* (UPL), sensitive fern, and Canada mayflower/*Maianthemum canadense* (FACU).

FEMA Flood Zones

The MassGIS National Flood Hazard Layer provided by the Federal Emergency Management Agency (FEMA) does not depict areas of potential flooding on the Property. Bordering Land Subject to Flooding (BLSF) is not mapped for the Site: BLSF is defined in 310 CMR 10.57 (2)(a)(1) as "an area with low, flat topography adjacent to and inundated by flood waters rising from creeks, rivers, streams, ponds or lakes. It extends from the banks of these waterways and water bodies; where a bordering vegetated wetland occurs, it extends from said wetlands."



DEP Bordering Vegetated Wetland (310 CMR 10.55) Delineation Field Forms

MassDEP Bordering Vegetated Wetland (310 CMR 10.55) Delineation Field Data Form

Applicant: Town of Littleton Prepared by: Robin Casioppo, Fuss & O'Neill, Inc. Project location: Littleton, MA DEP File #: _____

Check all that apply:

- ☐ Vegetation alone presumed adequate to delineate BVW boundary: fill out Section I only
- ☐ Vegetation and other indicators of hydrology used to delineate BVW boundary: fill out Sections I and II
- ☐ Method other than dominance test used (attach additional information)

Section I.

Vegetation	Observation Plot Number: B1W1		Transect Number: 1	Date of Delineation: 7/19/18
A. Sample Layer & Plant Species (by common/scientific name)	B. Percent Cover (or basal Area)	C. Percent Dominance	D. Dominant Plant (yes or no)	E. Wetland Indicator Category*
<u>Woody Vines</u>				
Virginia Creeper/ Parthenocissus quinquefolia	2	100	yes	FACU
<u>Shrubs</u>				
Gray dogwood/Swida racemosa*	80	100	yes	FAC
<u>Herbs</u>				
Sensitive fern/Onoclea sensibilis*	10	100	yes	FACW

* Use an asterisk to mark wetland indicator plants: plant species listed in the Wetlands Protection Act (MGL c.131, s.40); plants in the genus Sphagnum; plants listed as FAC, FAC+, FACW-, FACW, FACW+, or OBL; or plants with physiological or morphological adaptations. If any plants are identified as wetland indicator plants due to physiological or morphological adaptations, describe the adaptation next to the asterisk.

Vegetation conclusion:

Number of dominant wetland indicator plants: 2

Number of dominant non-wetland indicator plants: 1

Is the number of dominant wetland plants equal to or greater than the number of dominant non-wetland plants? **yes** no

If vegetation alone is presumed adequate to delineate the BVW boundary, submit this form with the Request for Determination of Applicability or Notice of Intent

MassDEP Bordering Vegetated Wetland (310 CMR 10.55) Delineation Field Data Form

Applicant: Town of Littleton Prepared by: Robin Casioppo, Fuss & O'Neill, Inc. Project location: Littleton, MA DEP File #: _____

Check all that apply:

- ☐ Vegetation alone presumed adequate to delineate BVW boundary: fill out Section I only
- ☐ Vegetation and other indicators of hydrology used to delineate BVW boundary: fill out Sections I and II
- ☐ Method other than dominance test used (attach additional information)

Section I.

Vegetation	Observation Plot Number: D1W1		Transect Number: 1	Date of Delineation: 7/19/2018
A. Sample Layer & Plant Species (by common/scientific name)	B. Percent Cover (or basal Area)	C. Percent Dominance	D. Dominant Plant (yes or no)	E. Wetland Indicator Category*
<u>Trees</u>				
American elm/Ulmus Americana*	15	43	yes	FACW
Red maple/Acer rubrum*	20	57	yes	FAC
<u>Shrubs</u>				
Gray dogwood/Swida racemosa*	5	100	yes	FAC
<u>Herbs</u>				
Sensitive fern/Onoclea sensibilis*	25	33	yes	FACW
Jewelweed/Impatiens capensis*	50	67	yes	FACW
<u>Woody vines</u>				
Virginia creeper/ Parthenocissus quinquefolia	5	100	yes	FACU

* Use an asterisk to mark wetland indicator plants: plant species listed in the Wetlands Protection Act (MGL c. 131, s.40); plants in the genus Sphagnum; plants listed as FAC, FAC+, FACW-, FACW, FACW+, or OBL; or plants with physiological or morphological adaptations. If any plants are identified as wetland indicator plants due to physiological or morphological adaptations, describe the adaptation next to the asterisk.

Vegetation conclusion:

Number of dominant wetland indicator plants: 5

Number of dominant non-wetland indicator plants: 1

Is the number of dominant wetland plants equal to or greater than the number of dominant non-wetland plants? **yes** no

If vegetation alone is presumed adequate to delineate the BVW boundary, submit this form with the Request for Determination of Applicability or Notice of Intent

MassDEP Bordering Vegetated Wetland (310 CMR 10.55) Delineation Field Data Form

Applicant: Town of Littleton Prepared by: Robin Casioppo, Fuss & O'Neill, Inc. Project location: Littleton, MA DEP File #: _____

Check all that apply:

- ☐ Vegetation alone presumed adequate to delineate BVW boundary: fill out Section I only
- ☐ Vegetation and other indicators of hydrology used to delineate BVW boundary: fill out Sections I and II
- ☐ Method other than dominance test used (attach additional information)

Section I.

Vegetation	Observation Plot Number: E1W1		Transect Number: 1	Date of Delineation: 7/19/2018
A. Sample Layer & Plant Species (by common/scientific name)	B. Percent Cover (or basal Area)	C. Percent Dominance	D. Dominant Plant (yes or no)	E. Wetland Indicator Category*
<u>Shrubs</u>				
Gray dogwood/Swida racemosa*	90	100	yes	FAC
<u>Herbs</u>				
Jewelweed/Impatiens capensis*	15	100	yes	FACW
<u>Woody vines</u>				
Virginia creeper/ Parthenocissus quinquefolia	5	100	yes	FACU

* Use an asterisk to mark wetland indicator plants: plant species listed in the Wetlands Protection Act (MGL c. 131, s.40); plants in the genus Sphagnum; plants listed as FAC, FAC+, FACW-, FACW, FACW+, or OBL; or plants with physiological or morphological adaptations. If any plants are identified as wetland indicator plants due to physiological or morphological adaptations, describe the adaptation next to the asterisk.

Vegetation conclusion:

Number of dominant wetland indicator plants: 2

Number of dominant non-wetland indicator plants: 1

Is the number of dominant wetland plants equal to or greater than the number of dominant non-wetland plants? **yes** no

If vegetation alone is presumed adequate to delineate the BVW boundary, submit this form with the Request for Determination of Applicability or Notice of Intent

MassDEP Bordering Vegetated Wetland (310 CMR 10.55) Delineation Field Data Form

Applicant: Town of Littleton Prepared by: Robin Casioppo, Fuss & O'Neill, Inc. Project location: Littleton, MA DEP File #: _____

Check all that apply:

- ☐ Vegetation alone presumed adequate to delineate BVW boundary: fill out Section I only
- ☐ Vegetation and other indicators of hydrology used to delineate BVW boundary: fill out Sections I and II
- ☐ Method other than dominance test used (attach additional information)

Section I.

Vegetation	Observation Plot Number: G1W1		Transect Number: 1	Date of Delineation: 7/19/2018
A. Sample Layer & Plant Species (by common/scientific name)	B. Percent Cover (or basal Area)	C. Percent Dominance	D. Dominant Plant (yes or no)	E. Wetland Indicator Category*
<u>Trees</u>				
Red maple/Acer rubrum*	15	79	yes	FAC
Eastern cottonwood/ Populus deltoides*	2	10.5	no	FACW
Ash species/Fraxinus sp.	2	10.5	no	UNK
<u>Herbs</u>				
Skunk cabbage/ Symplocarpus foetidus*	25	48	yes	OBL
Royal fern/Osmunda regalis	5	10	no	OBL
Cinnamon fern/ Osmundastrum cinnamomeum	5	10	no	FACW
Purple loosestrife/Lythrum salicaria*	2	3	no	OBL
Smooth goldenrod/Solidago gigantea*	5	10	no	FACW
Fowl bluegrass/Poa palustris*	10	19	no	FACW

* Use an asterisk to mark wetland indicator plants: plant species listed in the Wetlands Protection Act (MGL c.131, s.40); plants in the genus Sphagnum; plants listed as FAC, FAC+, FACW-, FACW, FACW+, or OBL; or plants with physiological or morphological adaptations. If any plants are identified as wetland indicator plants due to physiological or morphological adaptations, describe the adaptation next to the asterisk.

Vegetation conclusion:

Number of dominant wetland indicator plants: 2

Number of dominant non-wetland indicator plants: 0

Is the number of dominant wetland plants equal to or greater than the number of dominant non-wetland plants? **yes** no

If vegetation alone is presumed adequate to delineate the BVW boundary, submit this form with the Request for Determination of Applicability or Notice of Intent

MassDEP Bordering Vegetated Wetland (310 CMR 10.55) Delineation Field Data Form

Applicant: Town of Littleton Prepared by: Robin Casioppo, Fuss & O'Neill, Inc. Project location: Littleton, MA DEP File #: _____

Check all that apply:

- ☐ Vegetation alone presumed adequate to delineate BVW boundary: fill out Section I only
- ☐ Vegetation and other indicators of hydrology used to delineate BVW boundary: fill out Sections I and II
- ☐ Method other than dominance test used (attach additional information)

Section I.

Vegetation	Observation Plot Number: J1W1		Transect Number: 1	Date of Delineation: 7/19/2018
A. Sample Layer & Plant Species (by common/scientific name)	B. Percent Cover (or basal Area)	C. Percent Dominance	D. Dominant Plant (yes or no)	E. Wetland Indicator Category*

Trees

Red maple/Acer rubrum*	50	83	yes	FAC
American elm/Ulmus americana*	10	17	no	FACW

Shrubs

Gray dogwood/Swida amomum*	5	50	yes	FAC
Winterberry holly/Ilex verticillata*	5	50	yes	FACW

Woody vines

Poison ivy/Toxicodendron radicans*	50	100	yes	FAC
------------------------------------	----	-----	-----	-----

Herbs

Skunk cabbage/ Symplocarpus foetidus*	7	47	yes	OBL
Royal fern/Osmunda regalis*	3	20	yes	OBL
Sensitive fern/Onoclea sensibilis*	3	20	yes	OBL
Cinnamon fern/ Osmundastrum cinnamomeum*	2	13	no	FACW

* Use an asterisk to mark wetland indicator plants: plant species listed in the Wetlands Protection Act (MGL c.131, s.40); plants in the genus Sphagnum; plants listed as FAC, FAC+, FACW-, FACW, FACW+, or OBL; or plants with physiological or morphological adaptations. If any plants are identified as wetland indicator plants due to physiological or morphological adaptations, describe the adaptation next to the asterisk.

Vegetation conclusion:

Number of dominant wetland indicator plants: 7

Number of dominant non-wetland indicator plants: 0

Is the number of dominant wetland plants equal to or greater than the number of dominant non-wetland plants? **yes** no

If vegetation alone is presumed adequate to delineate the BVW boundary, submit this form with the Request for Determination of Applicability or Notice of Intent

MassDEP Bordering Vegetated Wetland (310 CMR 10.55) Delineation Field Data Form

Applicant: Town of Littleton Prepared by: Robin Casioppo, Fuss & O'Neill, Inc. Project location: Littleton, MA DEP File #: _____

Check all that apply:

- ☐ Vegetation alone presumed adequate to delineate BVW boundary: fill out Section I only
- ☐ Vegetation and other indicators of hydrology used to delineate BVW boundary: fill out Sections I and II
- ☐ Method other than dominance test used (attach additional information)

Section I.

Vegetation	Observation Plot Number: L1W1		Transect Number: 1	Date of Delineation: 7/19/2018
A. Sample Layer & Plant Species (by common/scientific name)	B. Percent Cover (or basal Area)	C. Percent Dominance	D. Dominant Plant (yes or no)	E. Wetland Indicator Category*

Herbs

Purple loosestrife/ Lythrum salicaria*	25	28	yes	OBL
Bur-reed species/Sparganium sp.*	20	22	yes	OBL
Wrinkle-leaf goldenrod/ Solidago rugosa*	20	22	yes	FAC
Wool grass/Scirpus cyperinus*	5	6	no	OBL
Reed canary grass/ Phalaris arundinacea*	10	11	no	FACW
Joe-pye-weed species/ Eutrochium sp.	10	11	no	UNK

* Use an asterisk to mark wetland indicator plants: plant species listed in the Wetlands Protection Act (MGL c.131, s.40); plants in the genus Sphagnum; plants listed as FAC, FAC+, FACW-, FACW, FACW+, or OBL; or plants with physiological or morphological adaptations. If any plants are identified as wetland indicator plants due to physiological or morphological adaptations, describe the adaptation next to the asterisk.

Vegetation conclusion:

Number of dominant wetland indicator plants: 3

Number of dominant non-wetland indicator plants: 0


Is the number of dominant wetland plants equal to or greater than the number of dominant non-wetland plants? **yes** no

If vegetation alone is presumed adequate to delineate the BVW boundary, submit this form with the Request for Determination of Applicability or Notice of Intent



NRCS Soil Map and Soil Report

Soil Map—Middlesex County, Massachusetts
(Foster Street, Littleton, MA)

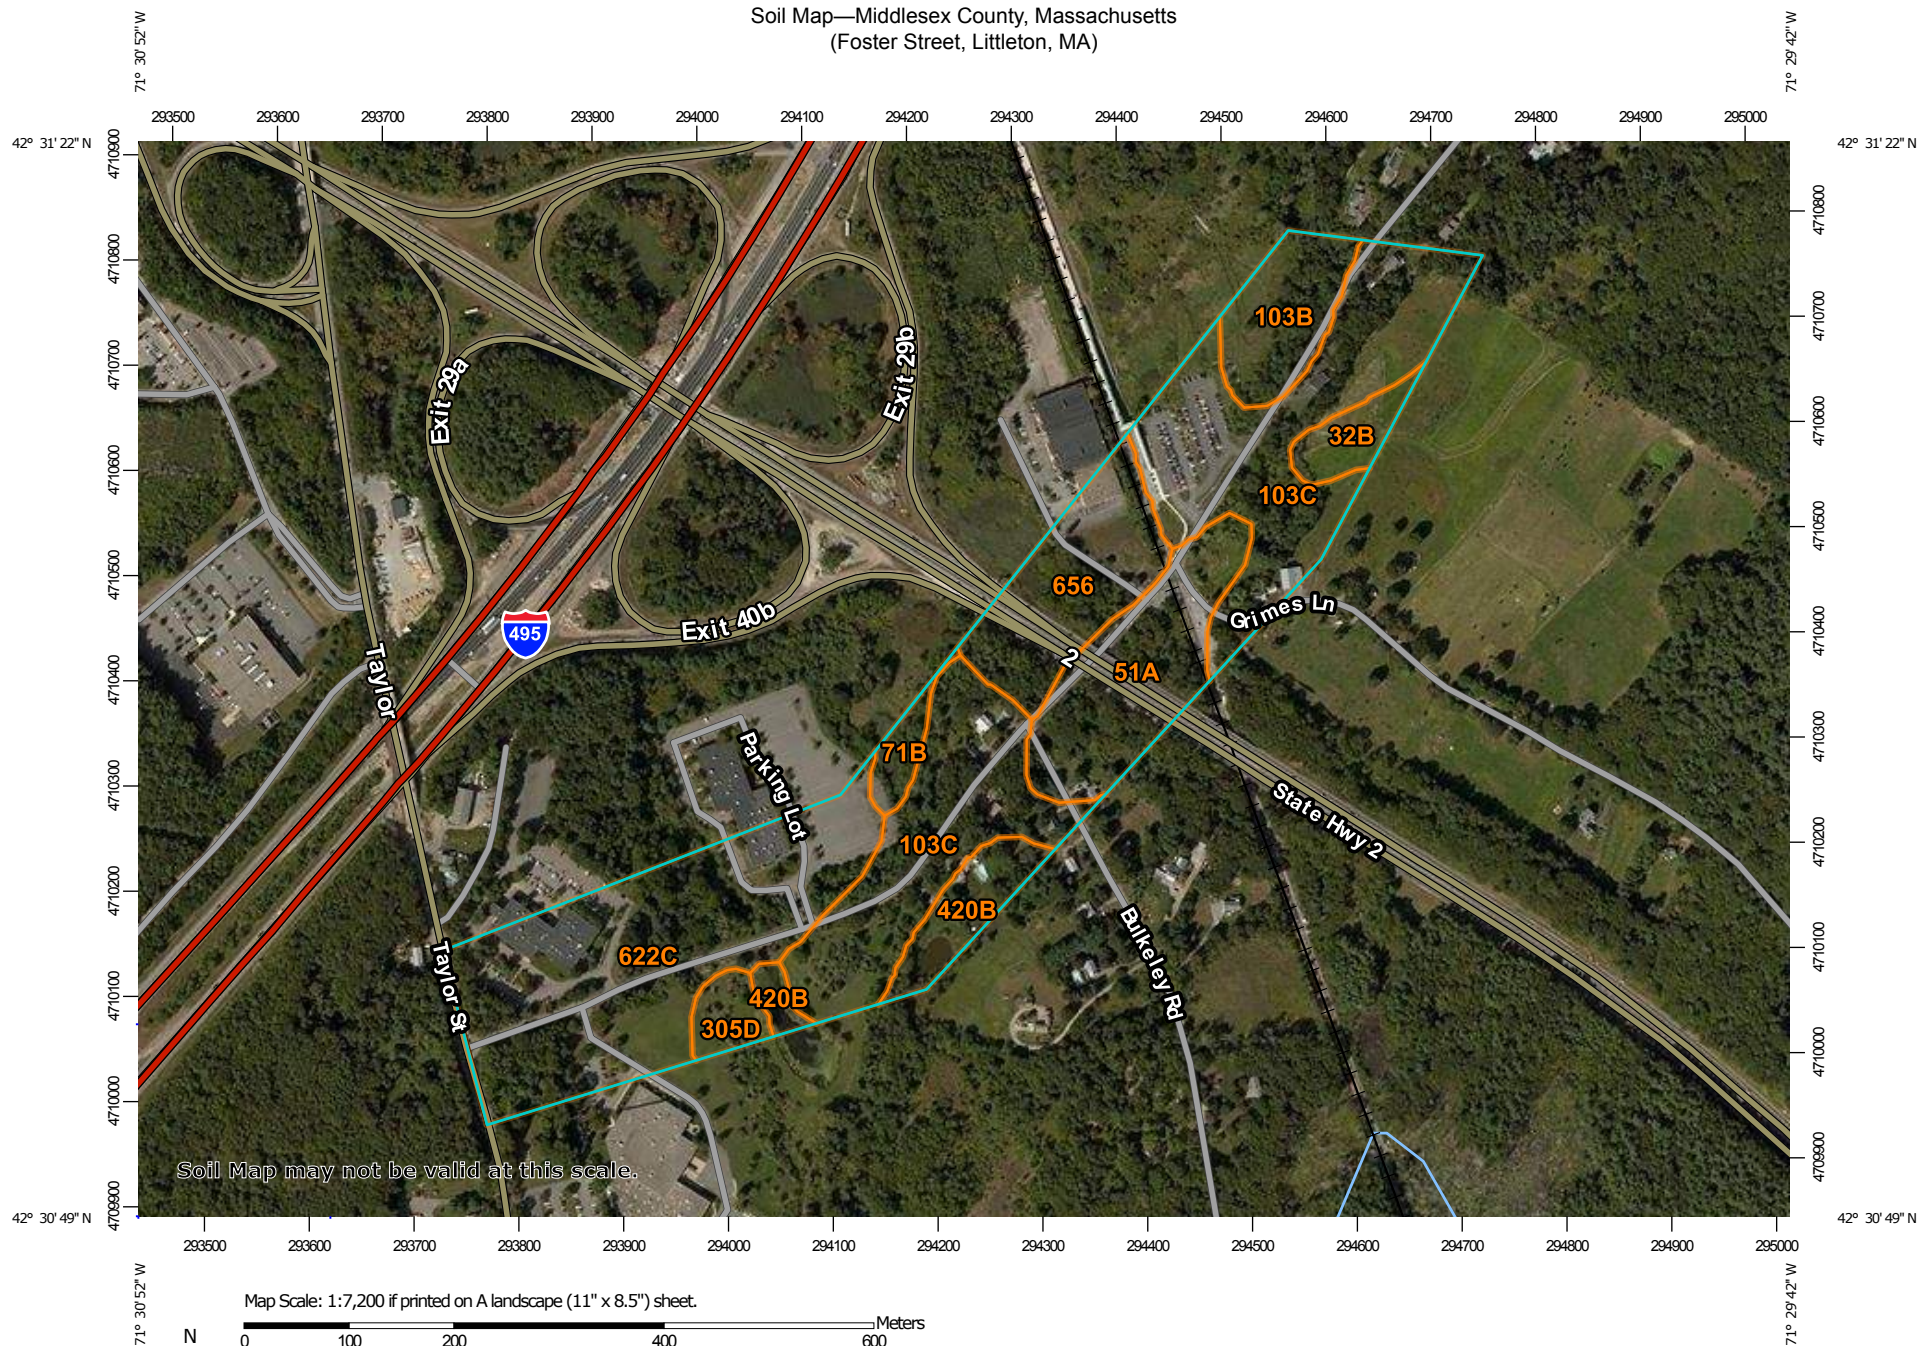




MAP LEGEND




















Area of Interest (AOI)







Area of Interest (AOI)

Soils


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-  Soil Map Unit Lines
-  Soil Map Unit Points

Special Point Features






-  Blowout
-  Borrow Pit
-  Clay Spot
-  Closed Depression
-  Gravel Pit
-  Gravelly Spot
-  Landfill
-  Lava Flow
-  Marsh or swamp
-  Mine or Quarry
-  Miscellaneous Water
-  Perennial Water
-  Rock Outcrop
-  Saline Spot
-  Sandy Spot
-  Severely Eroded Spot
-  Sinkhole
-  Slide or Slip
-  Sodic Spot

-  Spoil Area
-  Stony Spot
-  Very Stony Spot
-  Wet Spot
-  Other
-  Special Line Features

Water Features

-  Streams and Canals

Transportation

-  Rails
-  Interstate Highways
-  US Routes
-  Major Roads
-  Local Roads

Background

-  Aerial Photography

MAP INFORMATION

The soil surveys that comprise your AOI were mapped at 1:25,000.

Warning: Soil Map may not be valid at this scale.

Enlargement of maps beyond the scale of mapping can cause misunderstanding of the detail of mapping and accuracy of soil line placement. The maps do not show the small areas of contrasting soils that could have been shown at a more detailed scale.

Please rely on the bar scale on each map sheet for map measurements.

Source of Map: Natural Resources Conservation Service
Web Soil Survey URL:
Coordinate System: Web Mercator (EPSG:3857)

Maps from the Web Soil Survey are based on the Web Mercator projection, which preserves direction and shape but distorts distance and area. A projection that preserves area, such as the Albers equal-area conic projection, should be used if more accurate calculations of distance or area are required.

This product is generated from the USDA-NRCS certified data as of the version date(s) listed below.

Soil Survey Area: Middlesex County, Massachusetts
Survey Area Data: Version 17, Oct 6, 2017

Soil map units are labeled (as space allows) for map scales 1:50,000 or larger.

Date(s) aerial images were photographed: Sep 12, 2014—Sep 28, 2014

The orthophoto or other base map on which the soil lines were compiled and digitized probably differs from the background imagery displayed on these maps. As a result, some minor shifting of map unit boundaries may be evident.

Map Unit Legend


Map Unit Symbol	Map Unit Name	Acres in AOI	Percent of AOI
32B	Wareham loamy fine sand, 0 to 5 percent slopes	1.4	2.5%
51A	Swansea muck, 0 to 1 percent slopes	6.6	11.4%
71B	Ridgebury fine sandy loam, 3 to 8 percent slopes, extremely stony	0.9	1.6%
103B	Charlton-Hollis-Rock outcrop complex, 3 to 8 percent slopes	3.5	6.0%
103C	Charlton-Hollis-Rock outcrop complex, 8 to 15 percent slopes	20.4	35.2%
305D	Paxton fine sandy loam, 15 to 25 percent slopes	1.2	2.0%
420B	Canton fine sandy loam, 3 to 8 percent slopes	2.7	4.7%
622C	Paxton-Urban land complex, 3 to 15 percent slopes	15.4	26.6%
656	Udorthents-Urban land complex	5.8	10.1%
Totals for Area of Interest		58.1	100.0%



Wetland Sketch Map

Delineated by: Robin Casio, Fuss & O'Neill, Inc. on July 19, 2018


Foster Street, Littleton, MA

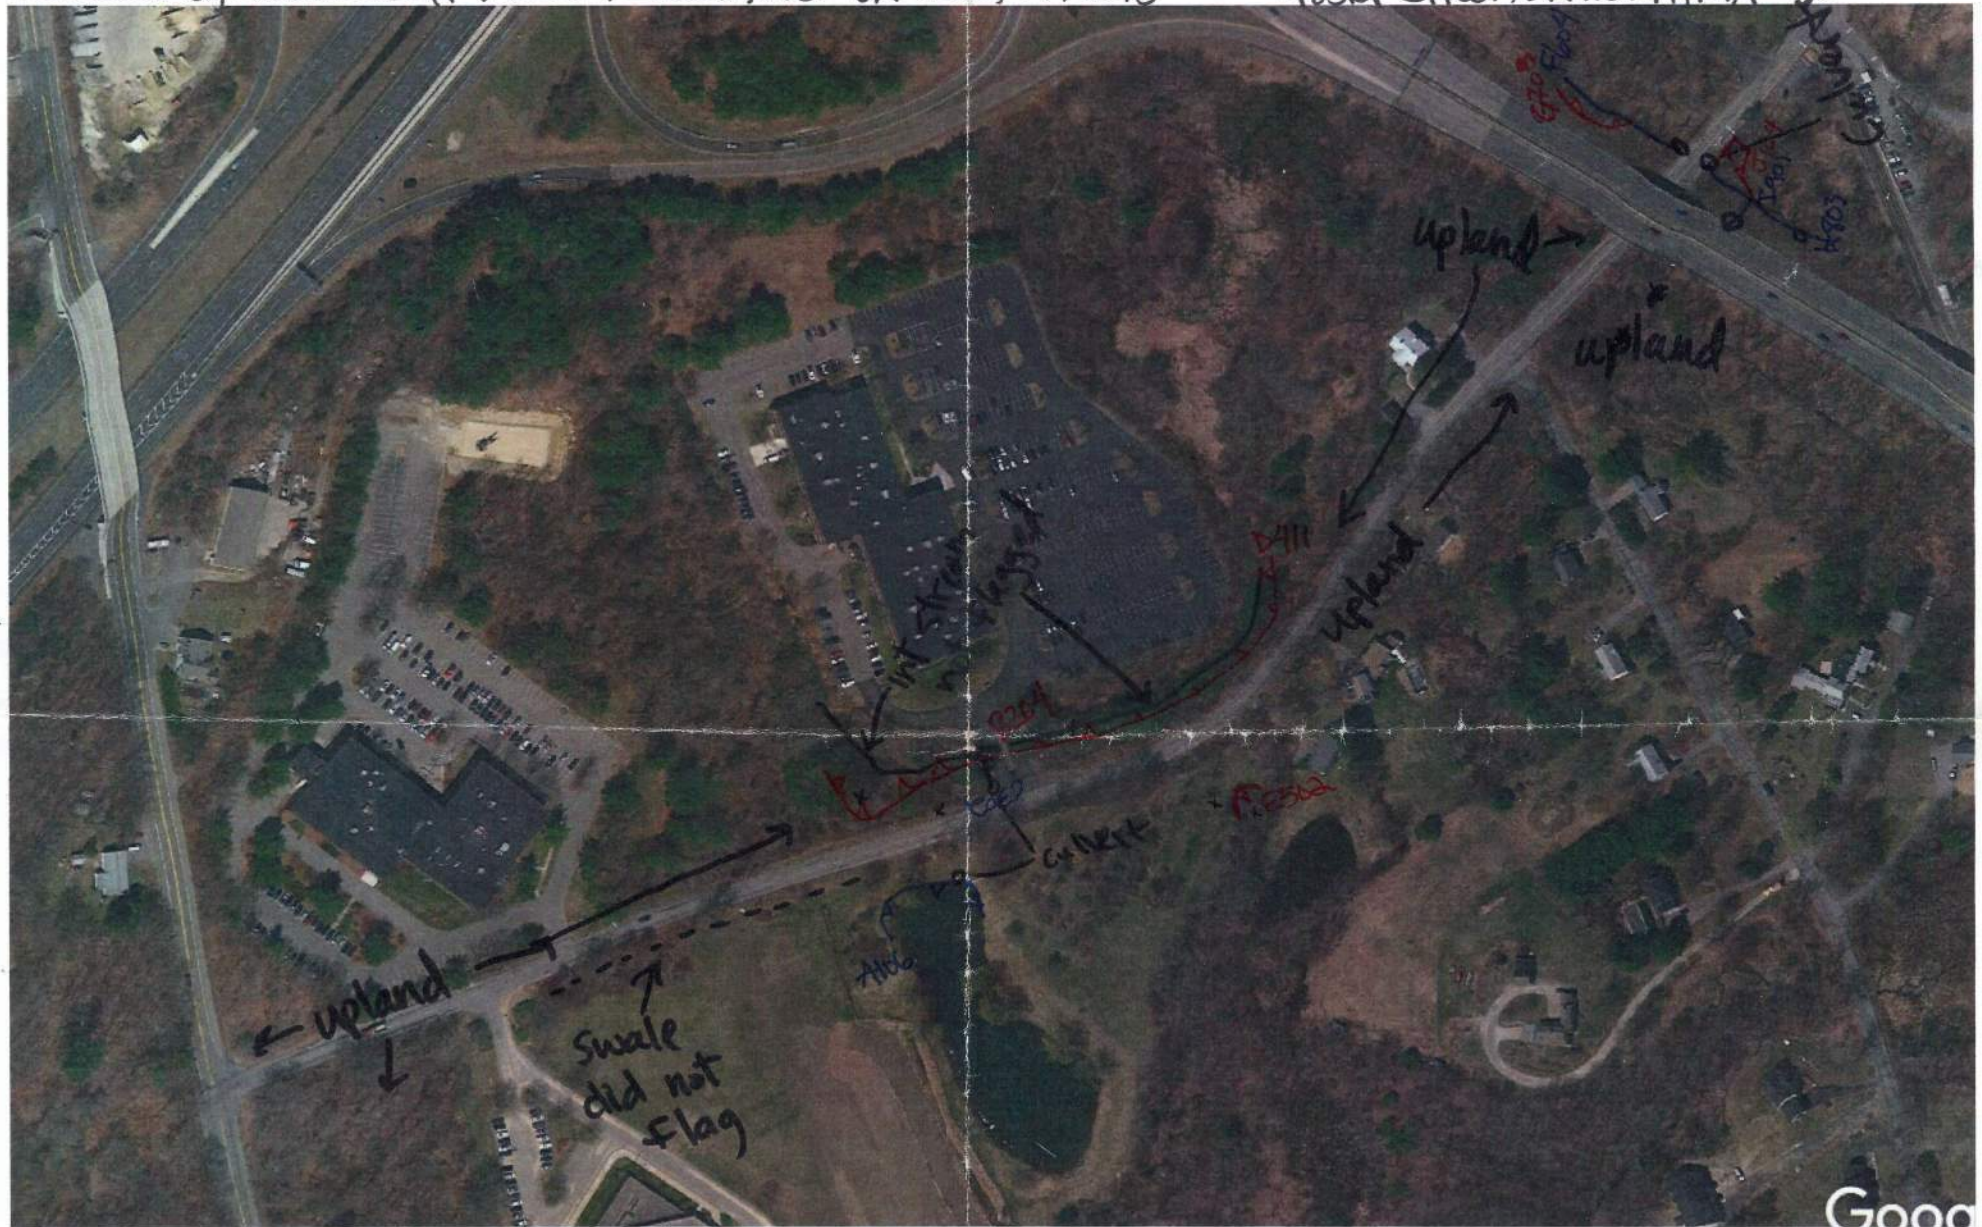

A100-106, B200-204, C300-302, D400-411, E500-502, F600-604, G700-703, H800-803, I900-901, J100-104

Red line = pink flags
Blue line = blue flags

Wetland Sketch

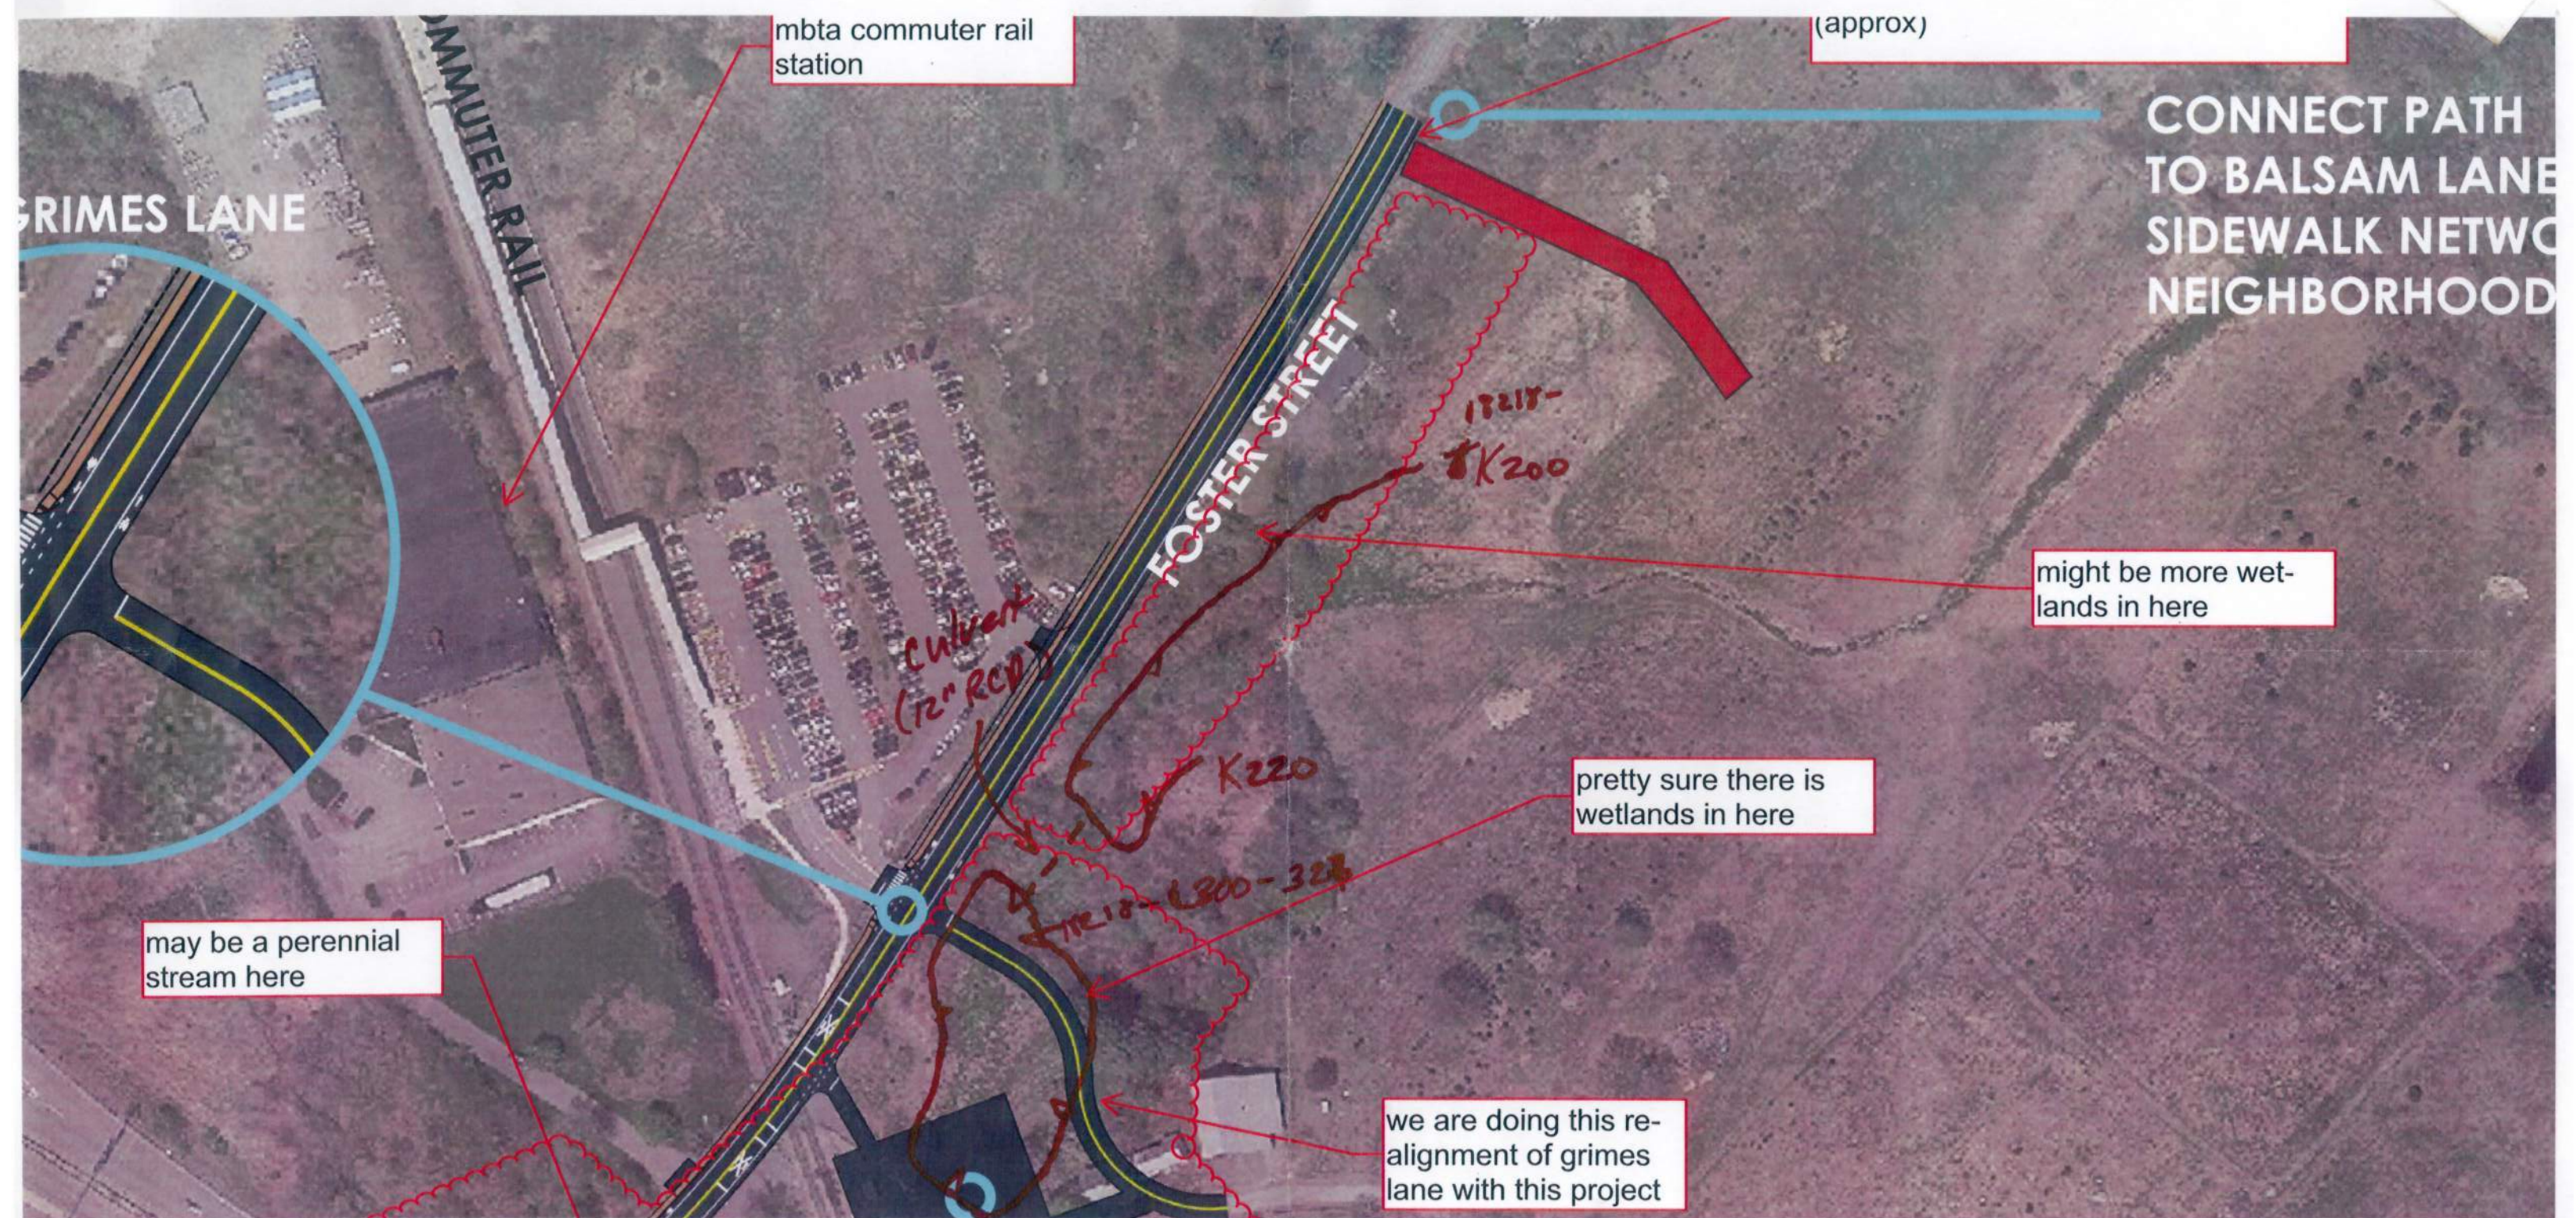

Josh Wilson, PWS
Wetland sketch
8/7/18

Littleton, MA

Flags 18218-K200-K220, L300-L326

2017004 AZI

8/7/18

Foster St. Reconstruction

Littleton, MA

Resource delimitation

0700 Lv home

0915 Arr @ site

1300 Lv. site

1510 Arr @ home

(70)

12218-

K200-K220 (21)

L300-L327 (28)

~~0-6~~ L325 wet

0-6 10YR 3/1 fsl

6-12 10YR 5/2 fsl

75YR 4/6 20m-c

Lophium sel. 25

Sparganium 20

S. rugosa 20

Cyp (unl. grass) 5

RC grass 10

Sp. JPN 10

VP

0-8 10YR 3/2 fsl

8-18 10YR 4/4

2.5Y 5/4 sl

18-24 10YR 6/6 sl

P. oblong 70

A. ach. 10

Lonicera m. 10

C. commun 10


PT 30

growing 20

C. orbic 10

(70)

MassGIS Maps

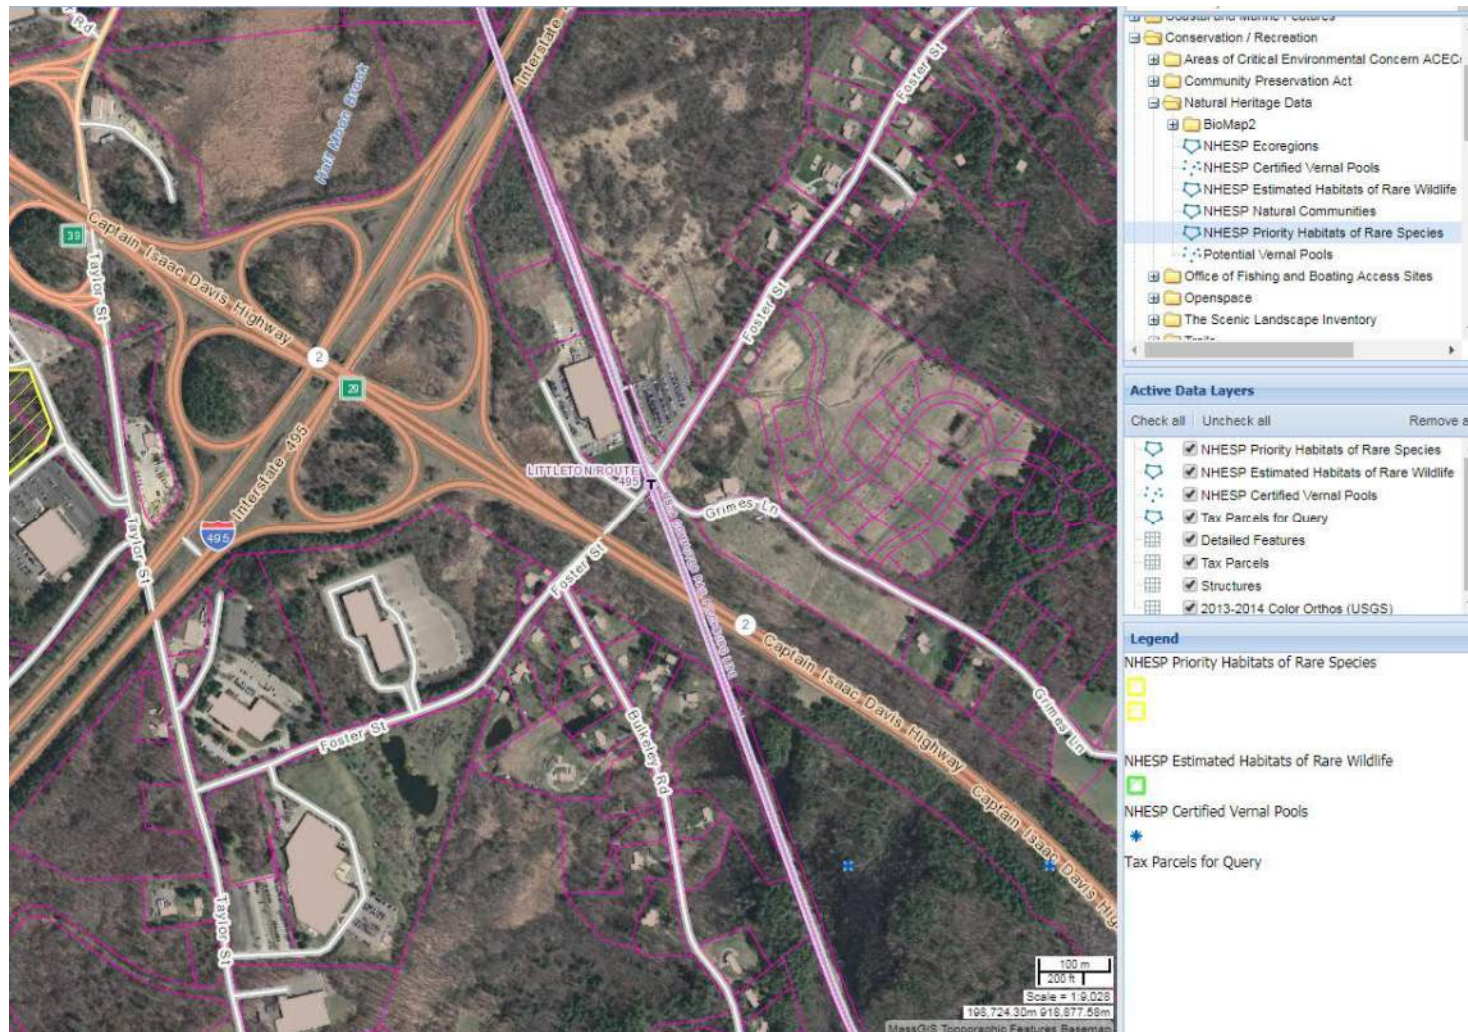

OLIVER MassGIS
Foster Street, Littleton, MA
20170044.A21

Appendix E

Site Photos

RECONSTRUCTION OF FOSTER ST
Existing Site Condition Photos
MassDOT Proj. #609054



TOP: Looking east on Taylor St toward the intersection with Foster St from STA 0+00.
BOTTOM LEFT: Looking west on Foster St at the intersection with Taylor St from STA 1+00.
BOTTOM RIGHT: Looking east on Foster St from STA 1+00.





TOP LEFT: Looking west on Foster St from STA 4+00.
TOP RIGHT: Looking east on Foster St from STA 4+00. The entrance to the office park at 305 Foster St is visible.
BOTTOM: Looking south from Foster St at the entrance to the office park at 300 Foster St STA 4+00. Employees walking along Foster St during lunch break are visible.

CULVERT CROSSING UNDERNEATH FOSTER ST AT CENTERLINE STA 10+30

TOP LEFT: Looking south at the culvert outlet on the north side of Foster St at STA 10+40 LT 40.
TOP RIGHT: Looking at the Culvert outlet headwall at the north side of Foster St STA 10+40 LT 40.
BOTTOM LEFT: Looking south into the culvert outlet at STA 10+40 LT 40. The culvert inlet is located at STA 10+16 RT 20 near an open body of water on the south side of Foster St. The length of culvert is 60ft.





TOP LEFT: Looking west from STA 10+80 on Foster St.
 TOP RIGHT: Looking south from STA 10+20 toward a body of open water on the south side of Foster St. The body of water is unnamed on all available maps.
 BOTTOM LEFT: Looking east from STA 10+20 on Foster St. The driveway to the office park at 295 Foster St is visible.
 BOTTOM RIGHT: Looking south from STA 10+00 toward the body of water on the south side of Foster St.



LEFT: Looking west on Foster St at STA 14+25.
RIGHT: Looking east on Foster St at STA 14+25.

RECONSTRUCTION OF FOSTER ST
Existing Site Condition Photos
 MassDOT Proj. #609054



LEGEND:

TOP LEFT: Looking west on Foster St from STA 17+00.

TOP RIGHT: Looking east on Foster St from STA 14+00 showing catch basins.

BOTTOM LEFT: Looking west on Foster St from STA 21+00 at the historic South School.

BOTTOM RIGHT: Looking east on Foster St at STA 19+10 at the historic South School.



ROUTE 2 OVERPASS BRIDGE OVER FOSTER ST AT STA 24+55



TOP LEFT: Looking east on Foster St at STA 23+00 at Route 2 overpass.
TOP RIGHT: Looking west on Foster St at STA 23+00.
BOTTOM LEFT: Looking east on Foster St at STA 24+50 at rail crossing approach.
BOTTOM RIGHT: Looking west on Foster St and Route 2 overpass at STA 26+50.

CULVERT CROSSING AT FOSTER ST STA 24+80



LEGEND:

TOP LEFT- Looking north on Foster St at bollards demarcating the culvert location at STA 24+80.

TOP RIGHT- Looking south on Foster St at bollards demarcating the culvert location at STA 24+80.

BOTTOM LEFT- Culvert inlet at the south side of Foster St at STA 24+80 RT 21.

BOTTOM MIDDLE- Culvert outlet and crushed stone lined spillway on the north side of Foster St at STA 24+80 LT 41. The culvert is 63ft in length.

BOTTOM RIGHT- Looking north downstream of the culvert outlet on the north side of Foster St at STA 24+80 LT 41.

RAIL CROSSING AT FOSTER ST AND GRIMES LN STA 27+40



LEGEND:

- TOP- Looking northeast at STA 27+40 the commuter rail lot and station are visible.
- LEFT MIDDLE- Looking west at STA 27+60 the rail crossing and Route 2 overpass are visible.
- RIGHT MIDDLE- Looking east at STA 27+00 the rail crossing is visible.
- BOTTOM- Looking south at STA 27+40 the Grimes Lane intersection is visible.



LEFT- Looking west from STA 29+00 the overflow commuter parking on the north side of Foster St is visible.
RIGHT- Looking east from STA 29+00 the overflow commuter parking on the north side of Foster St is visible.



LEGEND:

TOP LEFT- Looking west on Foster St from STA 39+00 at the intersection with Balsam Ln.
TOP RIGHT- Looking east on Foster St from STA 39+00 viewing the eastern project limit.
BOTTOM- Looking south at the Balsam Ln retaining wall at from STA 37+75.

Appendix F

Littleton Waiver Request Form



Littleton Conservation Commission

37 Shattuck Street / Room 303

Phone: 978 540-2428

Fax: 978 952-2321

Littleton Wetland Protection Regulations

Waiver Request Requirement Information (Section 1.4)

Date: 5/19/2023 Applicant/Owner: Town of Littleton DPW

Map/Lot: 1425 Project Address: Roadway; 238-305 Foster St & 221-241 Taylor St

In order request a waiver, the following provides a guidance for required information (attach additional text, plans, photos or graphics if needed):

Project purpose and need: The Project will reconstruct Foster Street between Taylor Street and Balsam Lane. A new 10 ft separated shared-use path will be furnished throughout the project while the road surface on Foster St will be narrowed slightly. The project addresses vehicular, pedestrian, and bicycle safety. The project proposes an improved storm water drainage system to the maximum extent practical. The project will also include the replacement of a 10" water main underneath Foster Street in an effort to 'dig once' and reduce disturbance to the corridor.

What specific action(s) is the Waiver being asked for? _____

A Waiver from the provisions in Section 4.2, 50-ft No Disturb Zone, of the Town Bylaw Regulation for a limited project qualifying under 310 CMR 10.53 (3)(f), "Maintenance and improvement of existing public roadways, but limited to widening less than a single lane, adding shoulders, correcting substandard intersections, and improving inadequate drainage systems."

How is the action(s) in the public interest, necessary to avoid a taking, necessary to prevent a safety hazard or water dependent? _____

The project will include construction a new shared-use path for non-motorized travel connecting to a commuter rail station on Foster St. The drinking water main underneath Foster St will be replaced during reconstruction of the road.

How is the action(s) consistent with the intent and purpose of the Bylaw? _____

The shared-use path for bicycles and pedestrians is a mitigating factor because it will expand the Town's non-motorized travel network to a public transit station. This will contribute to lowering vehicle exhaust emissions, a much needed step toward reducing climate change.

Existing and proposed site conditions (ie, impervious, lawn & disturbed areas) (square feet; show on plan): _____

Project area is 5.4 acres along a linear road corridor. Total length of road is 0.81 miles. Existing impervious is 2.93 acres in the project area from road surface, driveways, and some sidewalks.

Existing and proposed distances of land uses from wetland resource areas (show on plan): _____

Foster St will be shifted up to 4ft in some locations to the south side. A new 10ft wide shared-use path will be constructed on the west side of the road. The total paved cross section of the road and path will change from 28ft wide in the existing condition to 34ft wide in the proposed condition. The environmental impact plans show proposed permanent and temporary impacts to 50-ft No Disturb Zone and 100-ft Buffer Zone. There are no other proposed direct impacts to any other wetland resource area.

Analysis of less environmentally damaging practicable alternative: _____

An alternative that reconstructs Foster St as the same design as existing condition would avoid Buffer Zone and 50-FT No Disturb impacts. However, there would be no accommodation of safe and separated walking or biking in the corridor thus continuing an unsafe condition that encourages driving over non-motorized travel for short local trips.

Proposed short term and long term protection of wetland resource areas: _____

As shown in plans, erosion controls including sediment barriers and catch basin silt sacks will be installed during the full length of the project construction for short term protection of wetland resources. Long-term protection will be provided by an upgraded storm drainage system including new deep-sump catch basins, leaching catch basins, and cleaned/repared existing catch basins.

Is the site in a Zone I, II or III (groundwater) or Zone A, B or C (surface water) water supply area: The project limits are not within any of the above water supply areas.

Are there critical, unique or sensitive resource areas in the area (ie, NHESP mapped habitat, vernal pools, unusual wetland types, cold water fisheries, outstanding resource waters, Core Habitat, Conservation land, etc); show on plan: _____

There are no critical resource areas in the project limits nor nearby adjacent.

Other factors for consideration: _____

The final preferred alternative for the project chose a road design that had 1ft less width of pavement compared to a competing alternative which called for bike lanes and sidewalks on both sides of the road instead of the shared-use path in the preferred alternative.

Signature: _____

Stephen Jahhle, DPW Director

Project: _____

Reconstruction of Foster St. between Taylor St. and Balsam Lane including Foster St. intersections with Taylor St. and Grimes Ln.

Appendix G

Operation and Maintenance Plans

MEMORANDUM

TO: Town of Littleton, MA

FROM: Fuss & O'Neill, Inc.

DATE: April 18, 2023

RE: Construction Operation and Maintenance Plan
Foster Street Reconstruction
Littleton, MA

Responsible Party: Town of Littleton
Department of Public Works
39 Ayer Rd
Littleton, MA 01460

Property Owner shall be responsible for the operation and maintenance of the site during reconstruction Foster Street. Reconstruction of Foster Street includes full depth pavement replacement, replacement of existing stormwater drainage system, installation of a stormwater treatment structure, addition of a multi-use path and replacement of sidewalks. A suggested operation and maintenance activities and proposed schedule for during construction is as follows:

1. No earthwork activities shall commence until silt fence has been installed. Silt fence shall be installed as shown on the drawings.
2. Areas left exposed to erosion for more than seven days shall be rough graded and temporarily stabilized. Areas disturbed but inactive for more than thirty days shall be temporarily seeded.
3. Erosion and sedimentation controls shall be maintained initial successful establishment of ground cover.
4. No staging of materials or lay down areas shall be located within the resource areas.
5. Paved areas shall be kept free of sediment, and shall be cleaned periodically as required by construction activities.
6. Catch basins shall be periodically inspected for the accumulation of sediment. Catch basins within the project and downstream of work shall have catch basin protection installed and shall be cleaned at the end of the project.
7. Temporary soil stockpiles shall be located within areas consisting of formerly paved or developed surfaces, and will be moved as necessary to accommodate ongoing work.

8. Sediment stockpiles shall have a side slope of no greater than 2:1. Stockpiles shall be rough graded or maintain a roughened surface to prevent erosion. Stockpiles that are not to be used within 7 days shall be seeded after formation of stockpile as to prevent erosion. Straw bale barrier and silt fence shall be installed around stockpile area approximately 10 feet from toe of slope.
9. The contractor is responsible to inspect and repair erosion and sedimentation control measures as required to prevent damage or sedimentation.
10. Upon completion of construction and establishment of permanent ground cover, remove and dispose of temporary erosion control measures. Clean sediment and debris from temporary measures and from permanent storm drain and sanitary sewer systems.

Inspections shall be completed a minimum of every seven (7) calendar days and within 24 hours of the end of a storm event of 0.25 inches or greater. Attached is an example Inspection and Maintenance Report Form.

INPECTION AND MAINTENANCE REPORT FORM

Reconstruction of Foster Street, Littleton, MA

To be completed every 7 calendar days and within 24 hours of the end of a storm event of 0.25 inches or greater

Inspector: _____ Date: _____

Inspector's Title and Qualifications: _____

Summary of Previous 7-day Rainfall:

Date	Friday Date	Saturday Date	Sunday Date	Monday Date	Tuesday Date	Wednesday Date	Thursday Date
Total Daily Rainfall (in.)							

Stabilization Measures:

Area	Disturbed (Yes/No)	Stabilized (Yes/No)	Stabilized With	Condition

Detention Basin #1

Depth of Infiltration Basin	Condition of Side Slopes	Evidence of Overtopping of Embankments	Condition of Outfall

Construction Site & Adjacent Areas:

General condition: _____



INSPECTION AND MAINTENANCE REPORT FORM

Reconstruction of Foster Street, Littleton, MA

Is sediment being tracked on to road? _____

Maintenance required? _____

Changes Required to the Pollution Prevention Plan:

Reasons for Changes:

Certification:

I certify under penalty of law that this document and all attachments were prepared under my direction or supervision in accordance with a system designed to assure that qualified personnel properly gathered and evaluated the information submitted. Based on my inquiry of the person or persons who manage the system, or those persons directly responsible for gathering the information, the information submitted is, to the best of my knowledge and belief, true, accurate, and complete. I am aware that there are significant penalties for submitting false information, including the possibility of fine and imprisonment for knowing violations.

Signature: _____ Date: _____

MEMORANDUM

TO: Town of Littleton

FROM: Fuss & O'Neill, Inc.

DATE: April 18, 2023

RE: Long Term Operation and Maintenance Plan
Foster Street, Taylor Street, and Grimes Lane Reconstruction

This Long Term Operation and Maintenance Plan (O&M) is developed for the reconstruction of Foster Street. This O&M has been prepared in accordance the Massachusetts Stormwater Handbook and the Town of Littleton Regulations.

Responsible Party: Town of Littleton
Department of Public Works
39 Ayer Rd
Littleton, MA 01460

It will be the responsibility of the Town of Littleton to comply with this Long Term Operation and Maintenance Plan. Responsibility includes financing, maintenance and emergency repairs. Should the property or any portion of the property be transferred to another owner, that new owner will be notified of the presence of this Long Term Operation and Maintenance Plan and be held responsible for the implementation of this plan and financing as it pertains to their property.

Operation and Maintenance Plan

The post construction operation and maintenance plan outlined hereafter provides recommendations for periodic inspection and maintenance activities for the stormwater management system. This Long-Term Operation and Maintenance Plan will ensure that the stormwater management system functions as designed throughout the life of the system.

- The stormwater collection systems will be inspected a minimum of four (4) times per year to maintain proper operation. Sediment and debris shall be removed from structures and pipes. Sedimentation will be removed from each deep sump catch basin a minimum of four (4) times a year or whenever the depth of deposits is greater than or equal to one half the depth from the bottom of the invert of the lowest pipe. Deep sump catch basins shall be cleaned at the end of the foliage and snow removal seasons.
- Paved surfaces will be swept twice annually, April and October, to remove sand and debris following winter months.
- Stormwater structures and pipes will be inspected twice annually, April and November, for accumulation of sediment and debris. Clean as required.

Location and Access of Stormwater Management System

All components of the stormwater management system are located within Wisdom Way, River Street, and Mill Street. The attached Site Plans provide the location and access for the stormwater management system.

Records of Maintenance and Repair Activities

The responsible parties shall keep records of installation, maintenance and repairs of the stormwater management facilities. These records shall be retained for the most recent five years be provided to the Conservation Commission annually and upon request. An example Operation and Maintenance Log Form is attached.

Attachments: O&M Log Form

Post-Construction Operation and Maintenance Log Form

Foster Street, Taylor Street, and Grimes Lane Littleton, Massachusetts

Project/Location: _____

“As Built” Plans Available? _____

Date/Time: _____

Days Since Previous Rainfall and Rainfall Amount: _____

Inspector: _____

Maintenance Item	Satisfactory	Unsatisfactory	Comments
1. Street Sweeping - Paved Parking Areas			
• evidence of work performed			
Action to be Taken:			
Date to be Completed by:			
2. Deep Sump Catch Basins			
• Sump clean of all sedimentation			
Action to be Taken:			
Date to be Completed by:			

Source: Adapted from Watershed Management Institute, Inc. 1997. *Operation, Maintenance, and Management of Stormwater Management Systems*. In cooperation with U.S. Environmental Protection Agency, Office of Water. Washington, D.C.

Appendix H

TSS Removal Calculations for Deep Sump Catch Basins



Project: Foster Street
Site Location: Foster Street
Littleton, MA
Project Number: 20170044.A21
Outfall Location: Resource Areas

Prepared By: ATB
Date: 08/11/2023

BMP	TSS Removal Efficiency	Starting TSS Load	TSS Removed	TSS Remaining
deep sump hooded catch basins	25%	1.00	0.25	0.75

Total TSS Removal Efficiency=	25%
-------------------------------	-----



Project: Foster Street
Site Location: Foster Street
Littleton, MA
Project Number: 20170044.A21
Outfall Location: No Outfall

Prepared By: ATB
Date: 09/14/2023

BMP	TSS Removal Efficiency	Starting TSS Load	TSS Removed	TSS Remaining
Leaching Catch Basin Off line	25%	1.00	0.25	0.75

Total TSS Removal Efficiency=	25%
-------------------------------	-----

Appendix I

Illicit Impact Statement



Illicit Discharge Statement
Foster Street, Taylor Street, and Grimes Lane
Roadway Reconstruction

No illicit discharges are proposed to enter the redeveloped stormwater system located within Foster Street, Taylor Street, and Grimes Lane. Inspection procedures outline in the Long-Term Operation and Maintenance Plan will be strictly followed to ensure contaminations do not enter the stormwater system. Illicit discharge detection and elimination procedures will be implemented routinely by visual inspections to prevent illicit discharges into the stormwater system. Town of Littleton DPW personnel are informed of the illicit discharge detection and elimination procedures and that no illicit discharges are allowed to enter the stormwater system.

Appendix J


Stormwater Checklist



Checklist for Stormwater Report

A. Introduction

Important: When filling out forms on the computer, use only the tab key to move your cursor - do not use the return key.

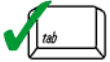

A Stormwater Report must be submitted with the Notice of Intent permit application to document compliance with the Stormwater Management Standards. The following checklist is NOT a substitute for the Stormwater Report (which should provide more substantive and detailed information) but is offered here as a tool to help the applicant organize their Stormwater Management documentation for their Report and for the reviewer to assess this information in a consistent format. As noted in the Checklist, the Stormwater Report must contain the engineering computations and supporting information set forth in Volume 3 of the [Massachusetts Stormwater Handbook](#). The Stormwater Report must be prepared and certified by a Registered Professional Engineer (RPE) licensed in the Commonwealth.

The Stormwater Report must include:

- The Stormwater Checklist completed and stamped by a Registered Professional Engineer (see page 2) that certifies that the Stormwater Report contains all required submittals.¹ This Checklist is to be used as the cover for the completed Stormwater Report.
- Applicant/Project Name
- Project Address
- Name of Firm and Registered Professional Engineer that prepared the Report
- Long-Term Pollution Prevention Plan required by Standards 4-6
- Construction Period Pollution Prevention and Erosion and Sedimentation Control Plan required by Standard 8²
- Operation and Maintenance Plan required by Standard 9

In addition to all plans and supporting information, the Stormwater Report must include a brief narrative describing stormwater management practices, including environmentally sensitive site design and LID techniques, along with a diagram depicting runoff through the proposed BMP treatment train. Plans are required to show existing and proposed conditions, identify all wetland resource areas, NRCS soil types, critical areas, Land Uses with Higher Potential Pollutant Loads (LUHPPL), and any areas on the site where infiltration rate is greater than 2.4 inches per hour. The Plans shall identify the drainage areas for both existing and proposed conditions at a scale that enables verification of supporting calculations.

As noted in the Checklist, the Stormwater Management Report shall document compliance with each of the Stormwater Management Standards as provided in the Massachusetts Stormwater Handbook. The soils evaluation and calculations shall be done using the methodologies set forth in Volume 3 of the Massachusetts Stormwater Handbook.

To ensure that the Stormwater Report is complete, applicants are required to fill in the Stormwater Report Checklist by checking the box to indicate that the specified information has been included in the Stormwater Report. If any of the information specified in the checklist has not been submitted, the applicant must provide an explanation. The completed Stormwater Report Checklist and Certification must be submitted with the Stormwater Report.

¹ The Stormwater Report may also include the Illicit Discharge Compliance Statement required by Standard 10. If not included in the Stormwater Report, the Illicit Discharge Compliance Statement must be submitted prior to the discharge of stormwater runoff to the post-construction best management practices.

² For some complex projects, it may not be possible to include the Construction Period Erosion and Sedimentation Control Plan in the Stormwater Report. In that event, the issuing authority has the discretion to issue an Order of Conditions that approves the project and includes a condition requiring the proponent to submit the Construction Period Erosion and Sedimentation Control Plan before commencing any land disturbance activity on the site.



Checklist for Stormwater Report

B. Stormwater Checklist and Certification

The following checklist is intended to serve as a guide for applicants as to the elements that ordinarily need to be addressed in a complete Stormwater Report. The checklist is also intended to provide conservation commissions and other reviewing authorities with a summary of the components necessary for a comprehensive Stormwater Report that addresses the ten Stormwater Standards.


Note: Because stormwater requirements vary from project to project, it is possible that a complete Stormwater Report may not include information on some of the subjects specified in the Checklist. If it is determined that a specific item does not apply to the project under review, please note that the item is not applicable (N.A.) and provide the reasons for that determination.

A complete checklist must include the Certification set forth below signed by the Registered Professional Engineer who prepared the Stormwater Report.

Registered Professional Engineer's Certification

I have reviewed the Stormwater Report, including the soil evaluation, computations, Long-term Pollution Prevention Plan, the Construction Period Erosion and Sedimentation Control Plan (if included), the Long-term Post-Construction Operation and Maintenance Plan, the Illicit Discharge Compliance Statement (if included) and the plans showing the stormwater management system, and have determined that they have been prepared in accordance with the requirements of the Stormwater Management Standards as further elaborated by the Massachusetts Stormwater Handbook. I have also determined that the information presented in the Stormwater Checklist is accurate and that the information presented in the Stormwater Report accurately reflects conditions at the site as of the date of this permit application.

Registered Professional Engineer Block and Signature

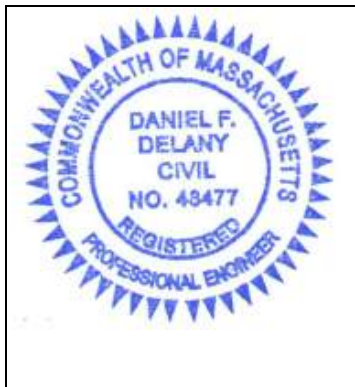

9/18/23

Signature and Date

Checklist

Project Type: Is the application for new development, redevelopment, or a mix of new and redevelopment?

- ☐ New development
- ☒ Redevelopment
- ☐ Mix of New Development and Redevelopment



Checklist for Stormwater Report

Checklist (continued)

LID Measures: Stormwater Standards require LID measures to be considered. Document what environmentally sensitive design and LID Techniques were considered during the planning and design of the project:

- ☒ No disturbance to any Wetland Resource Areas
- ☐ Site Design Practices (e.g. clustered development, reduced frontage setbacks)
- ☐ Reduced Impervious Area (Redevelopment Only)
- ☐ Minimizing disturbance to existing trees and shrubs
- ☐ LID Site Design Credit Requested:
 - ☐ Credit 1
 - ☐ Credit 2
 - ☐ Credit 3
- ☐ Use of "country drainage" versus curb and gutter conveyance and pipe
- ☐ Bioretention Cells (includes Rain Gardens)
- ☐ Constructed Stormwater Wetlands (includes Gravel Wetlands designs)
- ☐ Treebox Filter
- ☐ Water Quality Swale
- ☐ Grass Channel
- ☐ Green Roof
- ☐ Other (describe): _____

Standard 1: No New Untreated Discharges

- ☒ No new untreated discharges
- ☒ Outlets have been designed so there is no erosion or scour to wetlands and waters of the Commonwealth
- ☐ Supporting calculations specified in Volume 3 of the Massachusetts Stormwater Handbook included.



Checklist for Stormwater Report

Checklist (continued)

Standard 2: Peak Rate Attenuation

- ☐ Standard 2 waiver requested because the project is located in land subject to coastal storm flowage and stormwater discharge is to a wetland subject to coastal flooding.
- ☐ Evaluation provided to determine whether off-site flooding increases during the 100-year 24-hour storm.
- ☐ Calculations provided to show that post-development peak discharge rates do not exceed pre-development rates for the 2-year and 10-year 24-hour storms. If evaluation shows that off-site flooding increases during the 100-year 24-hour storm, calculations are also provided to show that post-development peak discharge rates do not exceed pre-development rates for the 100-year 24-hour storm.

Standard 3: Recharge

- ☐ Soil Analysis provided.
- ☐ Required Recharge Volume calculation provided.
- ☐ Required Recharge volume reduced through use of the LID site Design Credits.
- ☐ Sizing the infiltration, BMPs is based on the following method: Check the method used.
 - ☐ Static
 - ☐ Simple Dynamic
 - ☐ Dynamic Field¹
- ☐ Runoff from all impervious areas at the site discharging to the infiltration BMP.
- ☐ Runoff from all impervious areas at the site is *not* discharging to the infiltration BMP and calculations are provided showing that the drainage area contributing runoff to the infiltration BMPs is sufficient to generate the required recharge volume.
- ☐ Recharge BMPs have been sized to infiltrate the Required Recharge Volume.
- ☐ Recharge BMPs have been sized to infiltrate the Required Recharge Volume *only* to the maximum extent practicable for the following reason:
 - ☐ Site is comprised solely of C and D soils and/or bedrock at the land surface
 - ☐ M.G.L. c. 21E sites pursuant to 310 CMR 40.0000
 - ☐ Solid Waste Landfill pursuant to 310 CMR 19.000
 - ☐ Project is otherwise subject to Stormwater Management Standards only to the maximum extent practicable.
- ☐ Calculations showing that the infiltration BMPs will drain in 72 hours are provided.
- ☐ Property includes a M.G.L. c. 21E site or a solid waste landfill and a mounding analysis is included.

¹ 80% TSS removal is required prior to discharge to infiltration BMP if Dynamic Field method is used.



Checklist for Stormwater Report

Checklist (continued)

Standard 3: Recharge (continued)

- ☐ The infiltration BMP is used to attenuate peak flows during storms greater than or equal to the 10-year 24-hour storm and separation to seasonal high groundwater is less than 4 feet and a mounding analysis is provided.
- ☐ Documentation is provided showing that infiltration BMPs do not adversely impact nearby wetland resource areas.

Standard 4: Water Quality

The Long-Term Pollution Prevention Plan typically includes the following:

- Good housekeeping practices;
 - Provisions for storing materials and waste products inside or under cover;
 - Vehicle washing controls;
 - Requirements for routine inspections and maintenance of stormwater BMPs;
 - Spill prevention and response plans;
 - Provisions for maintenance of lawns, gardens, and other landscaped areas;
 - Requirements for storage and use of fertilizers, herbicides, and pesticides;
 - Pet waste management provisions;
 - Provisions for operation and management of septic systems;
 - Provisions for solid waste management;
 - Snow disposal and plowing plans relative to Wetland Resource Areas;
 - Winter Road Salt and/or Sand Use and Storage restrictions;
 - Street sweeping schedules;
 - Provisions for prevention of illicit discharges to the stormwater management system;
 - Documentation that Stormwater BMPs are designed to provide for shutdown and containment in the event of a spill or discharges to or near critical areas or from LUHPPL;
 - Training for staff or personnel involved with implementing Long-Term Pollution Prevention Plan;
 - List of Emergency contacts for implementing Long-Term Pollution Prevention Plan.
- ☒ A Long-Term Pollution Prevention Plan is attached to Stormwater Report and is included as an attachment to the Wetlands Notice of Intent.
- ☐ Treatment BMPs subject to the 44% TSS removal pretreatment requirement and the one inch rule for calculating the water quality volume are included, and discharge:
- ☐ is within the Zone II or Interim Wellhead Protection Area
 - ☐ is near or to other critical areas
 - ☐ is within soils with a rapid infiltration rate (greater than 2.4 inches per hour)
 - ☐ involves runoff from land uses with higher potential pollutant loads.
- ☐ The Required Water Quality Volume is reduced through use of the LID site Design Credits.
- ☐ Calculations documenting that the treatment train meets the 80% TSS removal requirement and, if applicable, the 44% TSS removal pretreatment requirement, are provided.



Checklist for Stormwater Report

Checklist (continued)

Standard 4: Water Quality (continued)

- ☐ The BMP is sized (and calculations provided) based on:
 - ☐ The ½" or 1" Water Quality Volume or
 - ☐ The equivalent flow rate associated with the Water Quality Volume and documentation is provided showing that the BMP treats the required water quality volume.
- ☐ The applicant proposes to use proprietary BMPs, and documentation supporting use of proprietary BMP and proposed TSS removal rate is provided. This documentation may be in the form of the propriety BMP checklist found in Volume 2, Chapter 4 of the Massachusetts Stormwater Handbook and submitting copies of the TARP Report, STEP Report, and/or other third party studies verifying performance of the proprietary BMPs.
- ☐ A TMDL exists that indicates a need to reduce pollutants other than TSS and documentation showing that the BMPs selected are consistent with the TMDL is provided.

Standard 5: Land Uses With Higher Potential Pollutant Loads (LUHPPLs)

- ☐ The NPDES Multi-Sector General Permit covers the land use and the Stormwater Pollution Prevention Plan (SWPPP) has been included with the Stormwater Report.
- ☐ The NPDES Multi-Sector General Permit covers the land use and the SWPPP will be submitted **prior to** the discharge of stormwater to the post-construction stormwater BMPs.
- ☐ The NPDES Multi-Sector General Permit does **not** cover the land use.
- ☐ LUHPPLs are located at the site and industry specific source control and pollution prevention measures have been proposed to reduce or eliminate the exposure of LUHPPLs to rain, snow, snow melt and runoff, and been included in the long term Pollution Prevention Plan.
- ☐ All exposure has been eliminated.
- ☐ All exposure has **not** been eliminated and all BMPs selected are on MassDEP LUHPPL list.
- ☐ The LUHPPL has the potential to generate runoff with moderate to higher concentrations of oil and grease (e.g. all parking lots with >1000 vehicle trips per day) and the treatment train includes an oil grit separator, a filtering bioretention area, a sand filter or equivalent.

Standard 6: Critical Areas

- ☐ The discharge is near or to a critical area and the treatment train includes only BMPs that MassDEP has approved for stormwater discharges to or near that particular class of critical area.
- ☐ Critical areas and BMPs are identified in the Stormwater Report.



Checklist for Stormwater Report

Checklist (continued)

Standard 7: Redevelopments and Other Projects Subject to the Standards only to the maximum extent practicable

- ☒ The project is subject to the Stormwater Management Standards only to the maximum Extent Practicable as a:
 - ☒ Limited Project
 - ☐ Small Residential Projects: 5-9 single family houses or 5-9 units in a multi-family development provided there is no discharge that may potentially affect a critical area.
 - ☐ Small Residential Projects: 2-4 single family houses or 2-4 units in a multi-family development with a discharge to a critical area
 - ☐ Marina and/or boatyard provided the hull painting, service and maintenance areas are protected from exposure to rain, snow, snow melt and runoff
 - ☒ Bike Path and/or Foot Path
 - ☒ Redevelopment Project
 - ☐ Redevelopment portion of mix of new and redevelopment.
- ☒ Certain standards are not fully met (Standard No. 1, 8, 9, and 10 must always be fully met) and an explanation of why these standards are not met is contained in the Stormwater Report.
- ☐ The project involves redevelopment and a description of all measures that have been taken to improve existing conditions is provided in the Stormwater Report. The redevelopment checklist found in Volume 2 Chapter 3 of the Massachusetts Stormwater Handbook may be used to document that the proposed stormwater management system (a) complies with Standards 2, 3 and the pretreatment and structural BMP requirements of Standards 4-6 to the maximum extent practicable and (b) improves existing conditions.

Standard 8: Construction Period Pollution Prevention and Erosion and Sedimentation Control

A Construction Period Pollution Prevention and Erosion and Sedimentation Control Plan must include the following information:

- Narrative;
 - Construction Period Operation and Maintenance Plan;
 - Names of Persons or Entity Responsible for Plan Compliance;
 - Construction Period Pollution Prevention Measures;
 - Erosion and Sedimentation Control Plan Drawings;
 - Detail drawings and specifications for erosion control BMPs, including sizing calculations;
 - Vegetation Planning;
 - Site Development Plan;
 - Construction Sequencing Plan;
 - Sequencing of Erosion and Sedimentation Controls;
 - Operation and Maintenance of Erosion and Sedimentation Controls;
 - Inspection Schedule;
 - Maintenance Schedule;
 - Inspection and Maintenance Log Form.
- ☒ A Construction Period Pollution Prevention and Erosion and Sedimentation Control Plan containing the information set forth above has been included in the Stormwater Report.



Checklist for Stormwater Report

Checklist (continued)

Standard 8: Construction Period Pollution Prevention and Erosion and Sedimentation Control (continued)

- ☐ The project is highly complex and information is included in the Stormwater Report that explains why it is not possible to submit the Construction Period Pollution Prevention and Erosion and Sedimentation Control Plan with the application. A Construction Period Pollution Prevention and Erosion and Sedimentation Control has **not** been included in the Stormwater Report but will be submitted **before** land disturbance begins.
- ☐ The project is **not** covered by a NPDES Construction General Permit.
- ☐ The project is covered by a NPDES Construction General Permit and a copy of the SWPPP is in the Stormwater Report.
- ☒ The project is covered by a NPDES Construction General Permit but no SWPPP been submitted. The SWPPP will be submitted BEFORE land disturbance begins.

Standard 9: Operation and Maintenance Plan

- ☒ The Post Construction Operation and Maintenance Plan is included in the Stormwater Report and includes the following information:
 - ☐ Name of the stormwater management system owners;
 - ☒ Party responsible for operation and maintenance;
 - ☒ Schedule for implementation of routine and non-routine maintenance tasks;
 - ☐ Plan showing the location of all stormwater BMPs maintenance access areas;
 - ☐ Description and delineation of public safety features;
 - ☐ Estimated operation and maintenance budget; and
 - ☒ Operation and Maintenance Log Form.
- ☐ The responsible party is **not** the owner of the parcel where the BMP is located and the Stormwater Report includes the following submissions:
 - ☐ A copy of the legal instrument (deed, homeowner's association, utility trust or other legal entity) that establishes the terms of and legal responsibility for the operation and maintenance of the project site stormwater BMPs;
 - ☐ A plan and easement deed that allows site access for the legal entity to operate and maintain BMP functions.

Standard 10: Prohibition of Illicit Discharges

- ☒ The Long-Term Pollution Prevention Plan includes measures to prevent illicit discharges;
- ☒ An Illicit Discharge Compliance Statement is attached;
- ☐ NO Illicit Discharge Compliance Statement is attached but will be submitted **prior to** the discharge of any stormwater to post-construction BMPs.