



AMZL DKO1 AVI

151-153 TAYLOR STREET
LITTLETON, MA 01460
CD 100% FOR REVIEW


2/7/2025

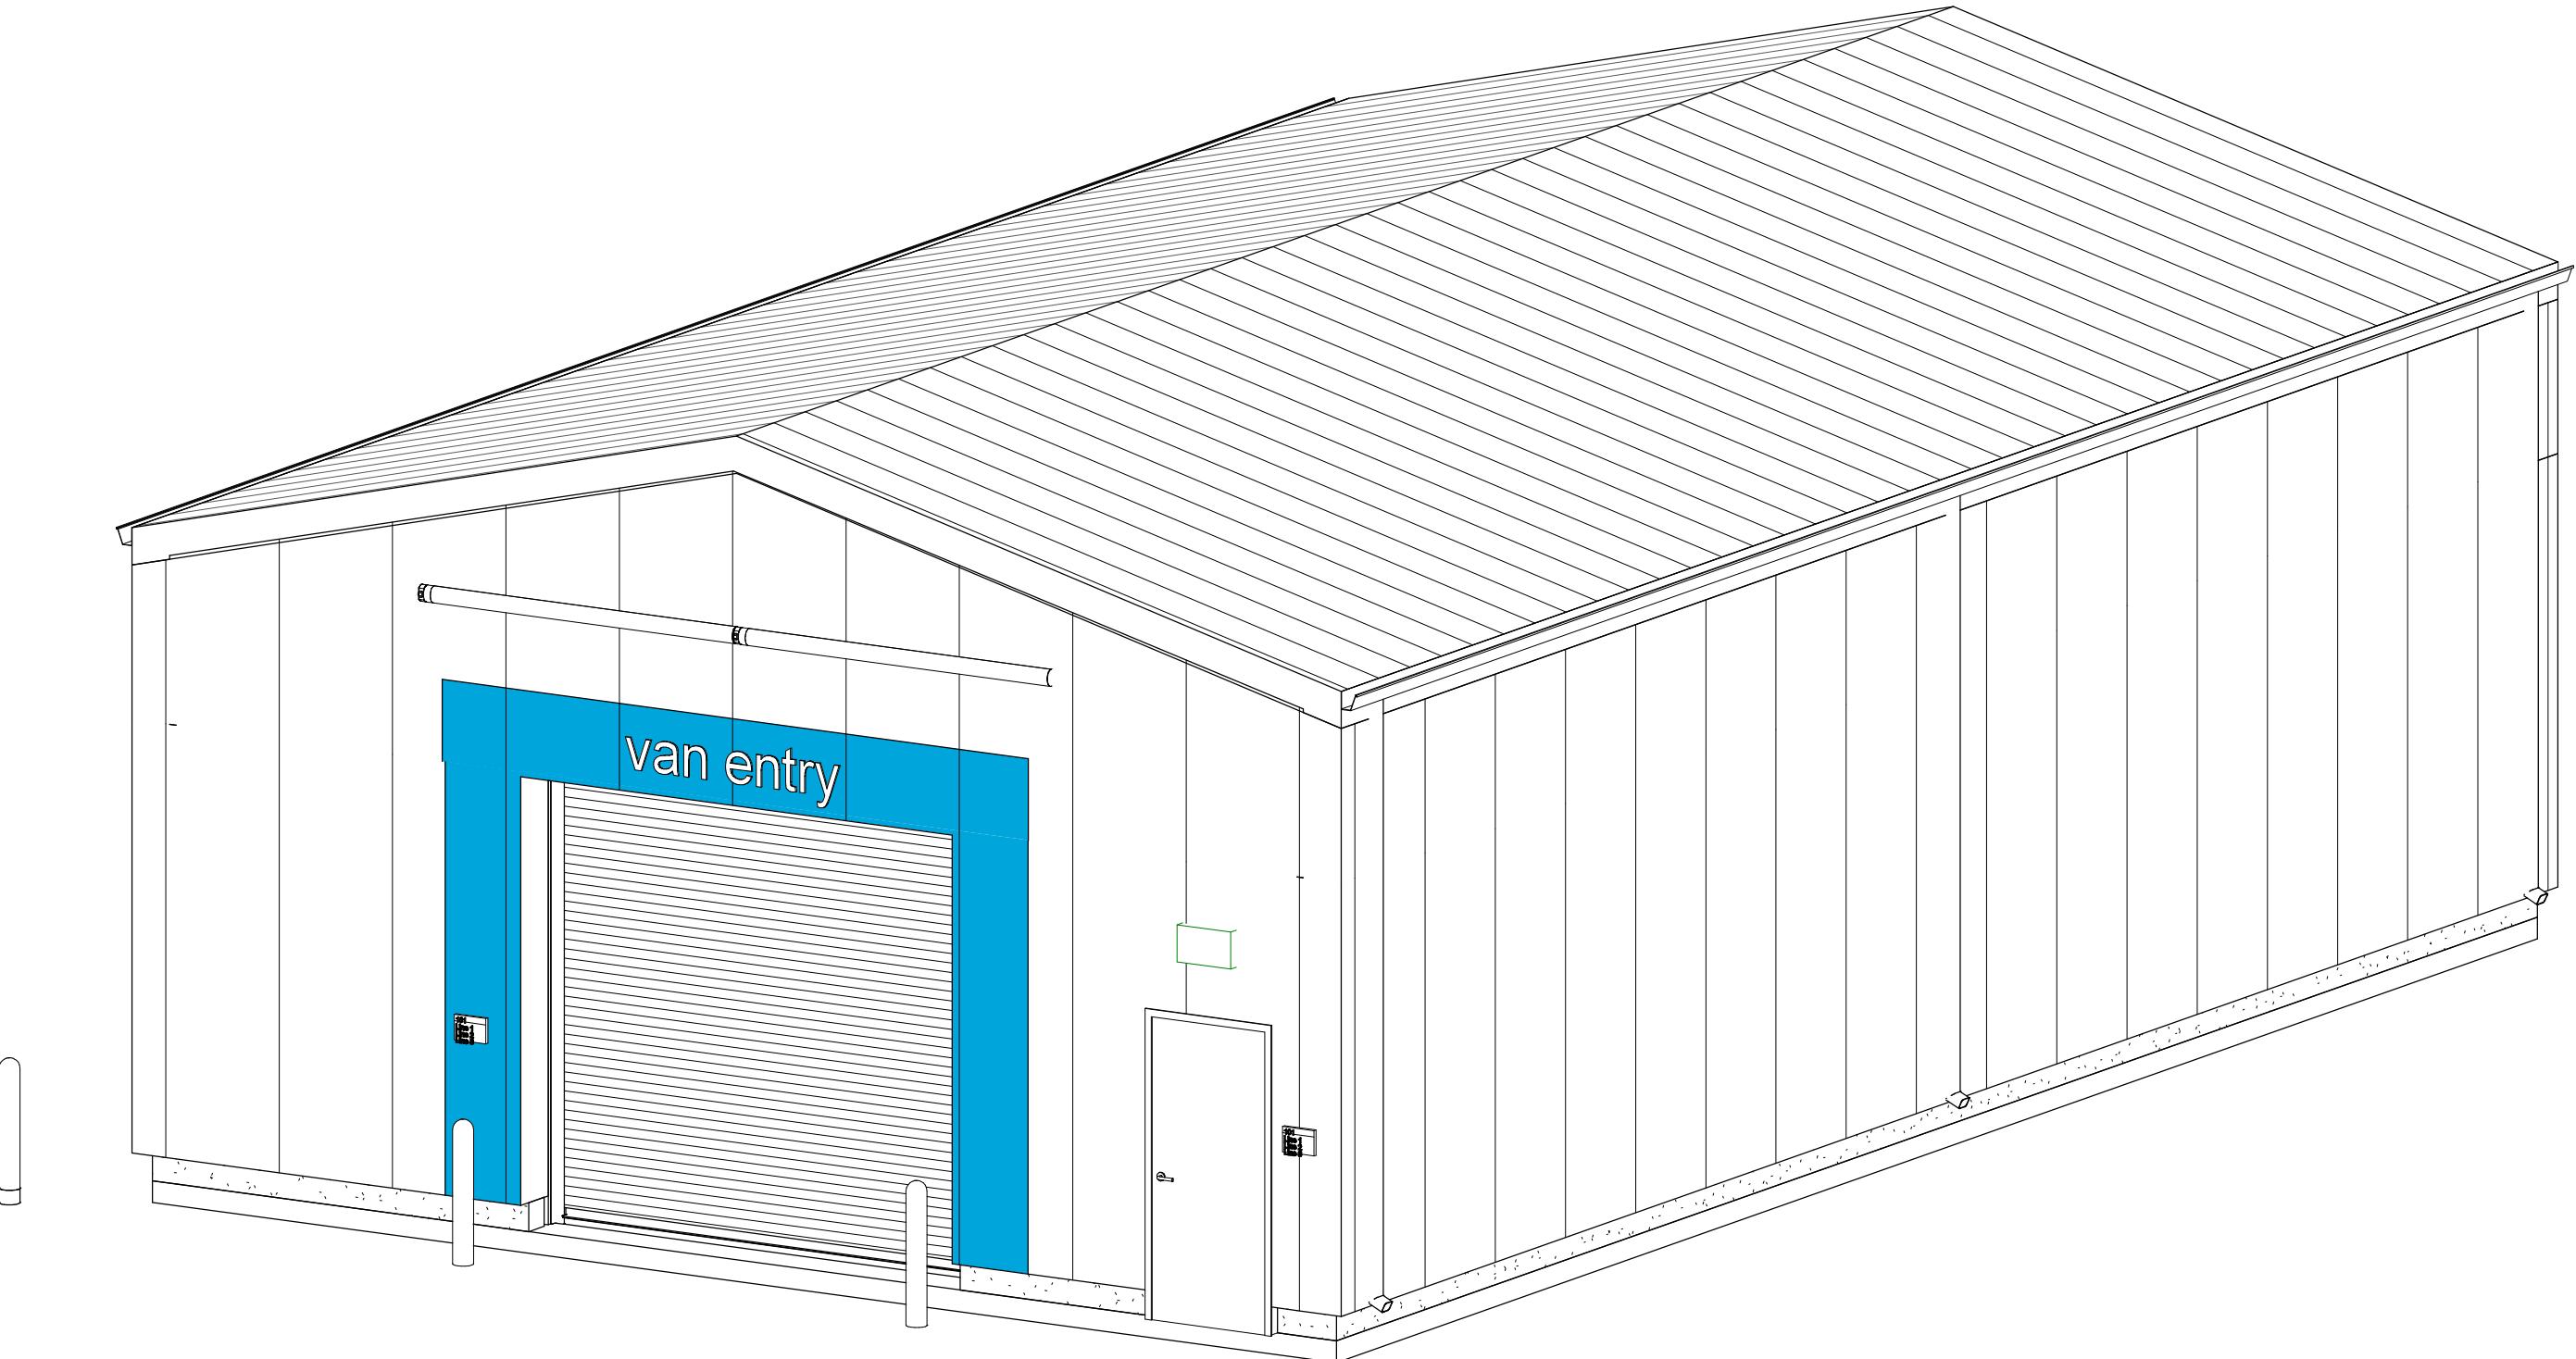

AVI BUILDING PERSPECTIVE

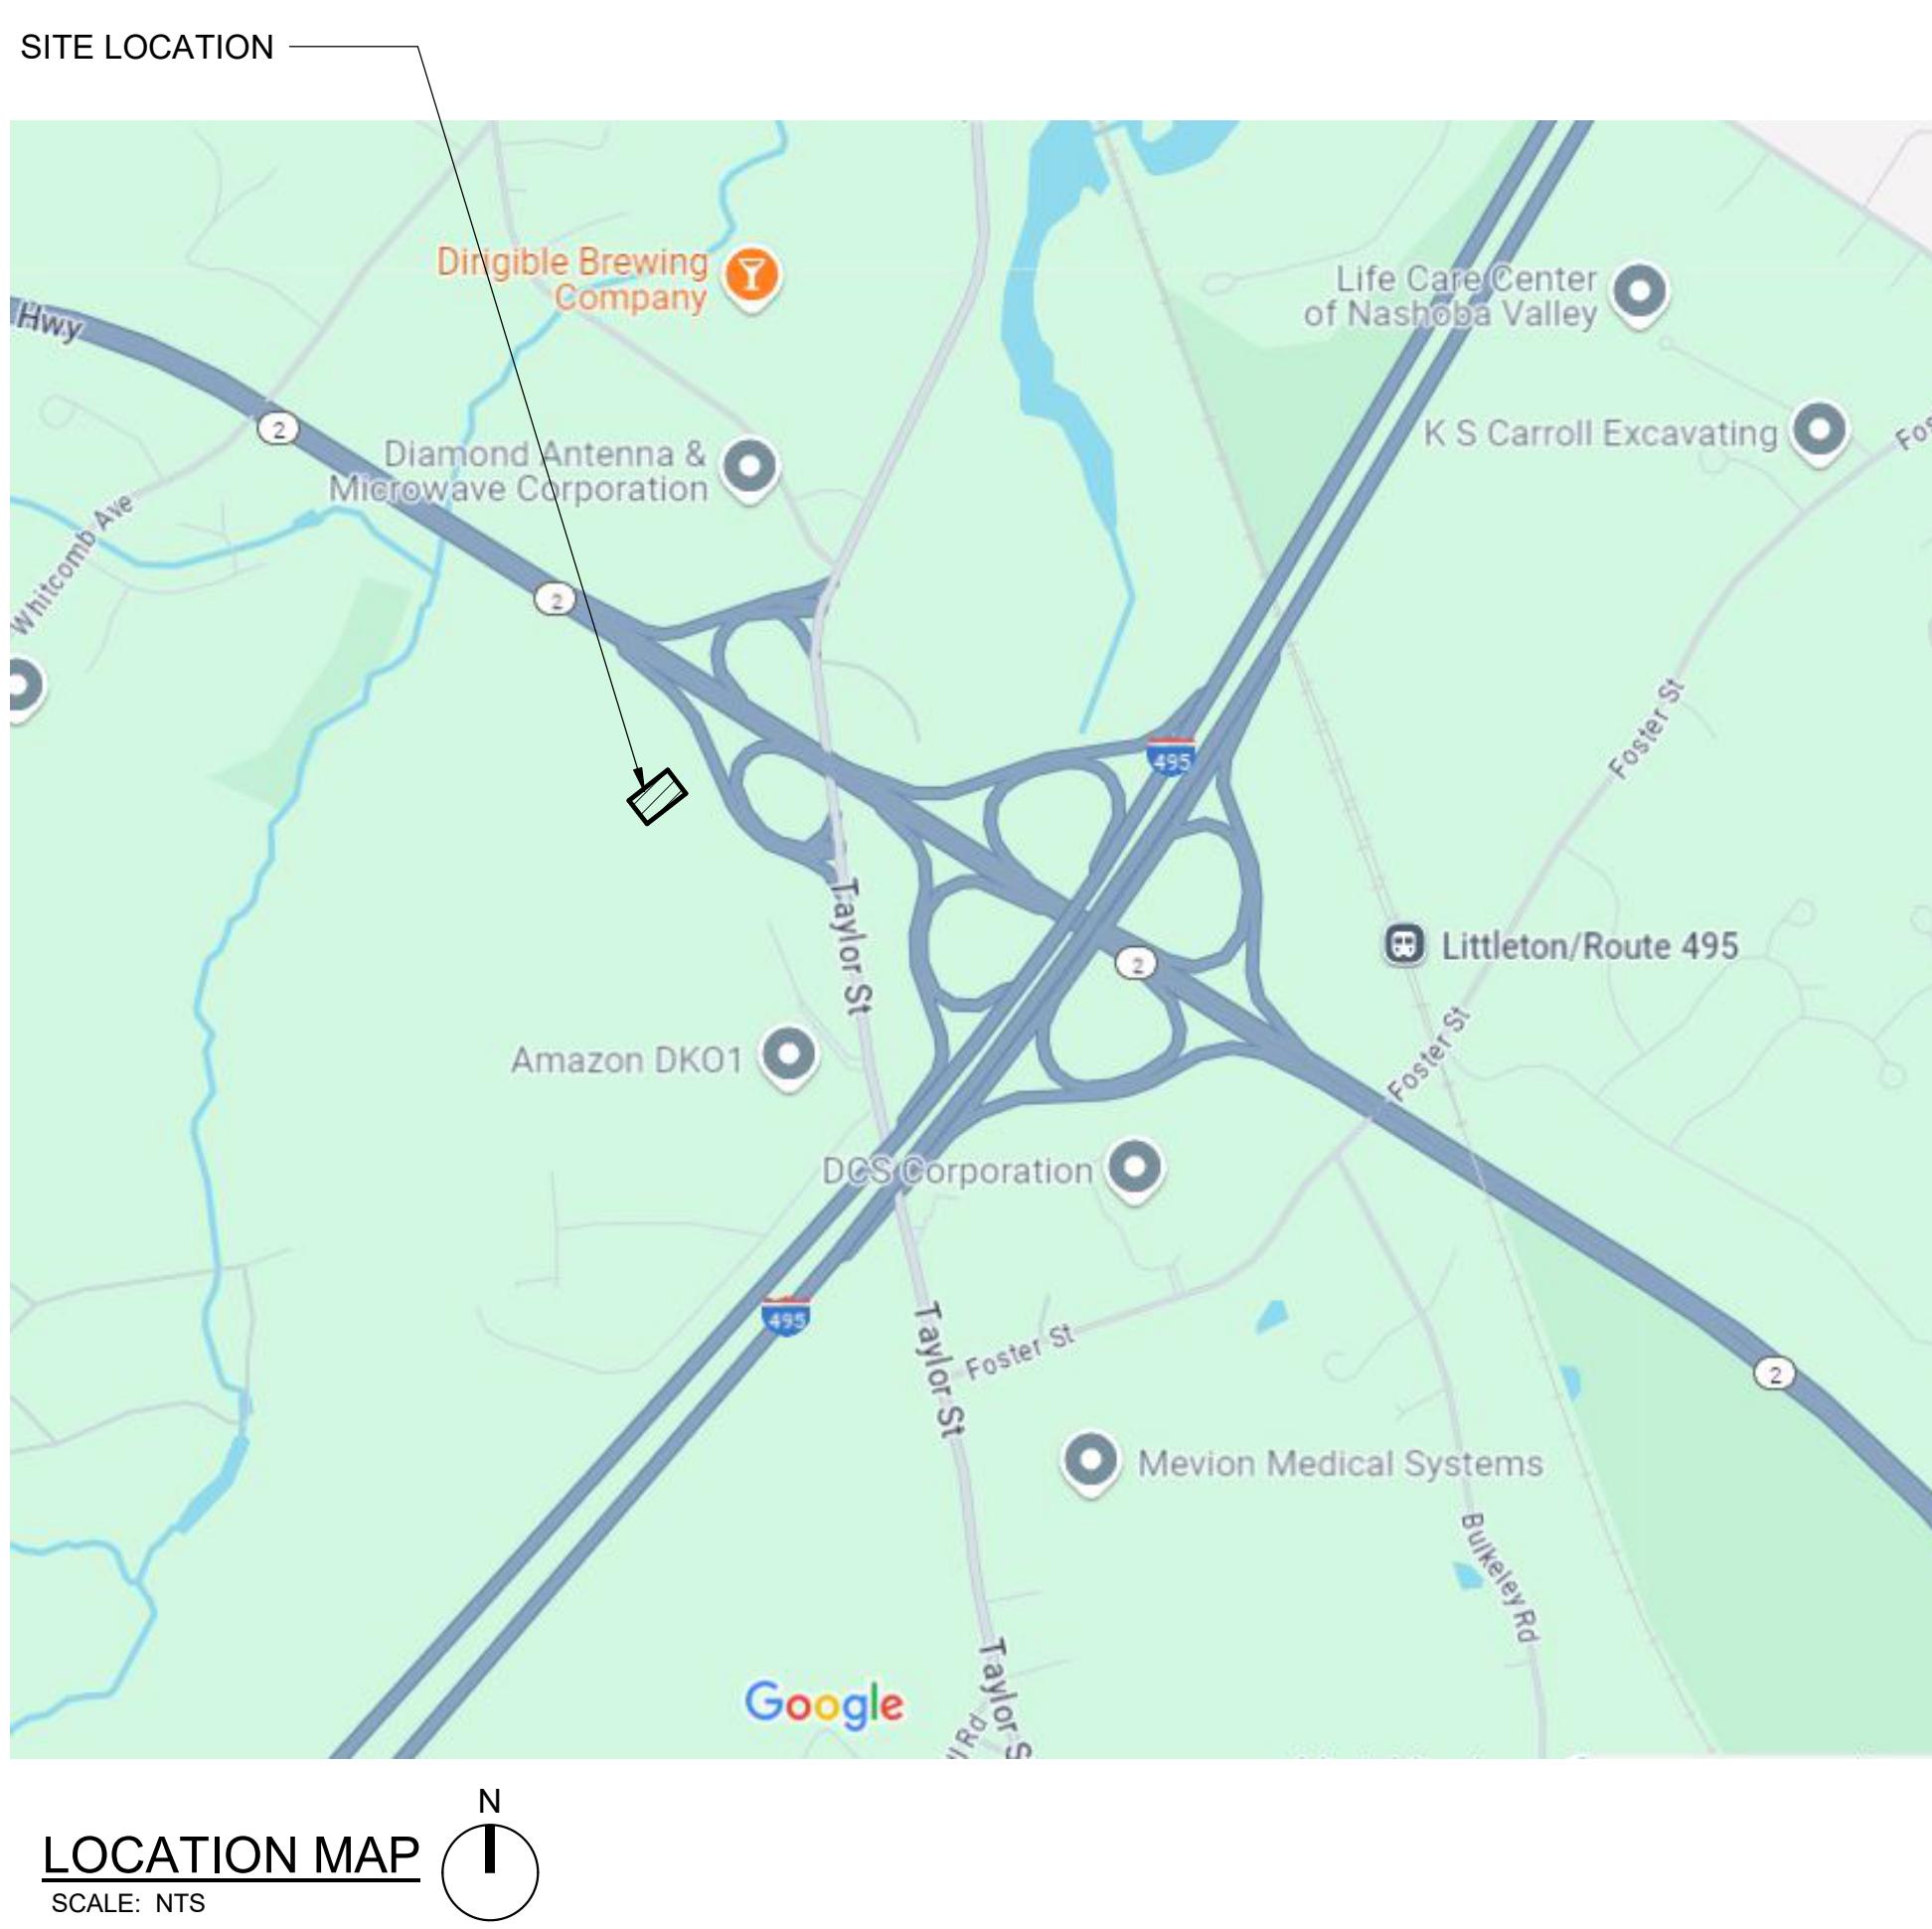

LOCATION MAP
SCALE: NTS

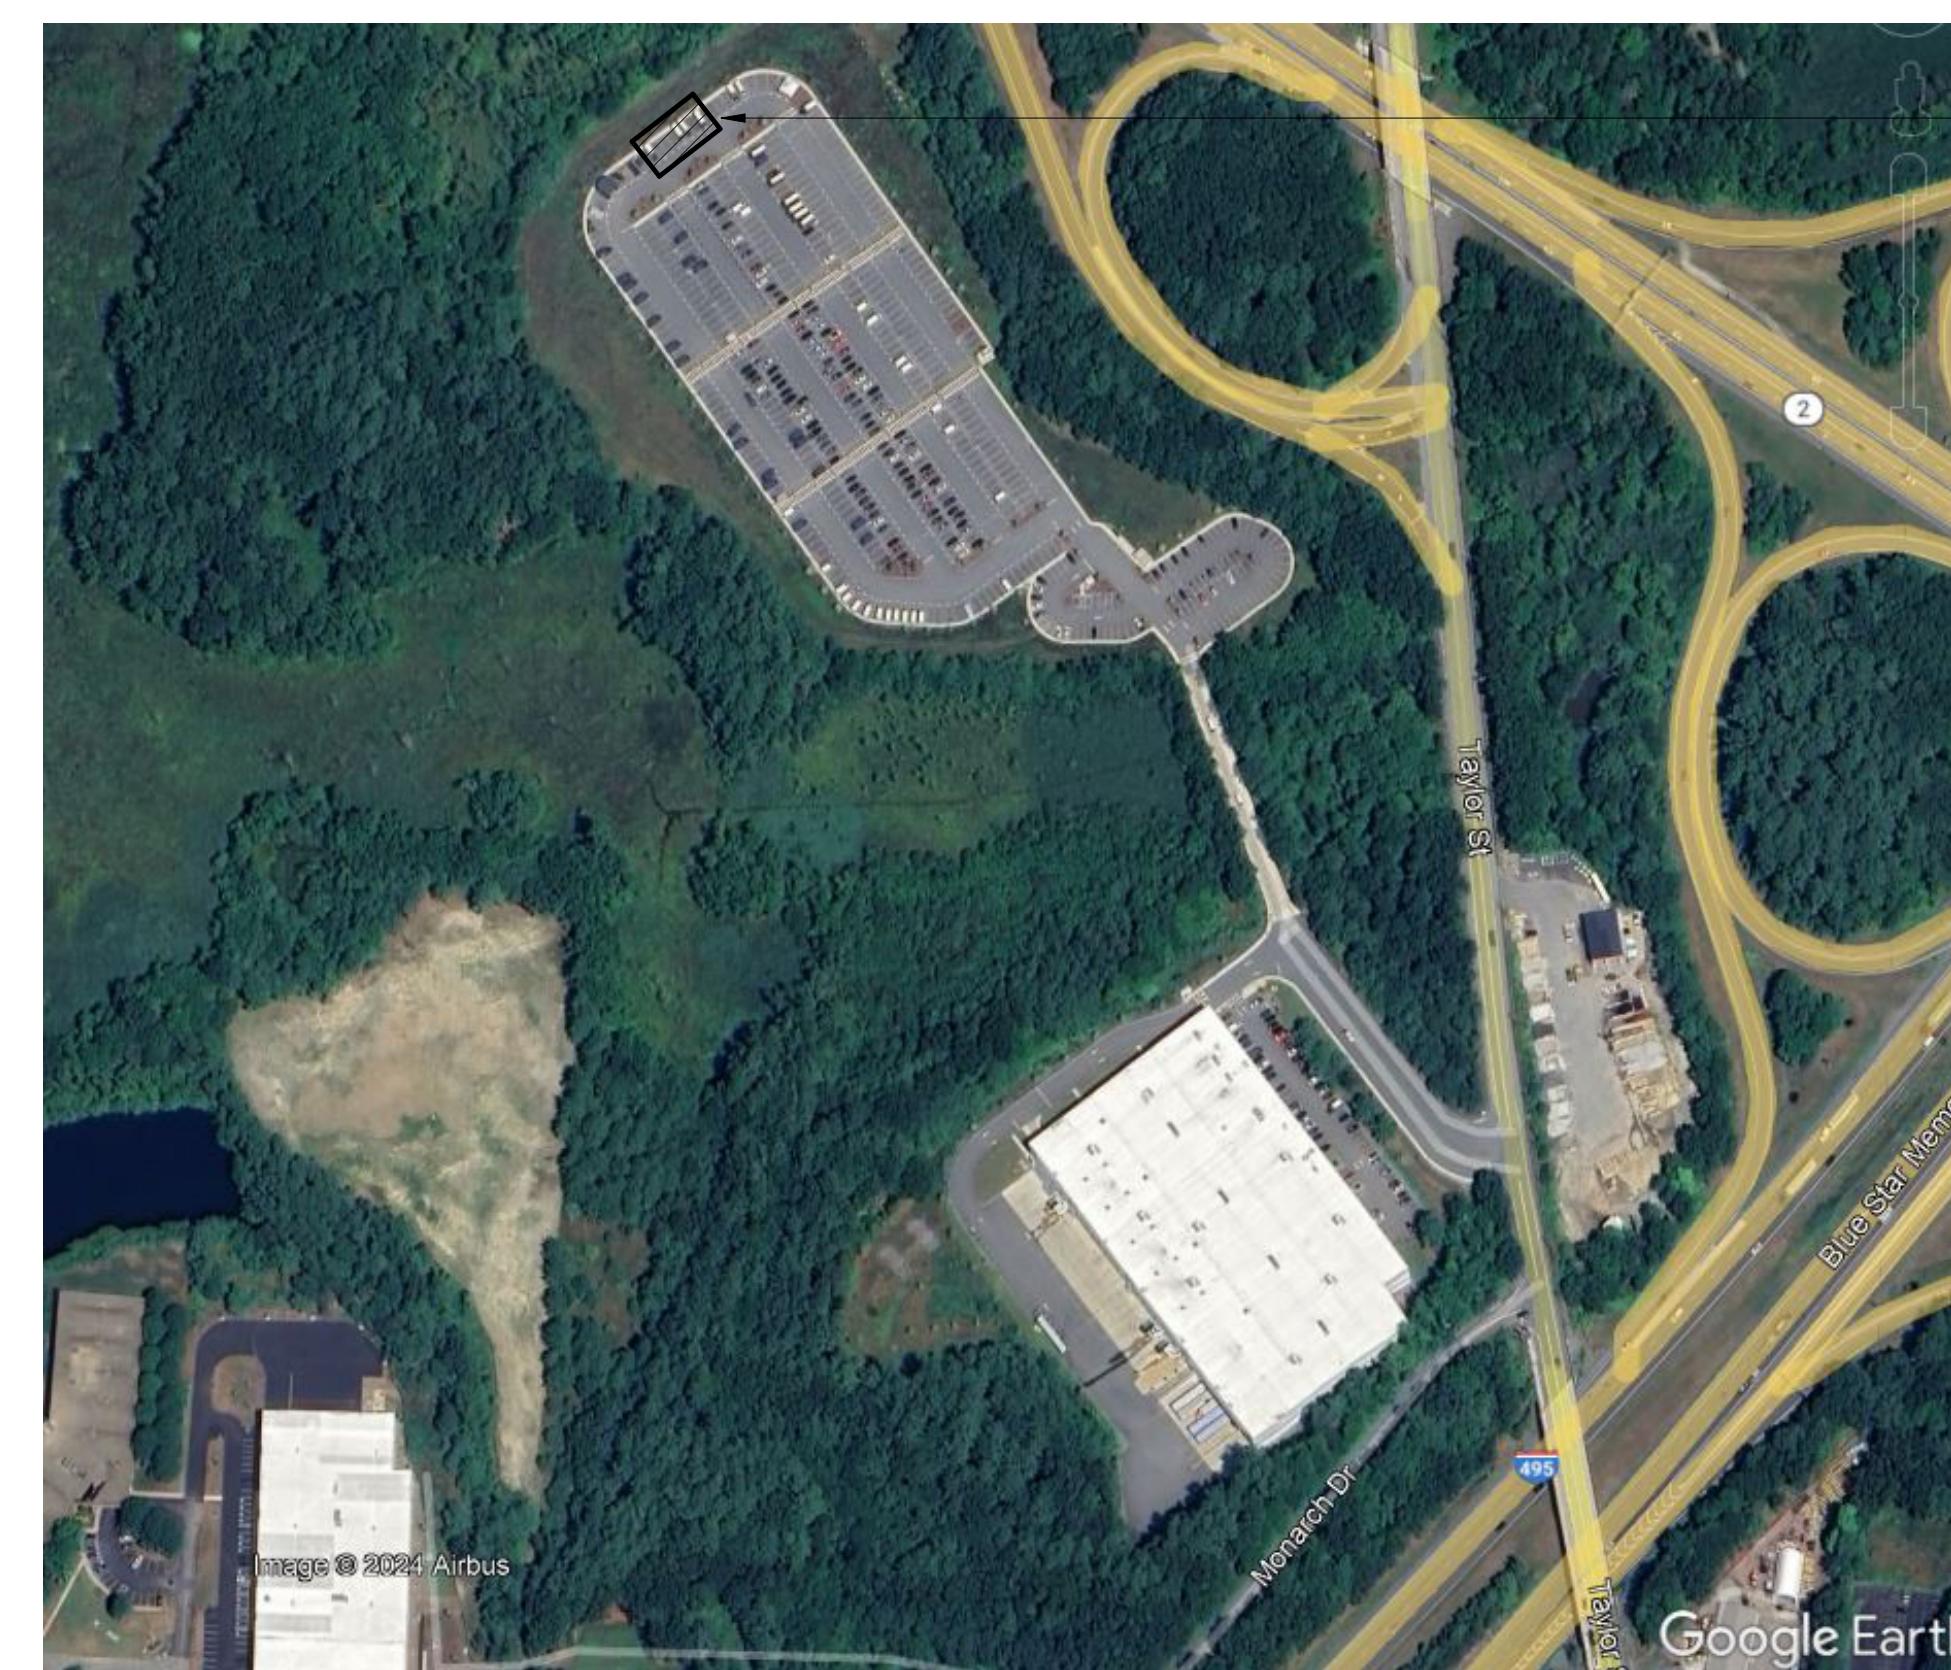

VICINITY MAP
SCALE: NTS

SHEET NUMBER	SHEET NAME
GENERAL	
G-001	COVER SHEET
G-101	CODE SUMMARY & LIFE SAFETY PLAN
SHEET TOTAL: 2	

CIVIL	
C-001	CIVIL GENERAL NOTE
CD101	DEMOLITION PLAN
CS101	SITE PLAN
CG101	GRADING AND UTILITY PLAN
C-501	CONSTRUCTION DETAILS
C-502	CONSTRUCTION DETAILS
CE101	EROSION & SEDIMENT CONTROL PLAN
CE501	EROSION & SEDIMENT CONTROL DETAILS
SHEET TOTAL: 8	

ARCHITECTURAL	
A-001	ARCHITECTURAL GENERAL NOTES, ABBREVIATIONS, MATERIALS & SYMBOLS
AS101	ARCHITECTURAL SITE PLAN
A-101	FLOOR AND REFLECTED CEILING PLANS
A-201	EXTERIOR ELEVATIONS AND SECTIONS
A-351	WALL SECTIONS AND DETAILS
A-601	DOOR SCHEDULE
A-701	sheet specifications
SHEET TOTAL: 7	

STRUCTURAL	
S-001	GENERAL STRUCTURAL NOTES
S-002	GENERAL STRUCTURAL NOTES
S-003	ABBREVIATIONS & WIND LOADING DIAGRAM
S-004	SPECIAL INSPECTIONS
S-101	FOUNDATION PLAN
S-151	ROOF FRAMING PLAN
S-301	FOUNDATION SECTIONS
S-501	CONCRETE DETAILS
SHEET TOTAL: 8	

ELECTRICAL	
E-001	ELECTRICAL GENERAL NOTES AND ABBREVIATIONS
E-002	ELECTRICAL LEGEND
ES101	ELECTRICAL SITE PLAN
E-101	LIGHTING PLAN
E-111	ENLARGED POWER PLAN & ONE-LINE DIAGRAM
E-501	ELECTRICAL DETAILS
E-801	ELECTRICAL SPECIFICATIONS
SHEET TOTAL: 7	

DRAWING ISSUE
2/7/2025
16/2025
DATE

CD 100% FOR REVIEW
ISSUED FOR REVIEW

DESIGNED BY: JOC
DRAWN BY: MA
CHECKED BY: KK
SUBMITTED BY: JAM
DATE: 2/7/2025
PROJECT #: 1240262

COVER SHEET
B
A
MARK


SHEET NUMBER
G-001

ORIGINAL SHEET SIZE:
30" x 42"

DESIGN TEAM

CIVIL ENGINEER Pond and Company 3500 Parkway Lane, Suite 500 Peachtree Corners, GA 30092 Phone (678) 336-7740 Fax (678) 336-7744	STRUCTURAL ENGINEER Pond and Company 3500 Parkway Lane, Suite 500 Peachtree Corners, GA 30092 Phone (678) 336-7740 Fax (678) 336-7744	ARCHITECT Pond and Company 3500 Parkway Lane, Suite 500 Peachtree Corners, GA 30092 Phone (678) 336-7740 Fax (678) 336-7744	ELECTRICAL ENGINEER Pond and Company 3500 Parkway Lane, Suite 500 Peachtree Corners, GA 30092 Phone (678) 336-7740 Fax (678) 336-7744
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EGRESS PATH	
EGRESS PATH	TRAVEL DISTANCE
PATH A	50'-5 3/4"
PATH B	50'-5 3/4"

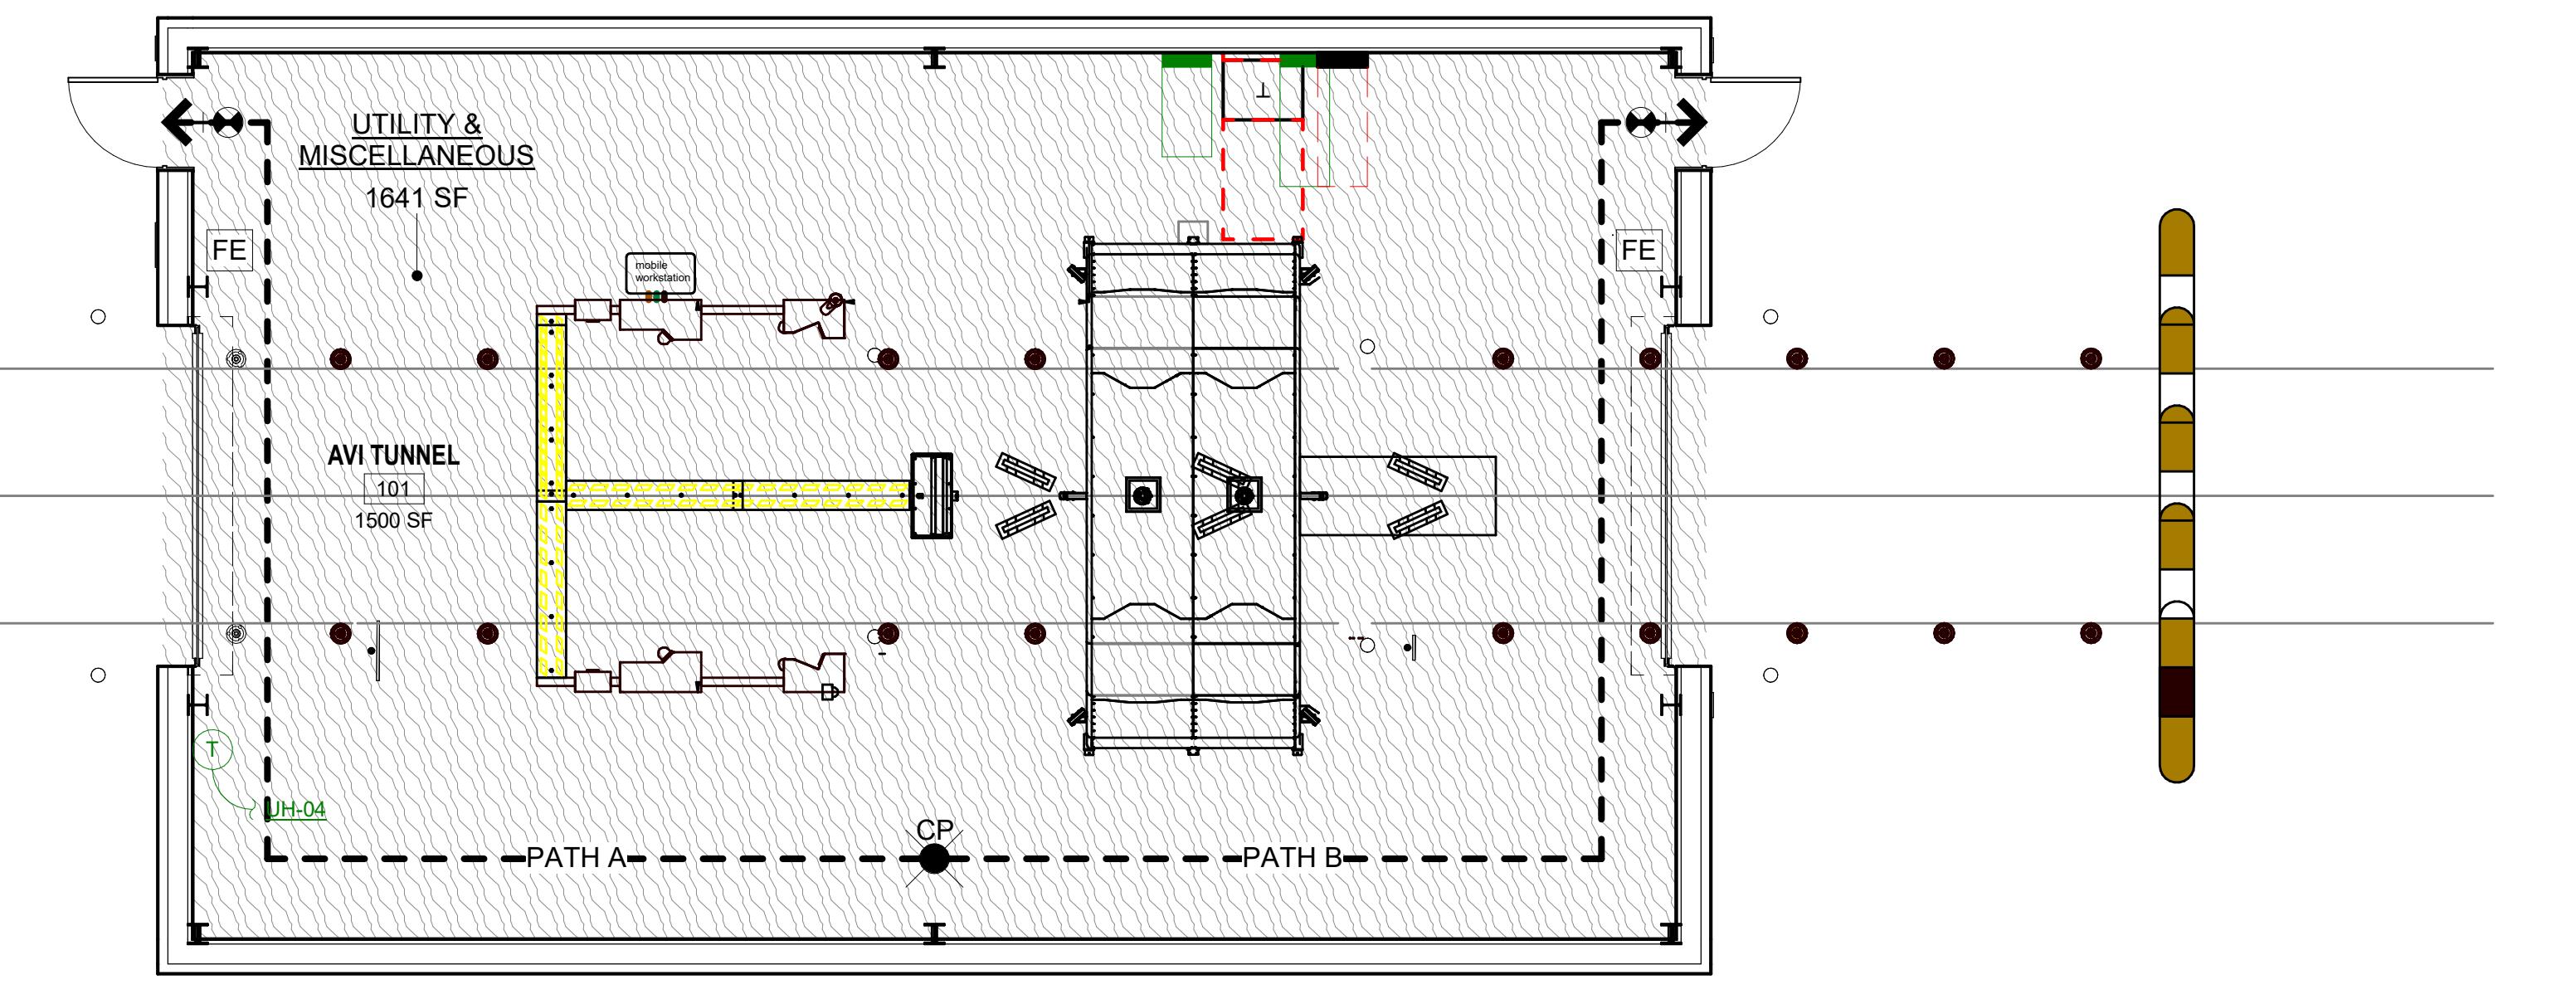

C1 LEVEL 1 - LIFE SAFETY PLAN

SCALE: 3/16" = 1'-0"

BUILDING CODE SUMMARY

NEW AUTOMATED VEHICLE INSPECTION BUILDING (AVI)

PROJECT: AMZL DKO1 AVI, LITTLETON, MASSACHUSETTS

SCOPE: CONSTRUCT NEW BUILDING FOR UNOCCUPIED AUTOMATED VEHICLE INSPECTION (AVI) EQUIPMENT.

THE PROPOSED BUILDING WILL BE CONSTRUCTED ON THE SITE OF A CURRENTLY OPERATIONAL AMAZON DELIVERY STATION. THIS BUILDING WILL HOUSE AND PROTECT NEW AUTOMATED VEHICLE INSPECTION (AVI) EQUIPMENT. UNDER ORDINARY OPERATION, THIS BUILDING WILL BE UNOCCUPIED. EXISTING PAVING, CURBS, AND OTHER SITE ELEMENTS WILL BE MODIFIED TO ACCOMMODATE THE NEW BUILDING CONSTRUCTION.

NUMBER OF STORIES: 1
TOTAL HEIGHT: 18'-0" TO RIDGE
BUILDING AREA: 1,641 SF

THIS PROJECT WAS DESIGNED IN ACCORDANCE WITH THESE APPLICABLE CODES & STANDARDS:

MASSACHUSETTS BUILDING CODE, 10TH ED. (IBC 2021, AMENDED)
MASSACHUSETTS ACCESSIBILITY CODE
MASSACHUSETTS ELECTRICAL CODE 2023 (NFPA 70, 2023 AMENDED)
MASSACHUSETTS STRETCH ENERGY CODE 2021 (IECC 2021, AMENDED)
MASSACHUSETTS MECHANICAL CODE 2021 (IMC 2021, AMENDED)
NFPA 10 STANDARD FOR PORTABLE FIRE EXTINGUISHERS 2022
2010 ADA STANDARDS

BUILDING CODE (MASSACHUSETTS BUILDING CODE ABBREVIATED 'MBC')

OCCUPANCY CLASSIFICATION (MBC) UTILITY & MISCELLANEOUS GROUP U (MBC SECTION 312)

BUILDING AREA (MBC TABLE 506.2): ALLOWABLE AREA: 8,500 GSF PROPOSED AREA: 1,641 GSF

BUILDING HEIGHT (GROUP U): ALLOWABLE HEIGHT: 40 FEET / 1 STORY (MBC SECTION 504) PROPOSED HEIGHT: 18 FEET / 1 STORY

CONSTRUCTION TYPE (MBC 602.2): TYPE II-B, UNPROTECTED NOT SPRINKLERED

FIRE RESISTIVE RATINGS: (MBC TABLE 601)

	REQUIRED	PROVIDED	STRUCTURAL FRAME	0 HR.	0 HR.	NOT SPRINKLERED
EXT. BEARING WALLS	0 HR.	0 HR.	EXT. BEARING WALLS	0 HR.	0 HR.	
INT. BEARING WALLS	0 HR.	0 HR.	INT. BEARING WALLS	0 HR.	0 HR.	
EXT. NON-BEARING WALLS AND PARTITIONS	0 HR.	0 HR.	EXT. NON-BEARING WALLS AND PARTITIONS	0 HR.	0 HR.	
INT. NON-BEARING WALLS AND PARTITIONS	0 HR.	0 HR.				
FLOOR CONSTRUCTION	0 HR.	0 HR.				
ROOF CONSTRUCTION	0 HR.	0 HR.				

PROPOSED OCCUPANT LOAD: (MBC TABLE 1004.5)

NOTE: BUILDING HAS NO FULL TIME OR PART TIME STAFFING, AND WILL TYPICALLY BE UNOCCUPIED. BUILDING CODE DOES NOT INDICATE A SPECIFIC OCCUPANCY LOAD FACTOR FOR GROUP U BUILDINGS. OCCUPANT LOAD BELOW HAS BEEN CALCULATED USING THE MOST SUITABLE EQUIVALENT, BUT WILL BE USED TO ESTABLISH EGRESS CAPACITY ONLY.

USE AREA LOAD FACTOR OCCUPANT LOAD

ACCESSORY STORAGE 1,641 GSF 300 GSF PER OCCUPANT 6

FIRE PROTECTION SYSTEMS (MBC CHAPTER 9):

AUTOMATIC SPRINKLER SYSTEM NOT REQUIRED / NOT PROVIDED
STANDPIPE SPRINKLER SYSTEM NOT REQUIRED / NOT PROVIDED
PORTABLE FIRE EXTINGUISHERS PROVIDED
FIRE ALARM AND DETECTION NOT REQUIRED / NOT PROVIDED
MASS NOTIFICATION SYSTEM NOT REQUIRED / NOT PROVIDED

FIRE EXTINGUISHERS (NFPA 10)

HAZARD LEVEL: ORDINARY (MODERATE) HAZARD

MAX. TRAVEL DISTANCE: 75 FEET TO FIRE EXTINGUISHER

OCCUPANT LOAD, PROPOSED EGRESS COMPONENT FACTOR 6 PERSONS 0.2 PER OCC.

EGRESS WIDTH REQUIRED

1.2"

COMPONENTS PROVIDED QTY. WIDTH TOTAL

SINGLE EXIT DOORS 2 32" EA. 64"

GRAND TOTAL, EGRESS WIDTH PROVIDED

64"

CAPACITY PROVIDED QTY. COMP. TOTAL

SINGLE EXIT DOORS 2 160 EA. 320

GRAND TOTAL, OCCUPANT CAPACITY PROVIDED

320

EGRESS HEIGHT (MBC 1003.3.1)

MIN. CLG. HEIGHT / HEADROOM REQUIRED 90" / 80"

HEIGHT PROVIDED 120" / 84"

NUMBER OF MEANS OF EGRESS (MBC TABLE 1006.3.3)

MIN. NUMBER REQUIRED 2

NUMBER PROVIDED 2

ARRANGEMENT OF MEANS OF EGRESS / TRAVEL DISTANCE TO EXITS (T 1017.2)

OCCUPANCY TOTAL TRAVEL COMMON PATH DEAD-END

GROUP U 300 FEET 100 FEET 20 FEET

ORDINARY HAZARD MBC (TABLE 1017.2) MBC (TABLE 1006.2.1) MBC (TABLE 1020.5)

LOCATION OF EXITS:
IN BUILDINGS NOT PROTECTED BY A SPRINKLER SYSTEM, THE MINIMUM SEPARATION DISTANCE BETWEEN TWO EXITS, EXIT ACCESSES, OR EXIT DISCHARGES SHALL BE NOT LESS THAN ONE-HALF OF THE LENGTH OF THE MAXIMUM OVERALL DIAGONAL DIMENSION OF THE BUILDING OR AREA SERVED (MBC 1007.1.1).

ALL EXITS MUST DISCHARGE DIRECTLY TO THE EXTERIOR OF THE BUILDING AT GRADE LEVEL OR PROVIDE DIRECT ACCESS TO GRADE

SHEET NOTES

1. DEVICES HAVE BEEN SHOWN; BUT THE CONTRACTOR SHALL ENSURE THE INSTALLATION OF ALL LIFE SAFETY DEVICES INDICATED ON THE ENGINEERING DRAWINGS.
2. THESE DRAWINGS SHALL BE INDICATED AS "FOR REFERENCED ONLY".
3. CONTRACTORS SHALL FOLLOW NFPA 241.
4. FIRE WALLS, FIRE BARRIERS, FIRE PARTITIONS, SMOKE BARRIERS AND SMOKE PARTITIONS OR ANY OTHER WALL REQUIRED TO HAVE PROTECTED OPENINGS OR PENETRATIONS SHALL BE EFFECTIVELY AND PERMANENTLY IDENTIFIED WITH SIGNS OR STENCILING SUCH IDENTIFICATION SHALL:
 - A. BE LOCATED WITHIN 15 FEET OF THE END OF EACH WALL AND AT INTERVALS NOT EXCEEDING 30 FEET MEASURED HORIZONTALLY ALONG WITH WALL OR PARTITION.
 - B. INCLUDE LETTERING NOT LESS THAN 3 INCHES IN HEIGHT WITH A MINIMUM 3/8-INCH STROKE IN A CONTRASTING COLOR INCORPORATING THE SUGGESTED WORDING, "FIRE AND/OR SMOKE BARRIER - PROTECT ALL OPENINGS," OR OTHER WORDING


EOR/AOR SEAL

COA SEAL

amazon

SHEET LEGEND

- 1-HR. RATED WALLS
- 2-HR. RATED WALLS
- 3-HR. RATED WALLS
- 4-HR. RATED WALLS
- SMOKE WALLS

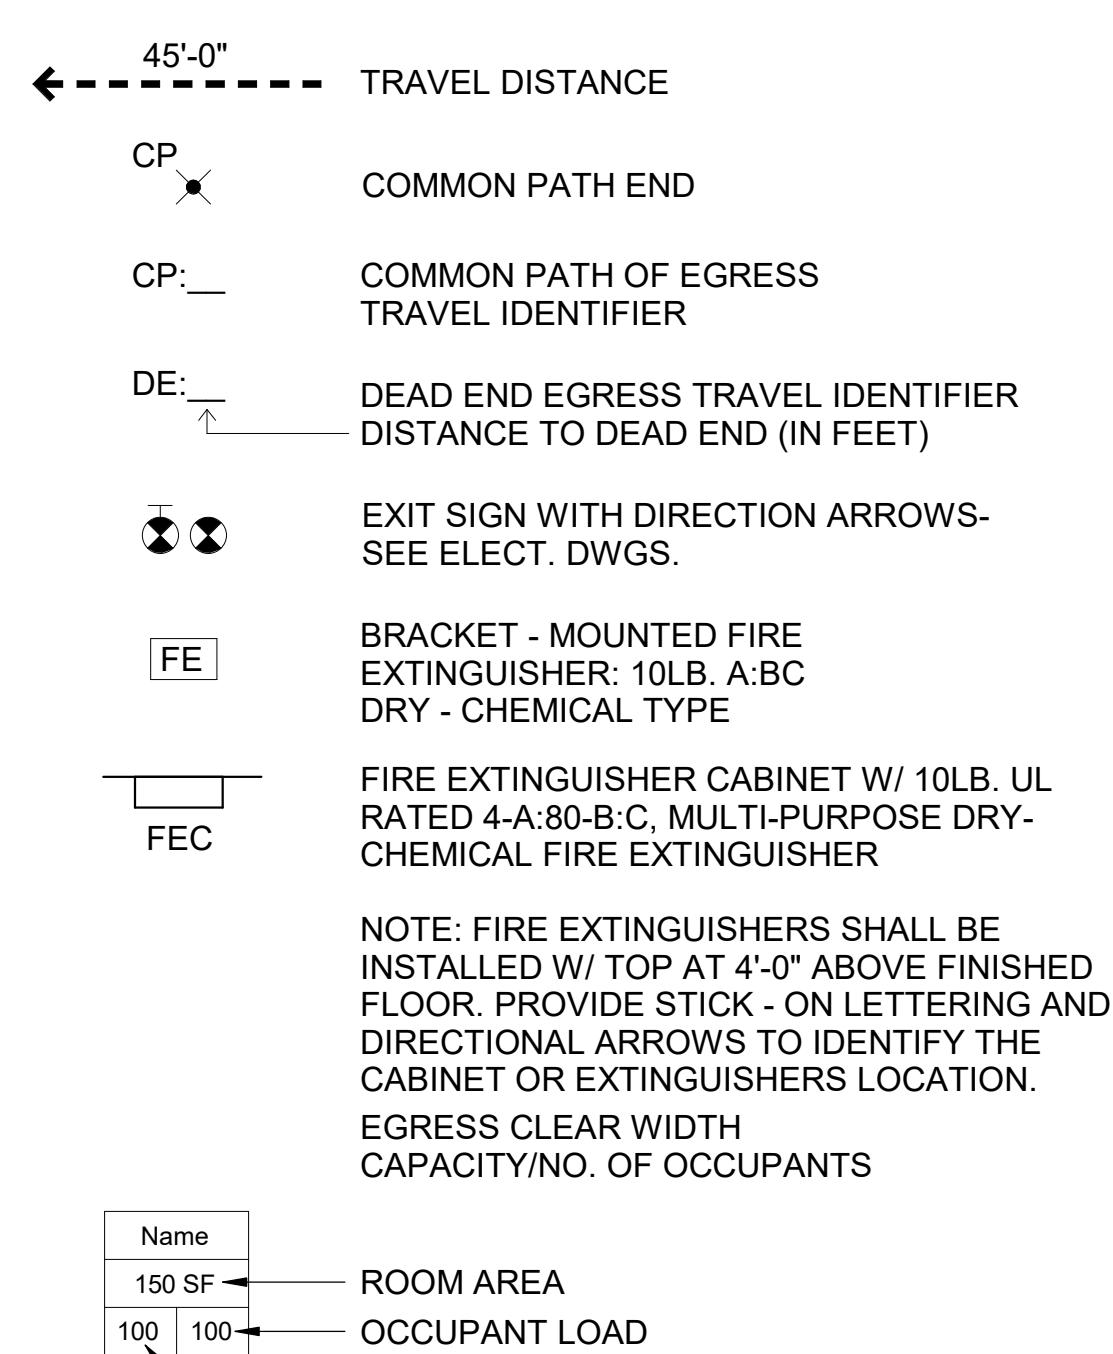

DRAWING ISSUE

2/7/2025

16/2025

OCCUPANCY LEGEND

UTILITY & MISCELLANEOUS

CD 100% FOR REVIEW
ISSUED FOR REVIEW

CD 100% FOR REVIEW

ISSUED FOR REVIEW

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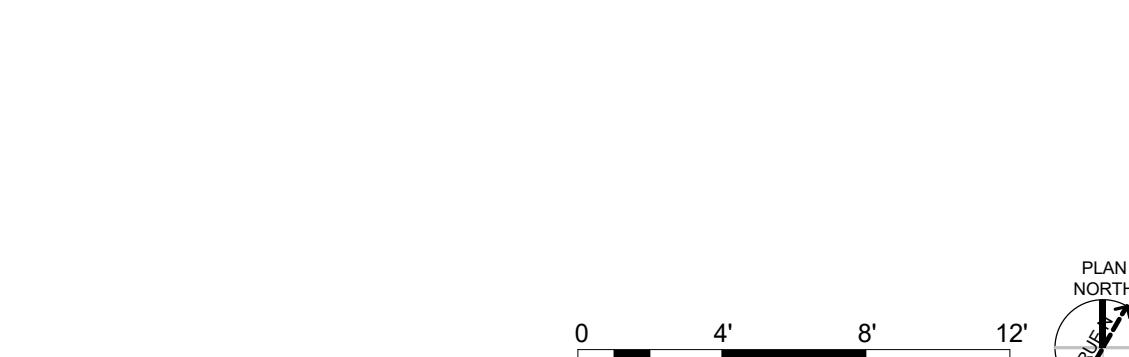
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DESIGNED BY: JOC
DRAWN BY: MA
CHECKED BY: KK
SUBMITTED BY: JAM
DATE: 2/7/2025
PROJECT #: 1240262

SHEET TITLE

CODE SUMMARY

& LIFE SAFETY PLAN

ORIGINAL SHEET SIZE:
30" X 42"

PLAN NORTH

0 4' 8' 12'

SCALE: 3/16" = 1'-0"

SHEET NAMING CONVENTION	
2 DIGIT DISCIPLINE DESIGNATOR (IF ONLY ONE LETTER IS USED, THE SECOND LETTER IS ADDED WITH A DASH "-" AS A PLACEHOLDER**)	1 DIGIT AREA DESIGNATOR (AREA DESIGNATOR ONLY USED WHEN PLANS ARE SUBDIVIDED INTO AREAS)
1 DIGIT SHEET TYPE DESIGNATOR 0-GENERAL 1-PLANS 2-ELEVATIONS 3-SECTIONS 4-DETAILED PLANS 5-DETAILS 6-VARIES 7-VARIES 8-SPECIFICATIONS 9-3D VIEWS	2 DIGIT SEQUENTIAL # (01-99) (FIRST DIGIT INDICATES PLAN TYPE, SECOND DIGIT INDICATES FLOOR)


ARCHITECTURAL GENERAL NOTES:

- THE DRAWINGS INDICATE THE GENERAL EXTENT OF WORK. THE DRAWINGS ARE NOT INTENDED TO INDICATE OR DESCRIBE ALL WORK REQUIRED FOR THE FULL PERFORMANCE AND COMPLETION OF THE REQUIREMENTS OF THE CONTRACT DOCUMENTS.
- THE ENUMERATION OF PARTICULAR ITEMS OF WORK IN ONE PORTION OF THE CONTRACT DOCUMENTS SHALL NOT BE CONSTRAINED TO EXCLUDE OTHER ITEMS NECESSARY OR IMPLIED THEREFROM.
- THE CONTRACTOR IS RESPONSIBLE FOR THE COORDINATION OF THE WORK SO THAT NO WORK SHALL BE LEFT IN AN UNFINISHED OR INCOMPLETE CONDITION.
- WORK SHALL CONFORM TO APPLICABLE INDUSTRY AND MANUFACTURER'S PUBLISHED STANDARDS FOR QUALITY OF MATERIALS AND WORKMANSHIP AS WELL AS REQUIREMENTS OF THE CONSTRUCTION DOCUMENTS. ANY CONFLICTING REQUIREMENTS OF THE SOURCES LISTED ABOVE SHALL BE BROUGHT TO THE ARCHITECT'S ATTENTION PRIOR TO PROCEEDING WITH THE WORK.
- THE CONTRACTOR SHALL PROTECT EXISTING, IN-PLACE, AND NEW WORK.
- WORK NOTED "N.I.C." IS NOT MEANT TO BE PART OF THE CONSTRUCTION SCOPE OF WORK AGREEMENT.
- THE CONTRACTOR SHALL PAY FOR AND COORDINATE THE REMOVAL AND LEGAL DISPOSAL OF MATERIALS AND RUBBISH.
- ONCE ON SITE, THE CONTRACTOR SHALL VERIFY EXISTING CONDITIONS THAT CORRESPOND TO THOSE SHOWN ON THE CONSTRUCTION DOCUMENTS. THE CONTRACTOR SHALL NOTIFY THE ARCHITECT IN WRITING OF ANY DIFFERENT CONDITIONS BEFORE COMMENCEMENT OF WORK.
- DO NOT SCALE DRAWINGS. DIMENSIONS GOVERN, LARGE SCALE DETAILS GOVERN OVER SMALL SCALE DETAILS. THE CONTRACTOR SHALL NOTIFY THE ARCHITECT IN WRITING OF ANY DIFFERENT CONDITIONS BEFORE COMMENCEMENT OF WORK.
- DIMENSIONS NOTED AS "HOLD" SHALL NOT VARY BY MORE THAN 1/8" FROM SIDE TO SIDE OR FROM FRONT TO BACK, FINISHED SURFACE TO FINISHED SURFACE.
- WALL AND/OR CEILING ASSEMBLIES THAT ARE IDENTIFIED WITH A FIRE RESISTIVE RATING SHALL BE CONSTRUCTED AS DETAILED HEREIN.
- DIMENSIONS SHOWN ARE TO FACE OF STUD OR CMU (U.N.O.).
- THE CONTRACTOR SHALL PERFORM WORK IN ACCORDANCE WITH APPLICABLE CODES, ORDINANCES AND REGULATORY AGENCIES AND SHALL OBTAIN NECESSARY BUILDING AND FIRE PERMITS FROM AUTHORITIES HAVING JURISDICTION.
- INTERIOR FINISH MATERIALS SHALL COMPLY WITH THE REQUIREMENTS OF APPLICABLE CODES, ORDINANCES AND REGULATORY AGENCIES.
- DISSIMILAR METALS SHALL BE ISOLATED FROM EACH OTHER TO AVOID GALVANIC CORROSION.
- NOTES APPEAR ON VARIOUS SHEETS FOR DIFFERENT SYSTEMS AND MATERIALS. SHEETS ARE TO BE REVIEWED AND NOTES ON INDIVIDUAL SHEETS SHALL BE APPLIED TO RELATED DRAWINGS AND DETAILS.
- A FINISH INDICATION ON A WALL SHALL MEAN THE ENTIRE LENGTH AND HEIGHT OF WALL IS TO BE FINISHED OR FIRE-RATED AS INDICATED.
- WHEN NON-DIMENSIONED PARTITIONS APPEAR IN CONJUNCTION WITH DOOR OPENINGS, THE DOOR WIDTH AND THE DOOR FRAME DETAILS DETERMINE THE LOCATION OF ADJACENT WALLS AND FRAMES.
- DETAILS NOT SHOWN ARE SIMILAR IN CHARACTER TO THOSE DETAILED, WHERE SPECIFIC DIMENSIONS, DETAILS OR DESIGN INTENT CANNOT BE DETERMINED. CONSULT THE ARCHITECT BEFORE PROCEEDING WITH THE WORK.
- THE CONTRACTOR SHALL COORDINATE MECHANICAL AND ELECTRICAL FLOOR AND WALL SLEEVES INCLUDING CONDUITS WITH MECHANICAL, ELECTRICAL, PLUMBING, FIRE PROTECTION, STRUCTURAL AND ARCHITECTURAL DRAWINGS.
- PROVIDE ACCESS PANELS AS REQUIRED BY APPLICABLE CODES AND AS REQUIRED FOR MECHANICAL EQUIPMENT AND PLUMBING WORK. ACCESS PANELS SHALL BE CONCEALED AND LOCATIONS SHALL BE REVIEWED WITH THE ARCHITECT PRIOR TO PROCEEDING.
- PIPE DUCTS AND BUS DUCTS THAT PENETRATE FLOOR SLABS OR WALL PARTITIONS SHALL BE INSTALLED IN A MANNER THAT WILL PRESERVE THE MOISTURE RESISTIVENESS, FIRE RATING, AND STRUCTURAL INTEGRITY OF THE BUILDING.
- DO NOT CUT INTO, REMOVE OR ALTER ANY STRUCTURAL MEMBER OR PORTION OF THE FLOOR SYSTEM UNLESS IT IS SPECIFICALLY NOTED OR SHOWN ON THE STRUCTURAL DRAWINGS.
- PROVIDE EXPANSION AND CONTROL JOINTS IN WORK AS PER PRODUCT MANUFACTURER'S STANDARDS.
- INTERIOR PARTITION MOVEMENT CONTROL:
 - VERTICAL CONTROL JOINTS FOR ANY WALL LENGTH ARE TO OCCUR AT NOT MORE THAN 30'-0" O.C. IN THE HORIZONTAL DIRECTION, UNLESS NOTED OTHERWISE.
 - PROVISIONS SHALL BE MADE IN THE DESIGN, FABRICATION, AND INSTALLATION OF INTERIOR PARTITIONS FOR TYPICAL FLOOR DEFLECTIONS OF THE STRUCTURE UNDER SUPERIMPOSED LOADS AS FOLLOWS:
 - TYPICAL ROOF/FLOOR MEMBERS: SPAN/360 BUT NOT LESS THAN 1/2".
- THE CONTRACTOR SHALL PLAN HIS/HER WORK TO PROVIDE ADEQUATE PROTECTION FOR PERSONS AND PROPERTY AT ALL TIMES, AND EXECUTE THE WORK IN SUCH A MANNER TO AVOID ANY HAZARD TO PERSONS AND PROPERTY AS NECESSARY.
- THE CONTRACTOR SHALL COORDINATE THE PHASING OF THE WORK TO BE PERFORMED IN OR ABOUT EXISTING FACILITIES, IF APPLICABLE, WITH THE OWNER PRIOR TO START OF SUCH WORK.


ARCHITECTURAL ABBREVIATIONS:

AFF	ABOVE FINISHED FLOOR	FDN	FOUNDATION	PL	PLATE
ADAAG	AMERICAN W/ DISABILITIES ACCESSIBILITY GUIDELINES	GA	GALVANIZED	PLMB	PLUMBING
ADJ	ADJUSTABLE	GALV	GOVERNMENT FURNISHED	PLYWD.	PLYWOOD
ACT	ACOUSTICAL CEILING TILE	GCFI	CONTRACTOR INSTALLED	PTC	PORCELAIN TILE
ANOD	ANODIZED	GFGI	GOVERNMENT FURNISHED	LBS. OR #	POUNDS
AL / ALUM.	ALUMINUM	GOVT	GOVERNMENT INSTALLED	PSF	SQUARE FOOT
APPROX	APPROXIMATE	GYP	GOVERNMENT GLAZING	PSI	SQUARE INCH
AR/ARCH	ARCHITECTURAL	GYPSUM	GOVERNMENT	PEMB	PREF-ENGINEERED
AT / FP	ANTI TERRORISM / FORCE PROTECTION	GWB	GYPSUM WALL BOARD	PRE-FAB	METAL BUILDING
AVG	AVERAGE	HDW	HARDWARE	Q.T.	QUARRY TILE
A / V	AUDIO/VISUAL	HGT	HEIGHT	RAF	RAISED ACCESS FLOOR
BLKG	BLOCKING	HM	HOLLOW METAL	RCPT	RECEPTIONIST / RECEPTION
BD	BOARD	HORIZ	HORIZONTAL	REF	REFERENCE
BTM	BOTTOM	HB	HOSE BIBB	REINF	REINFORCEMENT /
B / O	BOTTOM OF BUILDING	HVAC	HEATING VENTILATION & AIR CONDITIONING	REQ'D	REQUIRED
BLDG	CONTRACTOR FURNISHED	IMP	INSULATED METAL PANEL	REV	REVISIONS / REVISED
CFCI	COLD FORMED METAL FRAMING	INSUL	INSULATION	R / D	ROOF DRAIN
CLG	CARPET	INT	INTERIOR	RH	RIGHT HAND
CLG HT	CEILING	JAN	JANITOR	RHR	RIGHT HAND REVERSE
CTR	CEILING HEIGHT	JC	JANITOR'S CLOSET	RM	ROOM
	CENTER	JT	JOINT	RO	ROUGH OPENING
	CENTER LINE	KP	KICK PLATE	RB	RUBBER BASE
CT	CERAMIC TILE	LAM	LAMINATE	SG	SAFETY GLASS / GLAZING
CLR	CLEAR	LDG	LANDING	SC	SEALED CONCRETE
CO	CLEANOUT	LAV	LAVATORY	SCHED	SCHEDULE
COL	COLUMN	LH	LEFT HAND	SECT	SECTION
CONC	CONCRETE	LHR	LEFT HAND REVERSE	SSK	SERVICE SINK
CORR	CORRIDOR	LGT	LENGTH	SIM	SIMILAR
CMU	CONCRETE MASONRY UNIT	LT	LIGHT	STC	SOUND TRANSMISSION CLASS
CONF	CONFERENCE	LTG	LIGHTING	SPEC(S)	SPECIFICATION
CONST	CONSTRUCTION	LONG	LONGITUDINAL	SFRM	SPRAYED FIRE RESISTIVE MATERIAL
CONT	CONTINUOUS	LVR	LOUVER	SQ	SQUARE
CONTR	CONTRACTOR	L/V	LOW VOLTAGE	ST	STAIN
CJ	CONTROL JOINT	MAS	MASONRY	S.S.	STAINLESS STEEL
CY	CUBIC YARD	MO	MASONRY OPENING	STD	STANDARD
DET	DETAIL	MGR	MANAGER	STR	STRUCTURAL
DIA	DIA	MANUF	MANUFACTURER	SUSP	SUSPENDED
DIM	DIMENSION	MATL	MATERIAL	TELECOMM	TELECOMMUNICATIONS
DISP	DISPENSER	MAX	MAXIMUM	TEL	TELEPHONE
DN	DOWN	MECH	MECHANICAL	THK	THICK / THICKNESS
DESC	DOWNSPOUT	MTL	METAL	TLT	TOILET
DWG	DRAWING	MWP	METAL WALL PANEL	T/O	TOP OF
EA	EACH	MB	MILBUND	TYP	Typical
ELEC	ELECTRICAL OR ELECTRIC	MIN	MINIMUM	U.L.	UNDERWRITERS LABORATORIES
EL	ELEVATION	MIR	MIRROR	UNFIN	UNFINISHED
EWC	ELECTRIC WATER COOLER	MISC	MISCELLANEOUS	U.N.O.	UNLESS NOTED OTHERWISE
EP	EPoxy PAINT	N.I.C.	NOT IN CONTRACT	VERT	VERTICAL
ENGR	ENGINEER	NO. (#)	NUMBER	VEST	VESTIBULE
EOS	EDGE OF SLAB	NTS	NOT TO SCALE	VCT	VINYL COMPOSITION TILE
EQUIP	EQUIPMENT	NFPA	NATIONAL FIRE PROTECTION ASSOCIATION	VCB	VINYL COVE BASE
EQ	EQUAL	O.C.	ON CENTER	WDT	WIDTH
EXIST	EXISTING	OFCL	OWNER FURNISHED	W/	WITH
EXP	EXPOSED	OFGI	CONTRACTOR INSTALLED	WC	WATER CLOSET
EXP ST	EXPANSION JOINT EXPOSED TO STRUCTURE	OWNER FURNISHED	GOVERNMENT INSTALLED	WD	WOOD
EXT	EXTERIOR	O.H.	OPPOSITE HAND	WDW	WINDOW
FDC	FIRE DEPARTMENT CONNECTION	OPNG	OPENING	W/O	WITHOUT
FT	FEET	OPP	OPPOSITE	WRGB	WATER RESISTANT GYPSUM BOARD
FV	FIELD VERIFY	O.D.	OUTSIDE DIAMETER	YD	YARD
FIN	FINISH	OSHA	occupational safety and health act		
FF	FINISHED FLOOR	OVID / OH	OVERHEAD		
FE	FIRE EXTINGUISHER	O/D	OVERFLOW DRAIN		
FEC	FIRE EXTINGUISHER CABINET	PT / PNT	PAINT		
FP	FIRE PROTECTION	PR	PAIR		
FLR	FLOOR	PNL	PANEL		
FD	FLOOR DRAIN	PART	PARTITION		
F / O	FACE OF FOOTING	PLAS	PLASTIC		
FTG		PLAM	PLASTIC LAMINATE		




SYMBOLS:

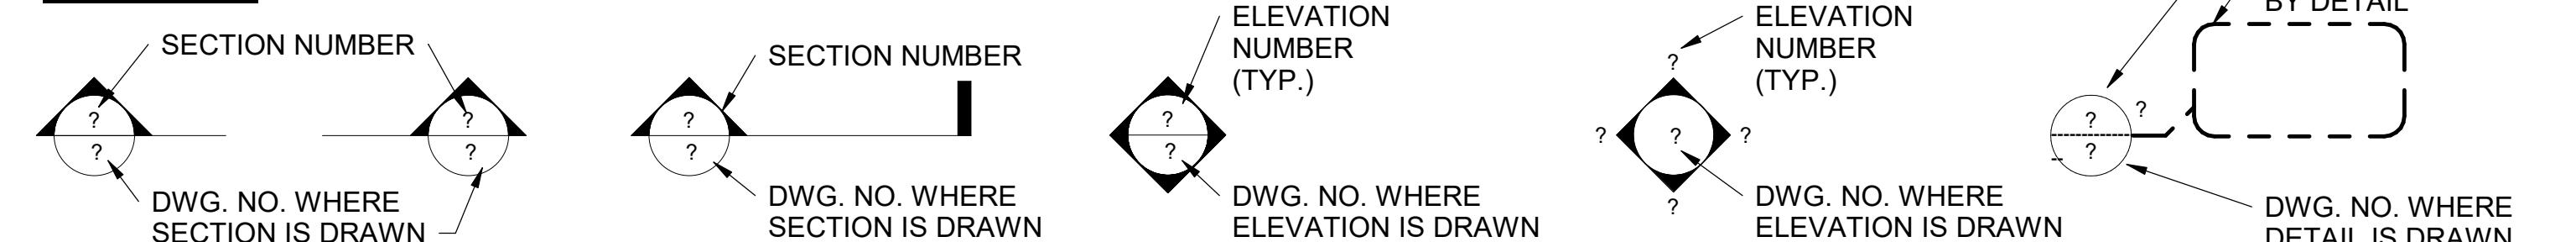

PLAN SYMBOLS:

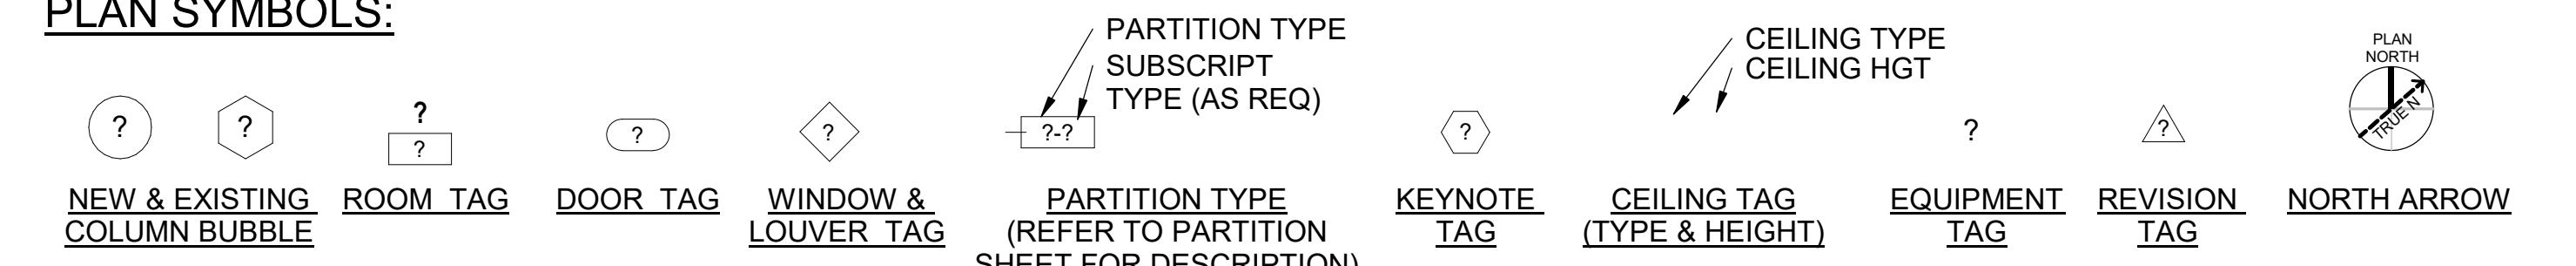

VIEW TITLES:

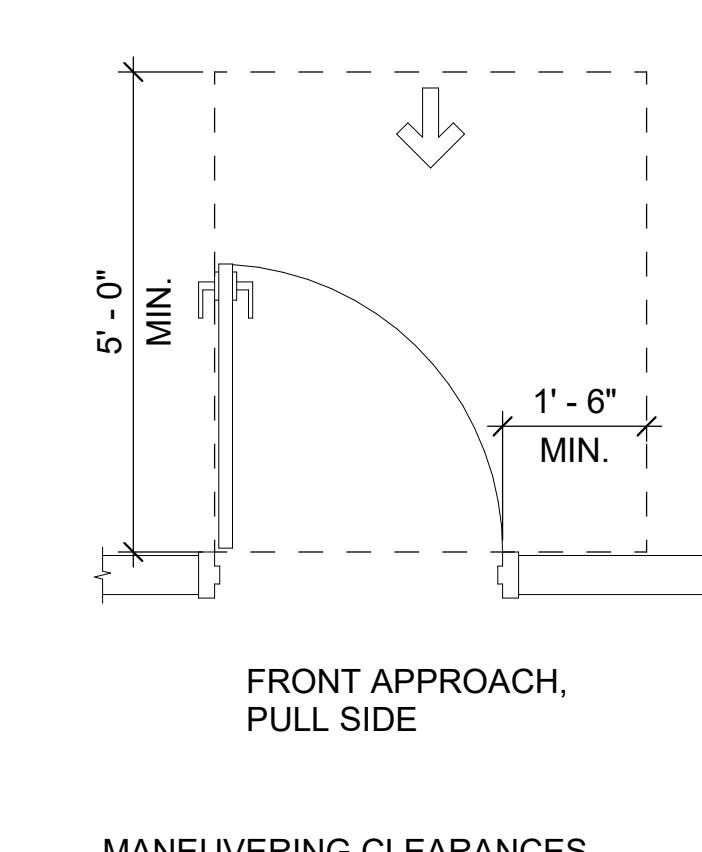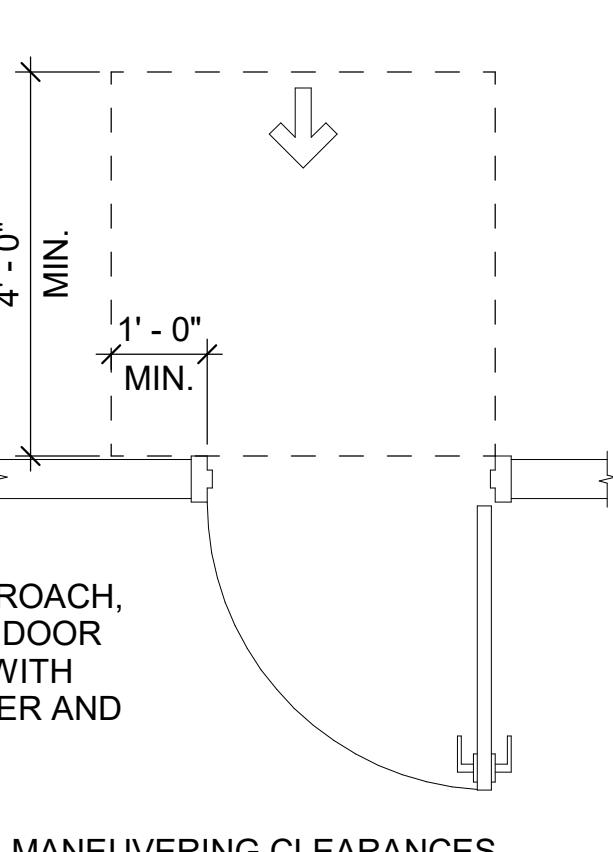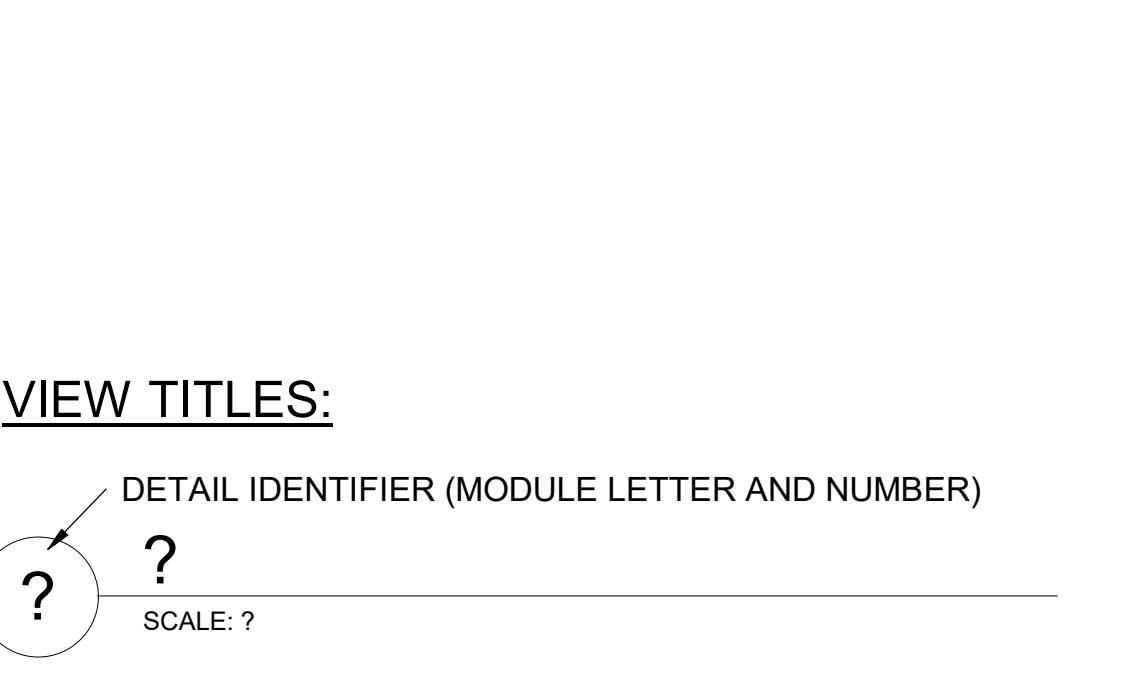

"INTERNATIONAL SYMBOL OF ACCESSIBILITY"

SCALE: 1/2" = 1'-0"

NOTES:

- THE ACCESSIBLE CRITERIA INDICATED ON THIS SHEET ARE IN COMPLIANCE WITH THE ADA STANDARDS FOR ACCESSIBLE DESIGN (2010).
- DETAILS ON THIS SHEET INDICATING ACCESSIBLE REQUIREMENTS ARE MARKED WITH THE "INTERNATIONAL SYMBOL OF ACCESSIBILITY".
- THIS SHEET IS FOR REFERENCE ONLY. CONTRACTOR TO INFORM ARCHITECT OF ANY DISCREPANCY WITH OTHER DRAWINGS PRIOR TO INSTALLATION.

SHEET NOTES

- SEE SHEET A-001 FOR GENERAL NOTES.
- SEE SHEET A-001 FOR DOOR SCHEDULE AND TYPES.
- DIMENSIONS OF EXTERIOR WALLS ARE TO INSIDE FACE OF CMU OR EXTERIOR FINISH FACE U.N.O.
- DIMENSIONS OF INTERIOR WALLS AND PARTITIONS ARE TO FACE OF STUD, FACE OF CMU OR FACE OF IMP U.N.O.
- DOOR OPENINGS SHALL BE LOCATED @ 8' FROM FACE OF ADJACENT PARTITION IN CMU PARTITIONS OR 5' FROM FACE OF PARTITION IN STUD AND PANEL PARTITIONS, U.N.O.
- CONTRACTOR SHALL LOCATE BLOCKING AND BACKING AS REQUIRED FOR WALL MOUNTED EQUIPMENT, CASEWORK/MILLWORK AND FURNISHINGS.
- UVEYE EQUIPMENT SHALL BE PROVIDED BY OWNER.
- DO NOT SCALE DRAWINGS FOR INFORMATION.
- INSTALL ALL WORK PLUMB, LEVEL, SQUARE AND TRUE, AND IN PROPER ALIGNMENT UNLESS NOTED OTHERWISE.
- DOOR ROUGH OPENINGS WITHOUT LOCATION DIMENSIONS OR DETAILS SHALL BE LOCATED 4' FROM ADJACENT WALL AT HINGE SIDE OF DOOR, OR CENTERED BETWEEN WALLS.
- DIMENSIONS MARKED "CLR" ARE MEASURED FROM FINISH SURFACE TO FINISH SURFACE. DIMENSIONS WITH THIS MARK TAKE PRIORITY OVER ADJACENT DIMENSIONS.
- G.C. SHALL BE RESPONSIBLE FOR PROVIDING BLOCKING AND/OR STRAPPING FOR ALL WALL AND CEILING MOUNTED ITEMS. PROVIDE FIRE-RETARDANT-TREATED BLOCKING AS REQUIRED BY CODE OR AHJ.
- ALL PENETRATIONS AND VOIDS THROUGH FIRE-RATED ASSEMBLIES SHALL BE FIRE STOPPED WITH APPROVED MATERIALS.
- INSTALL FIRE EXTINGUISHER(S) MOUNTED AND LOCATED TO COMPLY WITH THE REQUIREMENTS AS SET FORTH IN THE CURRENT STANDARD EDITION OF NFPA-10.
- WATERPROOFING PRODUCTS AND INSTALLATION SHALL BE SUITABLE FOR THEIR INTENDED PURPOSES.
- SEE AMZL WWBD SIGNAGE STANDARD FOR SIGNAGE TYPES AND REQUIREMENTS.

KEYNOTES

3 LINE OF 20-FOOT WIDE x 50-FOOT LONG HEATED SLAB FOR SNOWMELT REMOVAL
102 PRE-FINISHED GALVANIZED STEEL DOWNSPOUT
103 PRE-FINISHED GALVANIZED STEEL GUTTER
105 INSULATED METAL ROOF PANEL
153 INSULATED METAL WALL PANEL
201 PRE-ENGINEERED METAL BUILDING STRUCTURAL FRAME
251 OVERHEAD COOLING DOOR, MANUALLY OPERATED
252 HOLLOW METAL PERSONNEL DOOR / FRAME
301 6" DIAMETER CONCRETE FILLED, SCHEDULE 40 STEEL PIPE BOLLARD, 7'-0" LONG W/ 3'-0" EMBEDMENT INTO CONCRETE FOOTING. BOLLARD TO EXTEND 4'-0" ABOVE FINISH FLOOR/PAVING. FILL BOLLARDS WITH 3,000 PSI CONCRETE AND FORM TOP WITH SMOOTH ROUNDED CONVEX SURFACE. PRIME AND PAINT SAFETY YELLOW.
303 A-SAFE 33" IFLEX BOLLARD
351 UVEYE EQUIPMENT SHOWN FOR REFERENCE
352 FIRE EXTINGUISHER
353 FLEXIBLE LANE POLES FOIO
452 LIGHTING FIXTURE - SEE ELECTRICAL DRAWINGS.
456 EXIT SIGN - SEE ELECTRICAL DRAWINGS.
457 SPEED BUMP - BY OTHERS

SHEET LEGEND

■ 2' x 2' PENDANT EMERGENCY FIXTURE
○ WALL MOUNTED EXIT SIGN
● WALL PACK LIGHT FIXTURE
+ LAD WALL MOUNTED FAÇADE LIGHTING

FINISH SCHEDULE


ROOM NO.	ROOM NAME	FLOOR	WALLS				CEILING
			MAT.	BASE	NORTH	EAST	
101	AVI TUNNEL	SC	N/A		EXP. STRUCT. PT-101	EXP. STRUCT. PT-101	EXP. STRUCT. PT-101

EQUIPMENT SCHEDULE

EQUIPMENT NAME	PROVIDED BY	INSTALLED BY
FLEXIBLE LANE DELINEATORS	BY OTHERS	BY OTHERS
SPEED BUMP	BY G.C.	BY G.C.
AVI SCANNING EQUIPMENT	BY OTHERS	BY OTHERS
FLOOR-MTD CABLE PROTECTION MATS	BY OTHERS	BY OTHERS
UVEYE SERVER STACK	BY OTHERS	BY OTHERS
ATLAS CONTROL CABINET	BY OTHERS	BY OTHERS
33" IFLEX BOLLARDS	BY G.C.	BY OTHERS


FINISH LEGEND

CONCRETE FLOORS
SC-1 SEALED CONCRETE
MP-1 INSULATED METAL WALL PANELS, FINISH AS SHOWN ON ELEVATIONS.
RP-1 INSULATED METAL ROOF PANELS, FINISH TO MACTH PT-2.
PAINT & COATINGS
EXTERIOR PAINT
PT-1 SW 7063 NEBULOUS WHITE
PT-2 SW 7066 GRAY MATTERS
PT-3 TO MATCH PANTONE 2995C
PT-4 SW 7650 ELLIE GRAY
INTERIOR PAINT
PT-101 BENJAMIN MOORE, CHANTILLY LACE, EGGSHELL, 2121-70

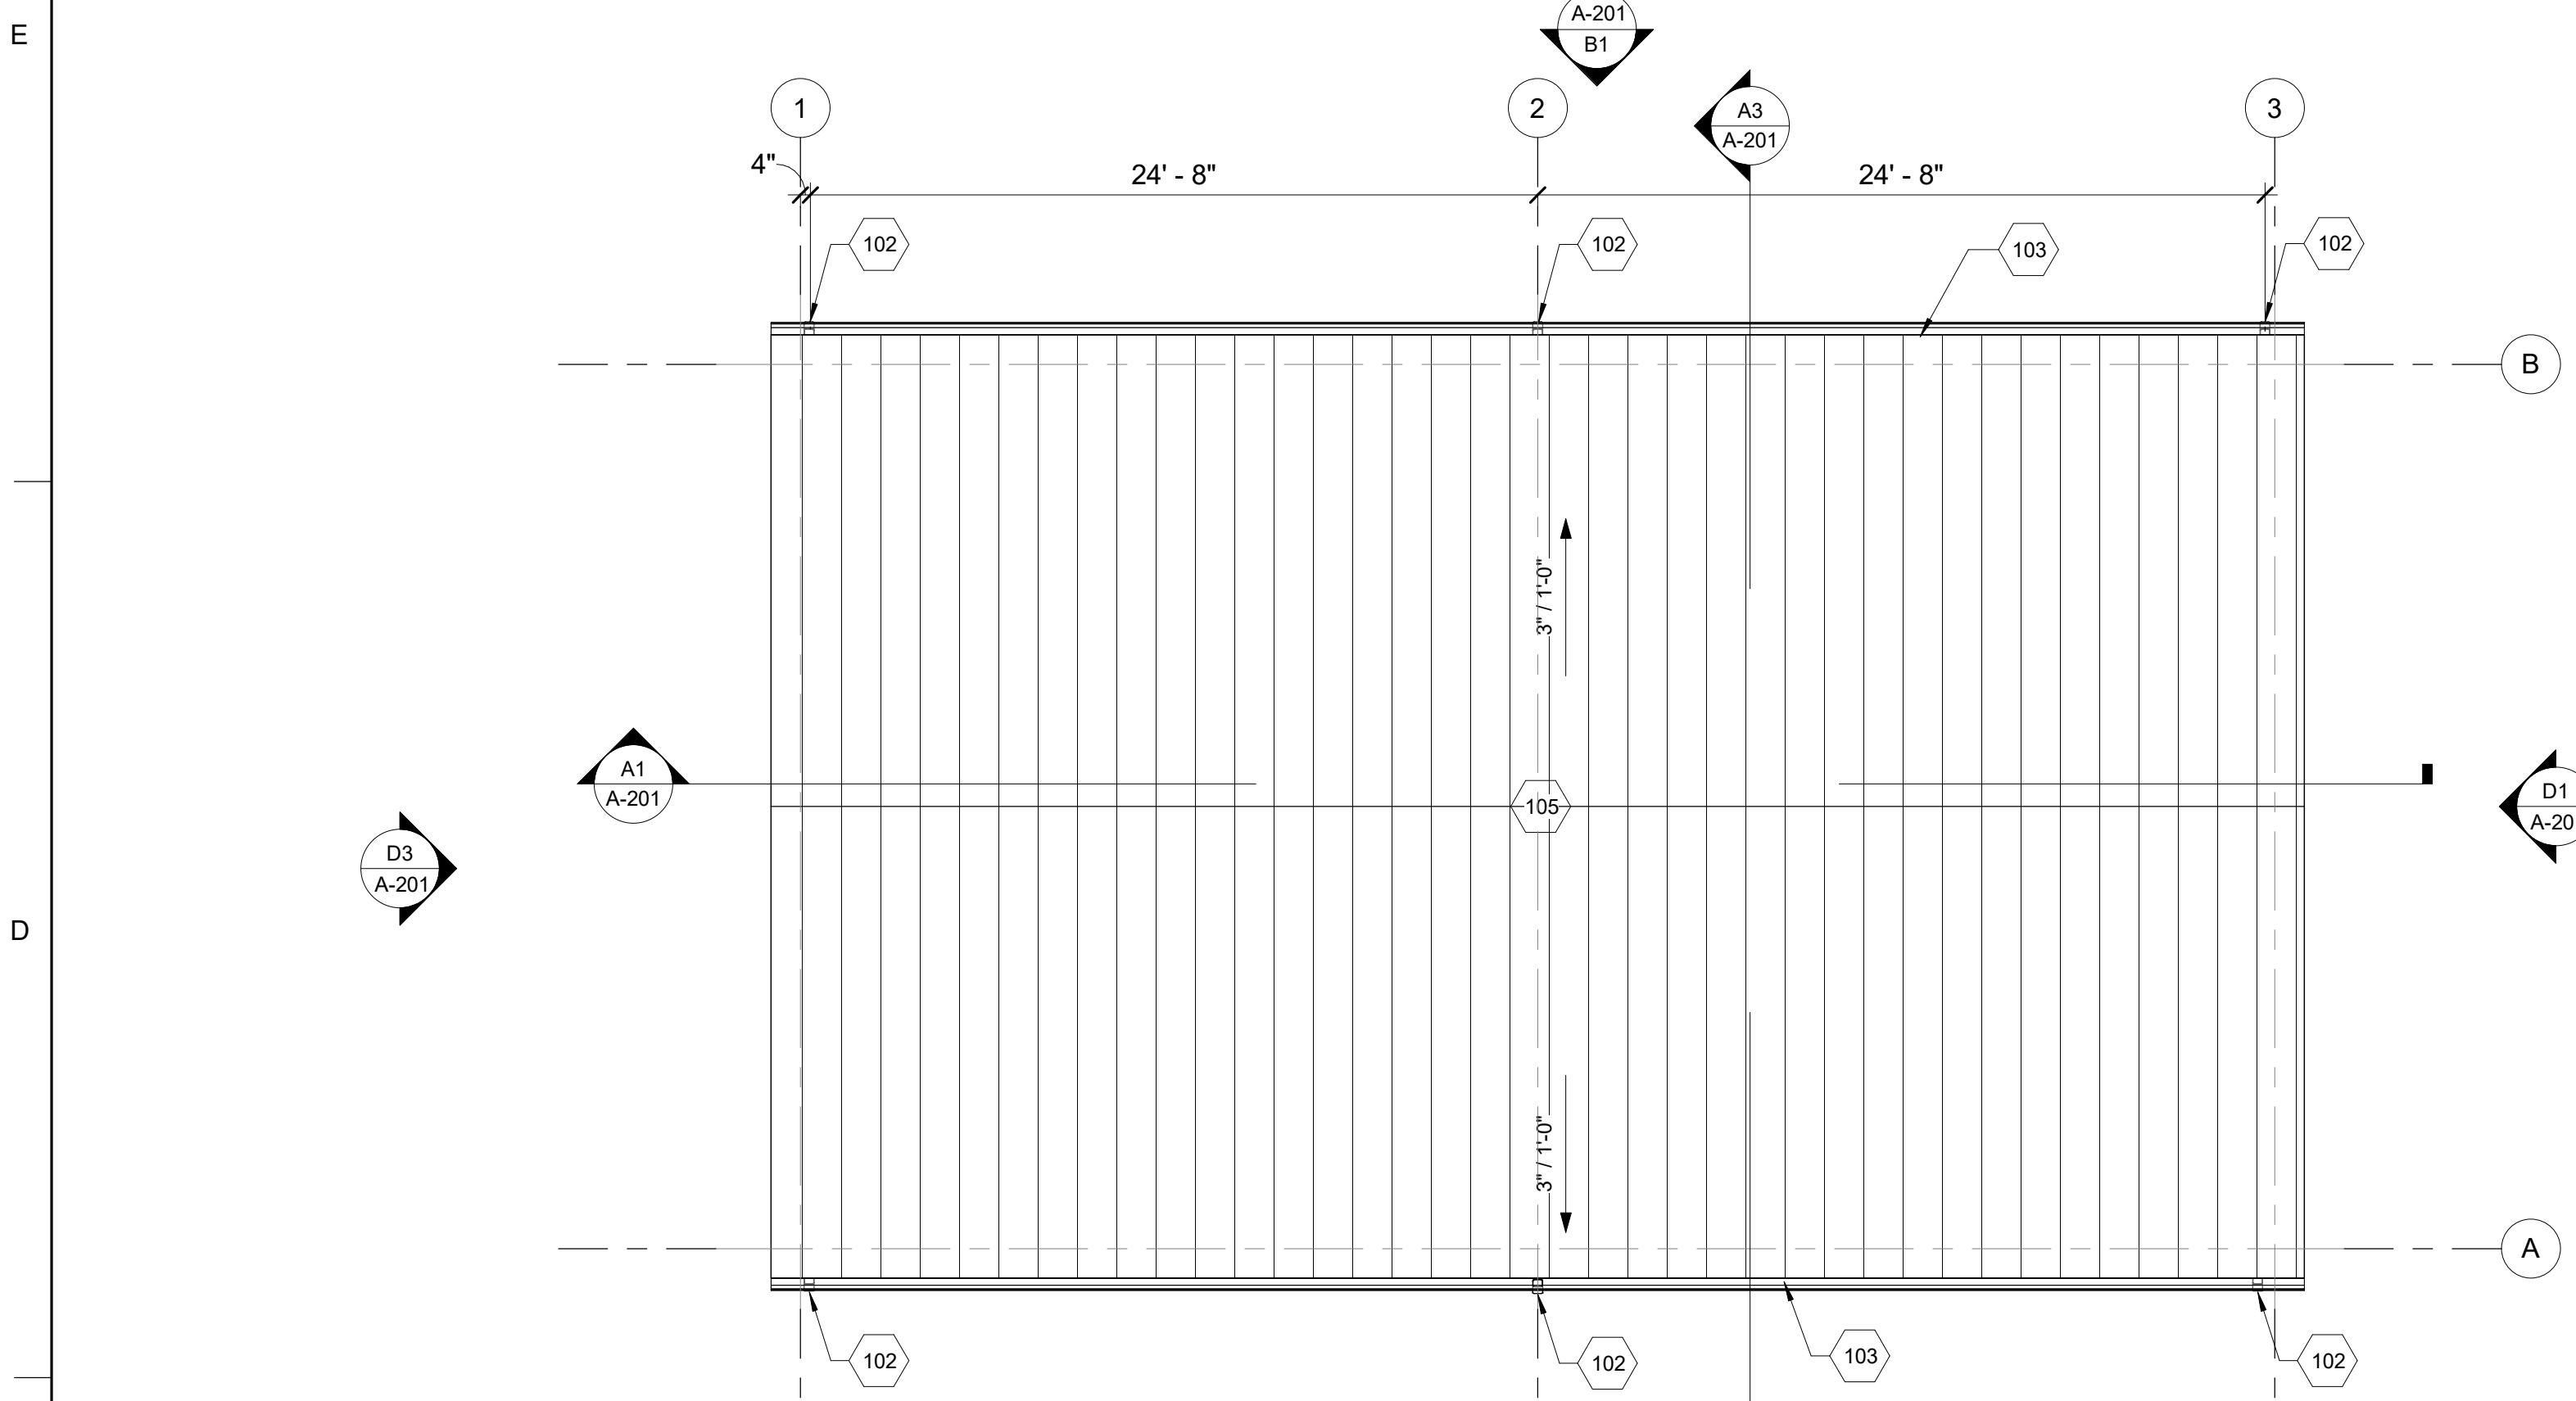FLOOR AND
REFLECTED
CEILING PLANS


C1 ROOF PLAN

SCALE: 3/16" = 1'-0"

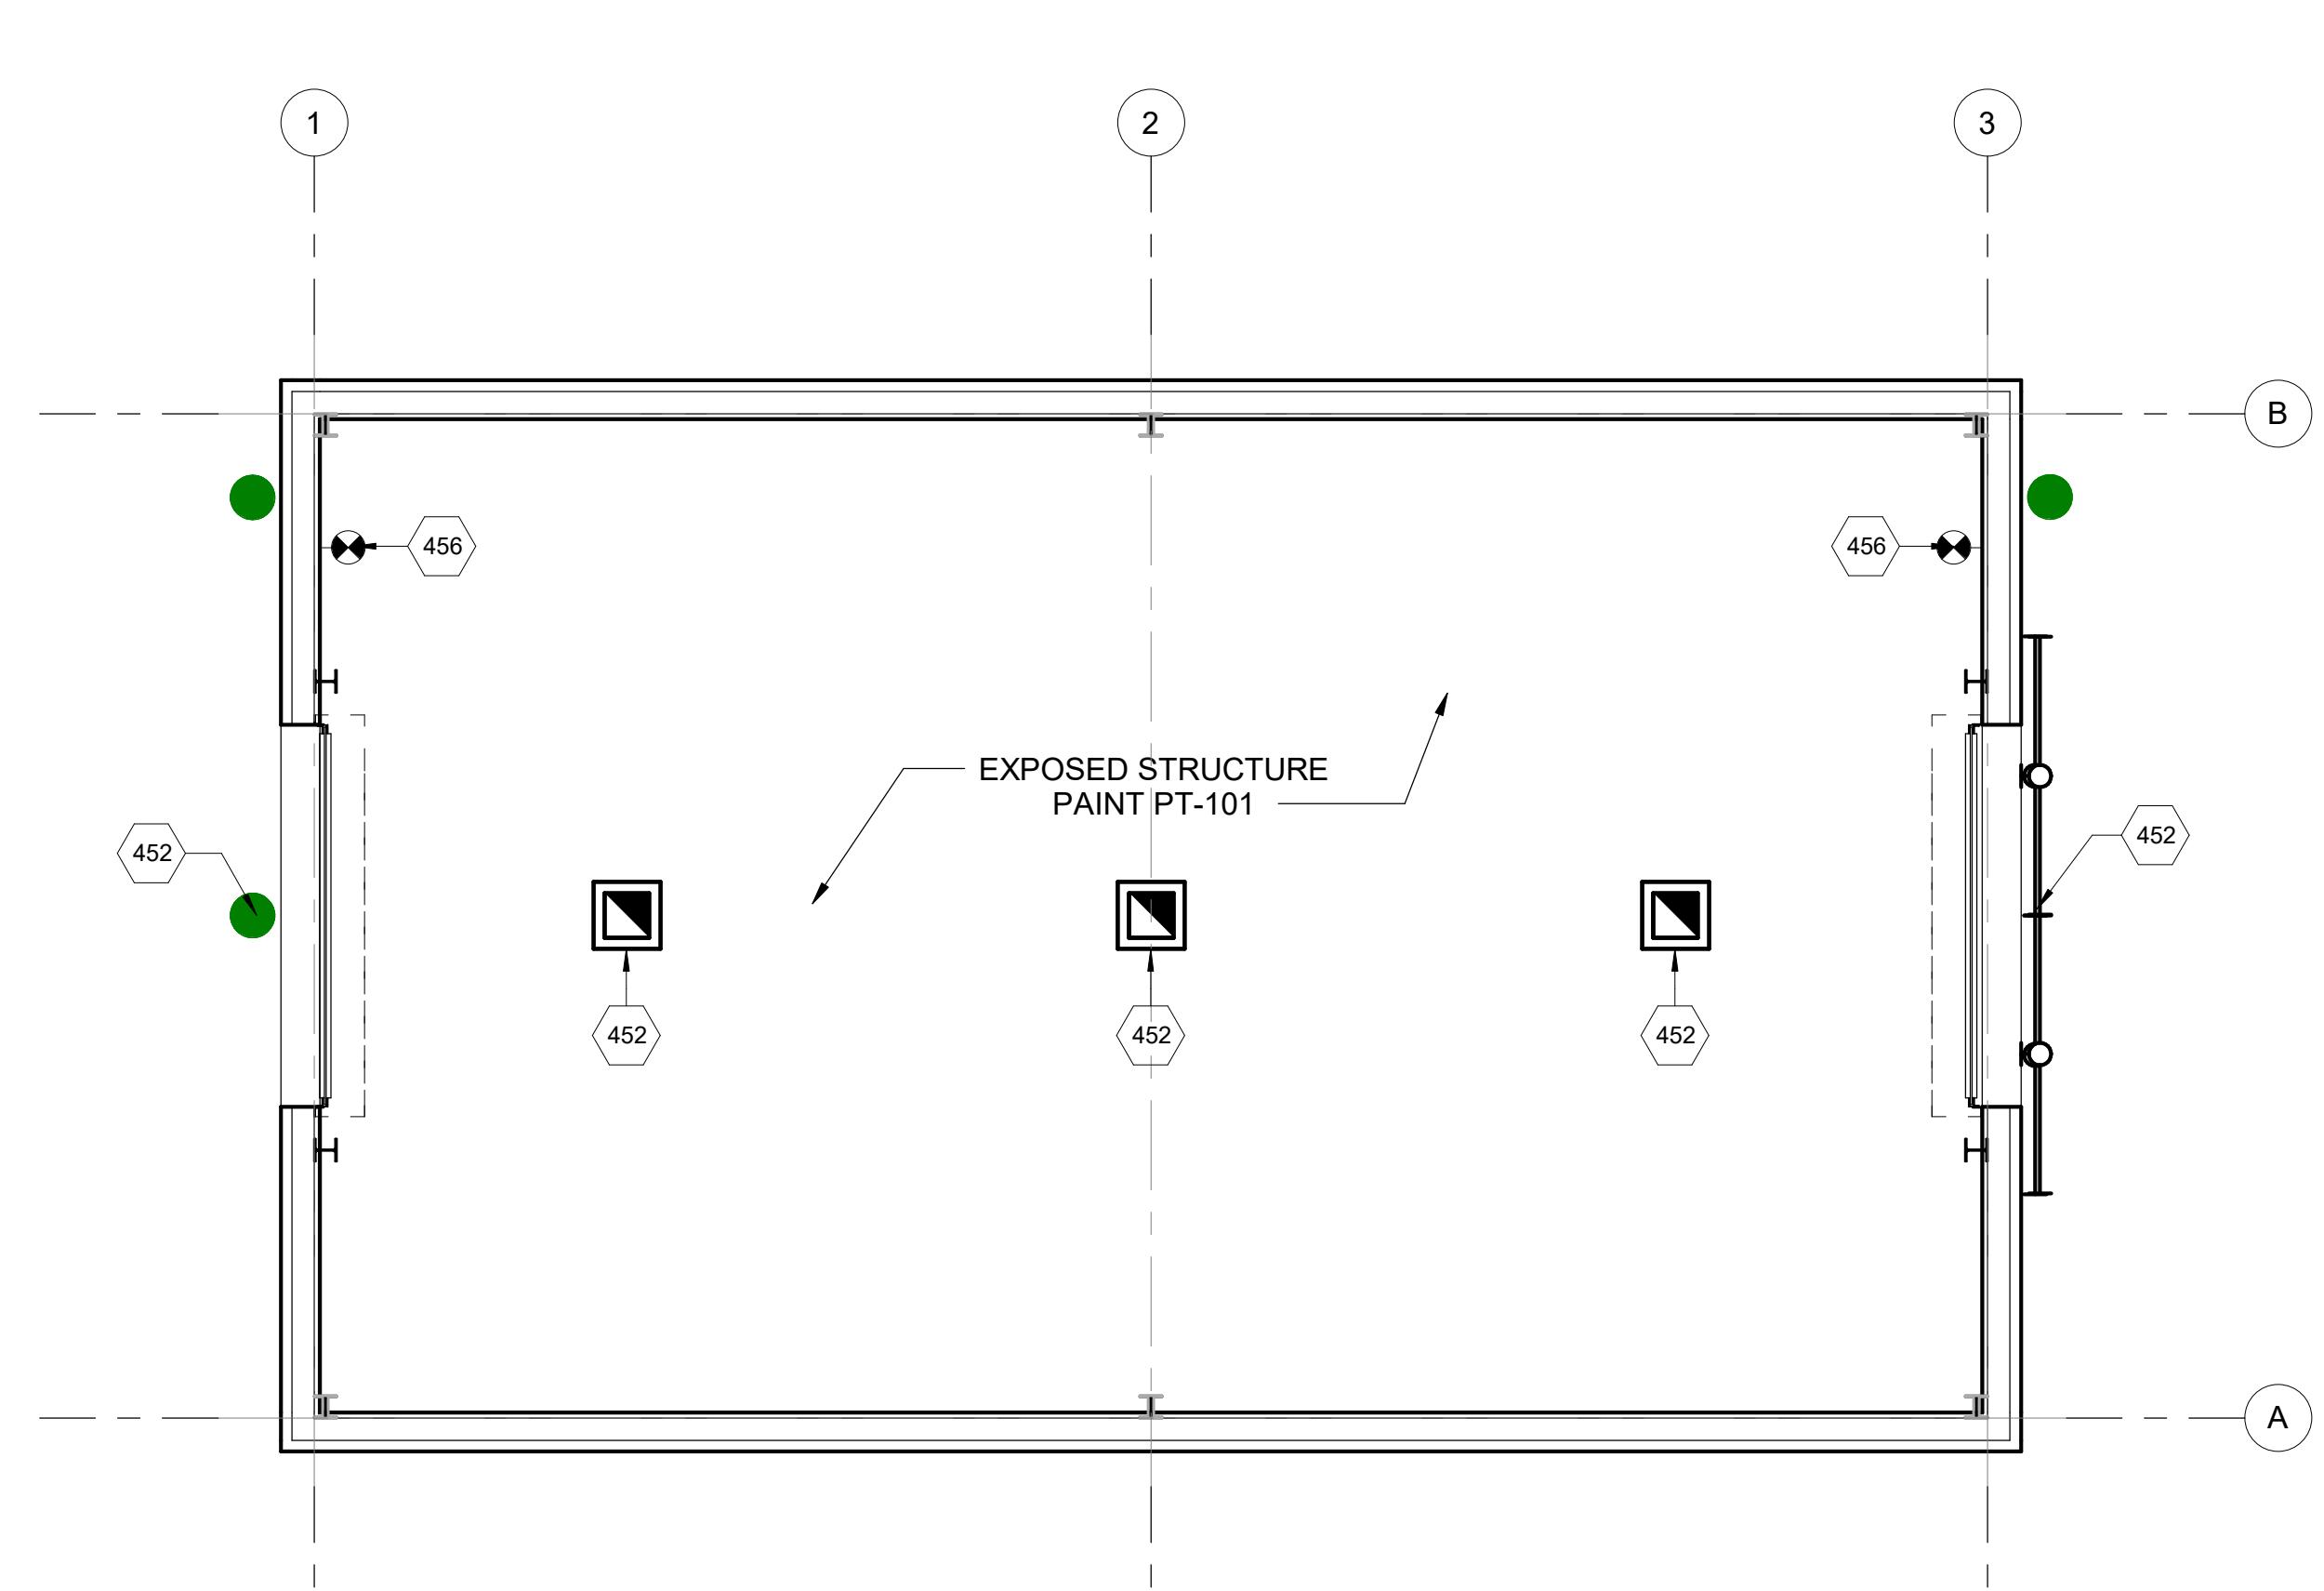


C3 REFLECTED CEILING PLAN

SCALE: 3/16" = 1'-0"


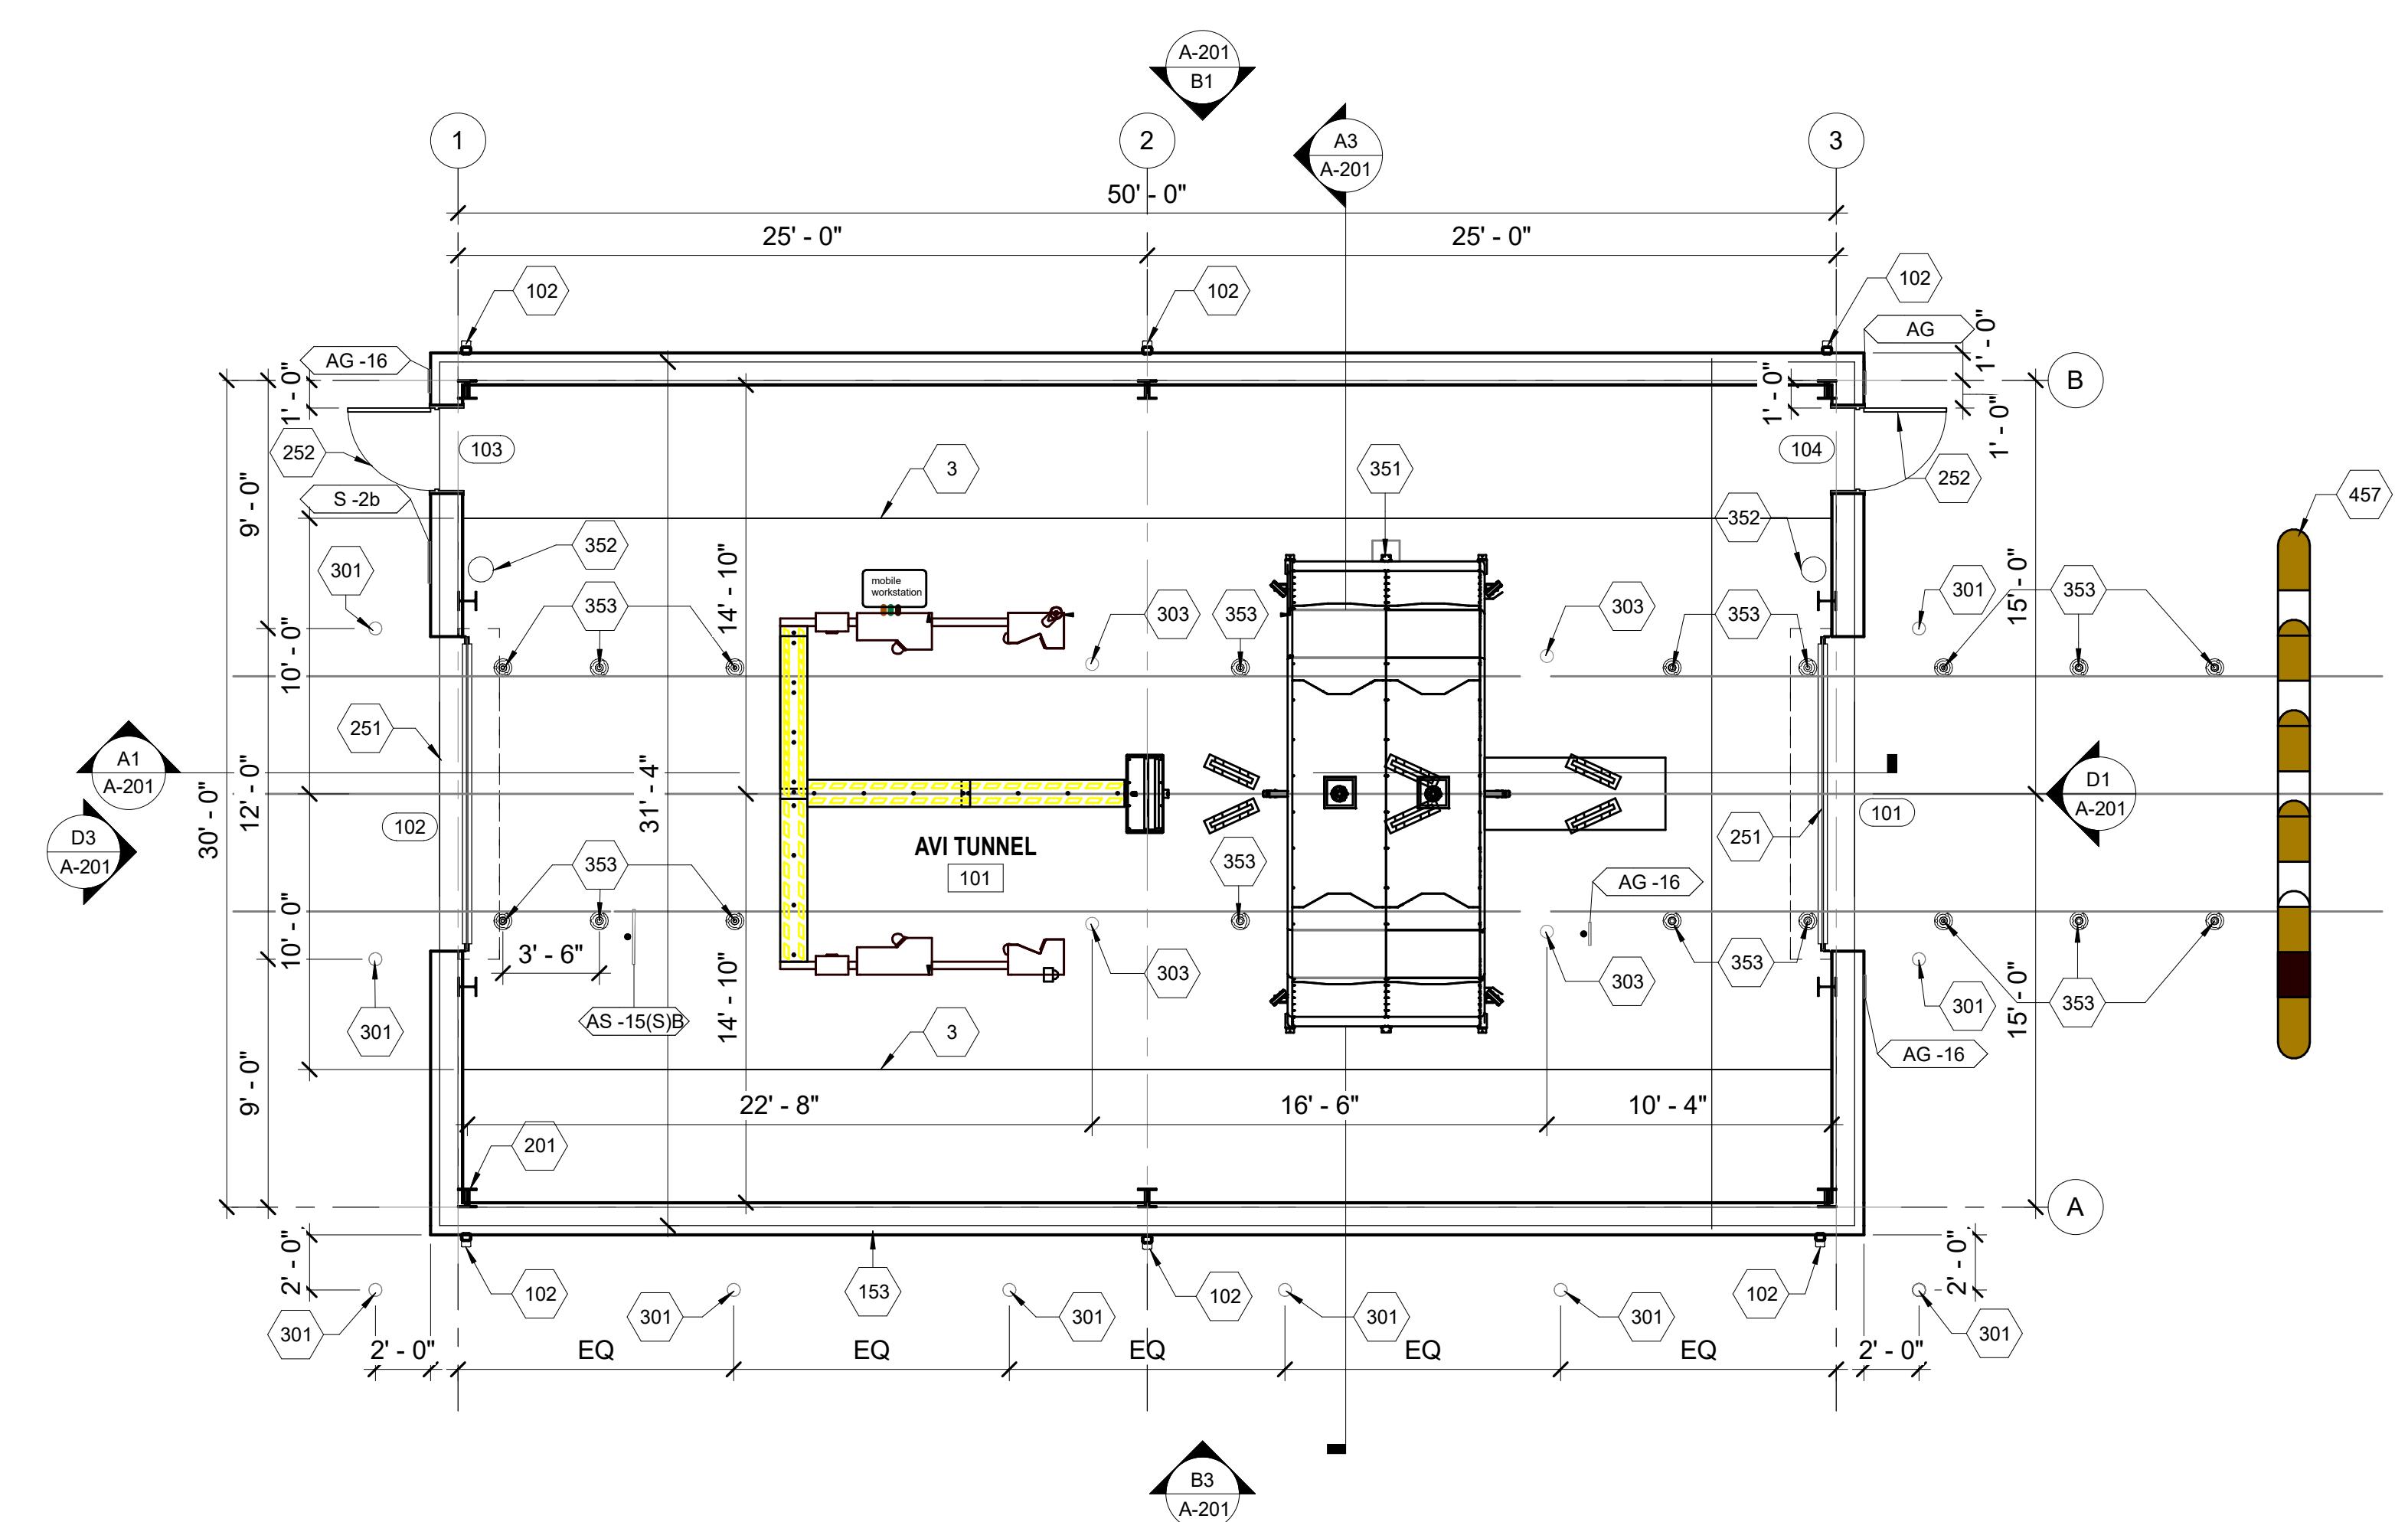


A1 FLOOR PLAN


SCALE: 3/16" = 1'-0"

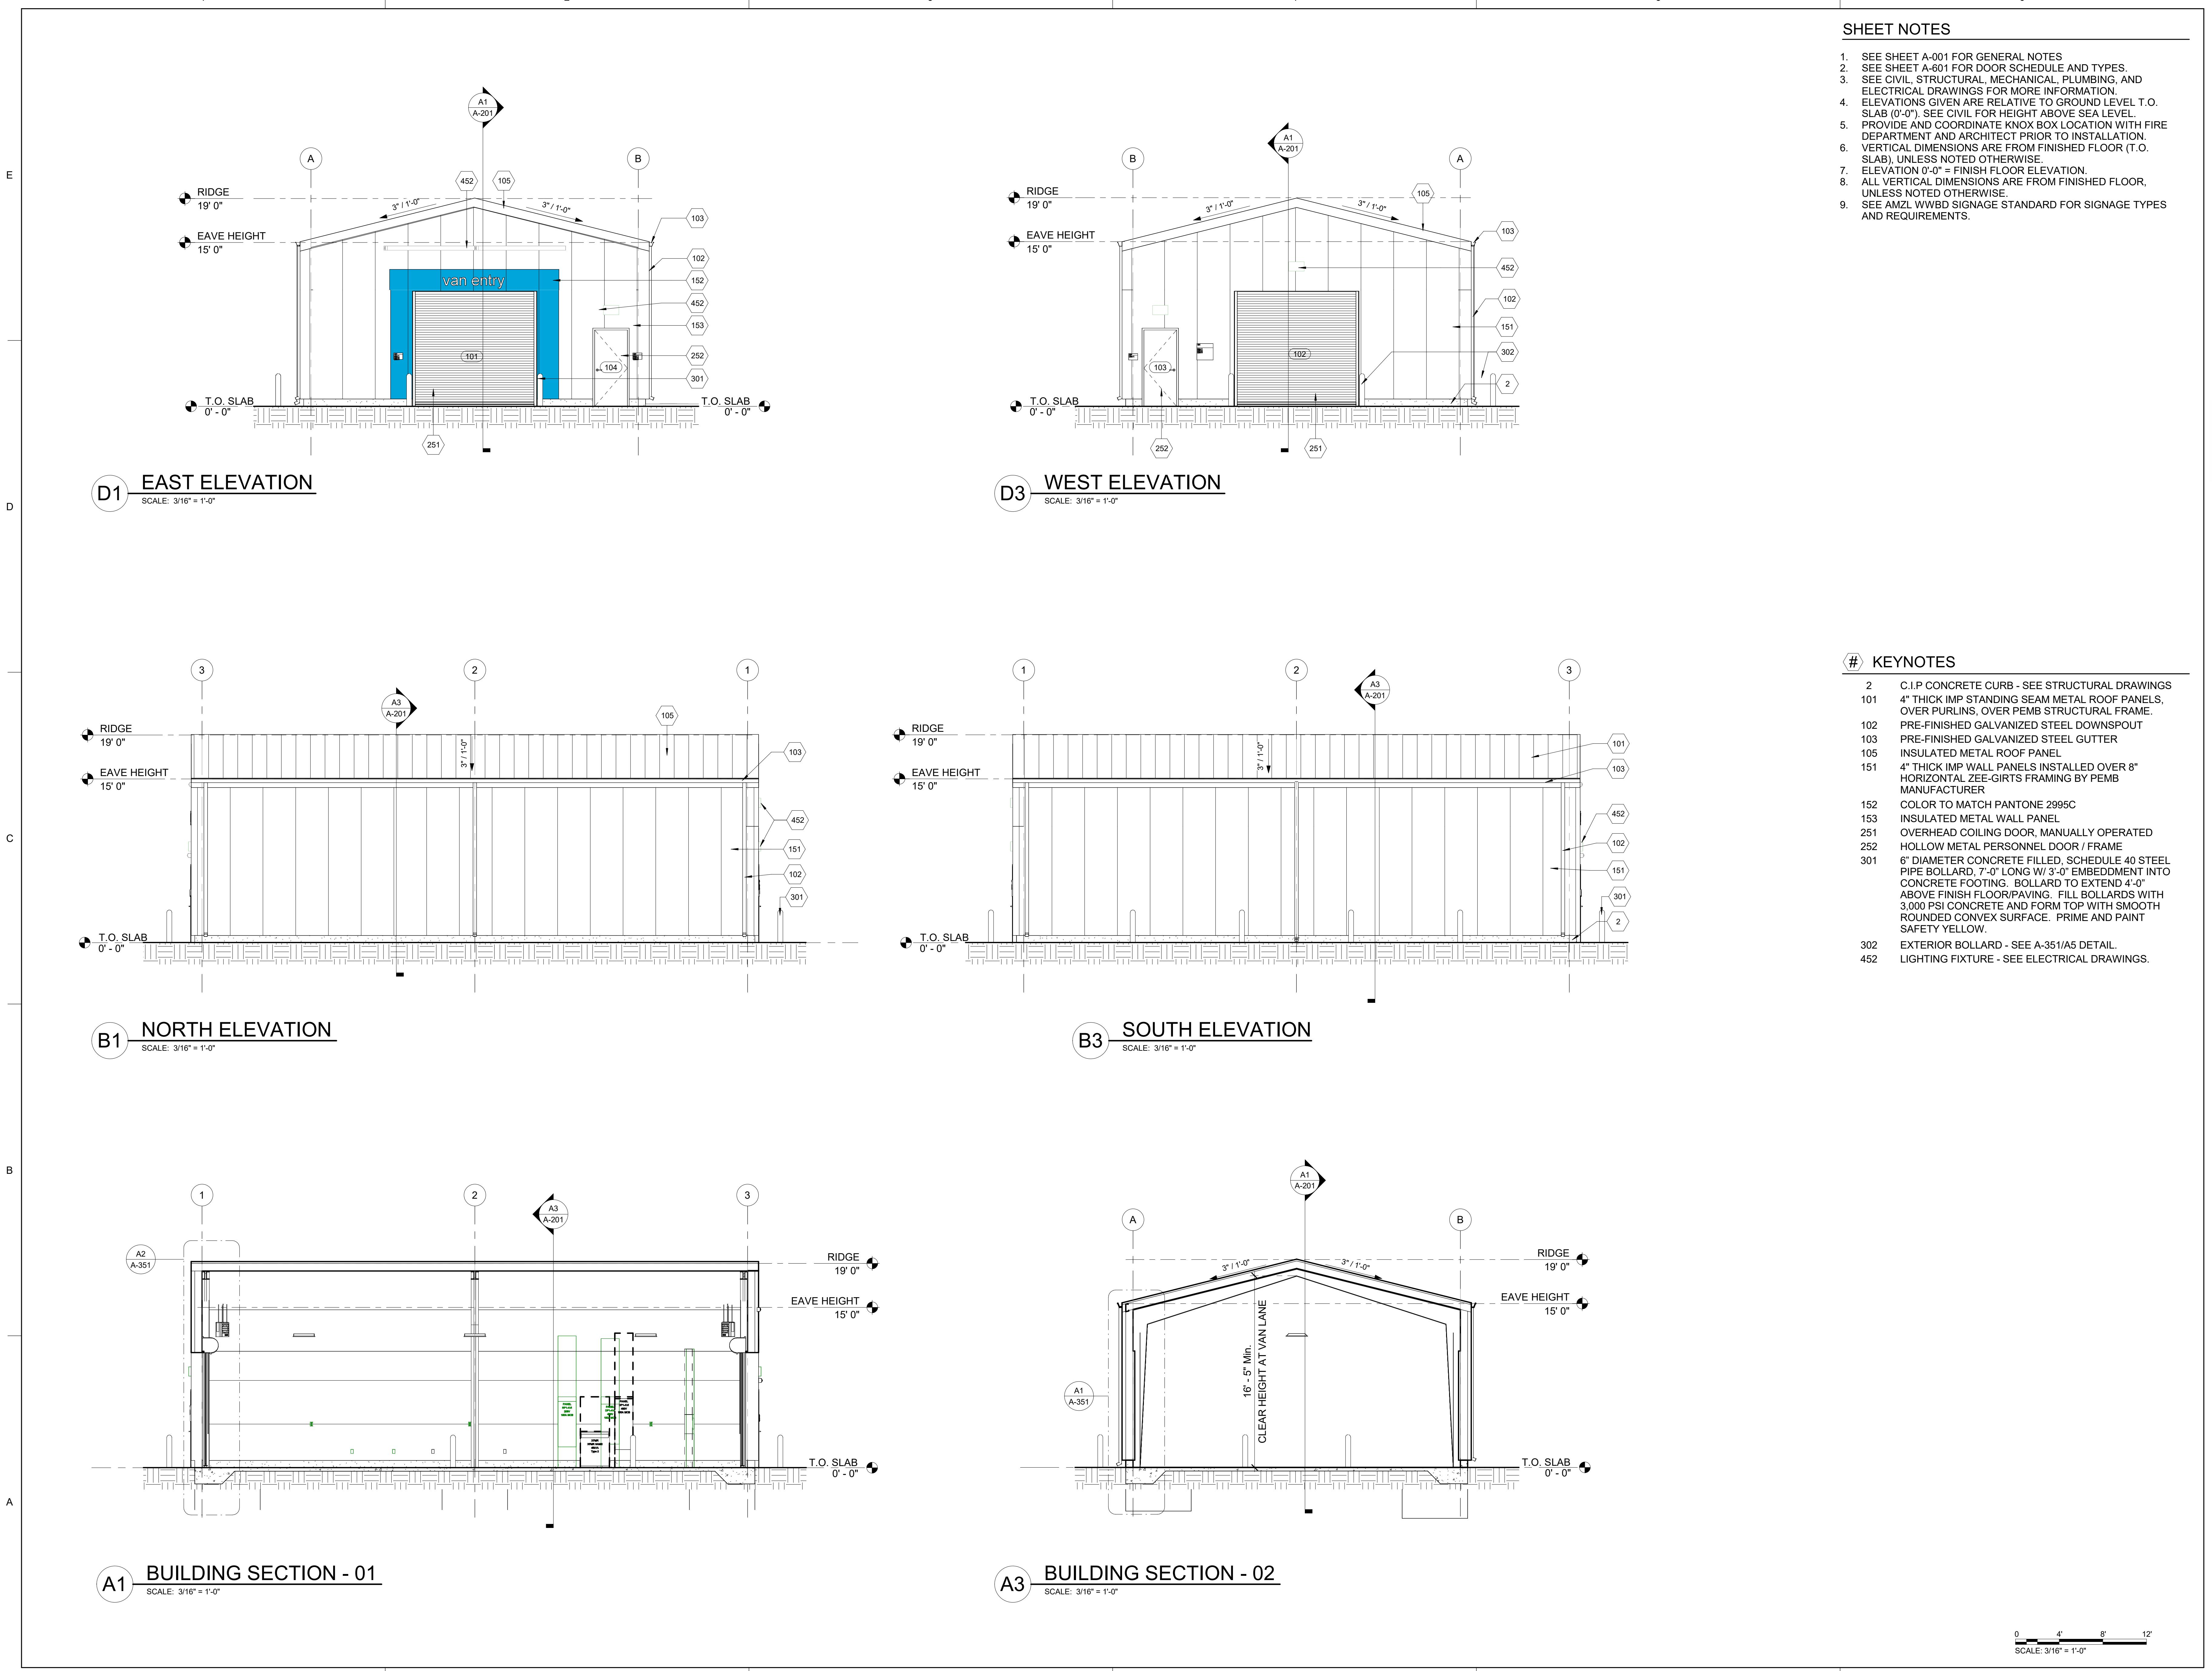


E

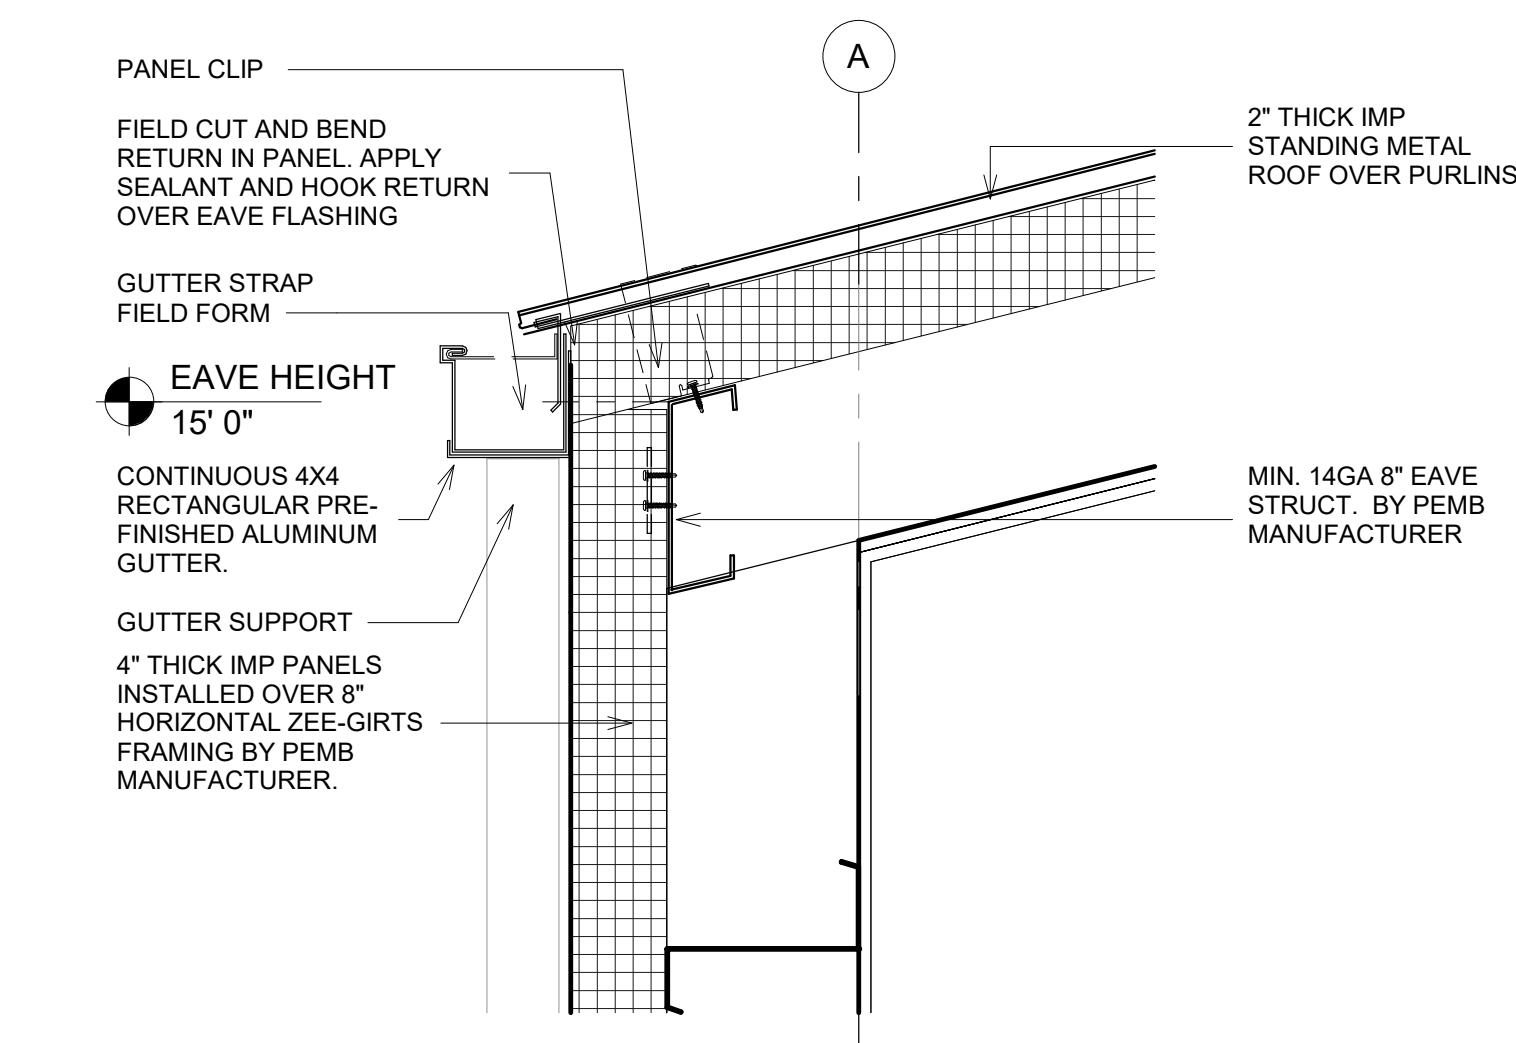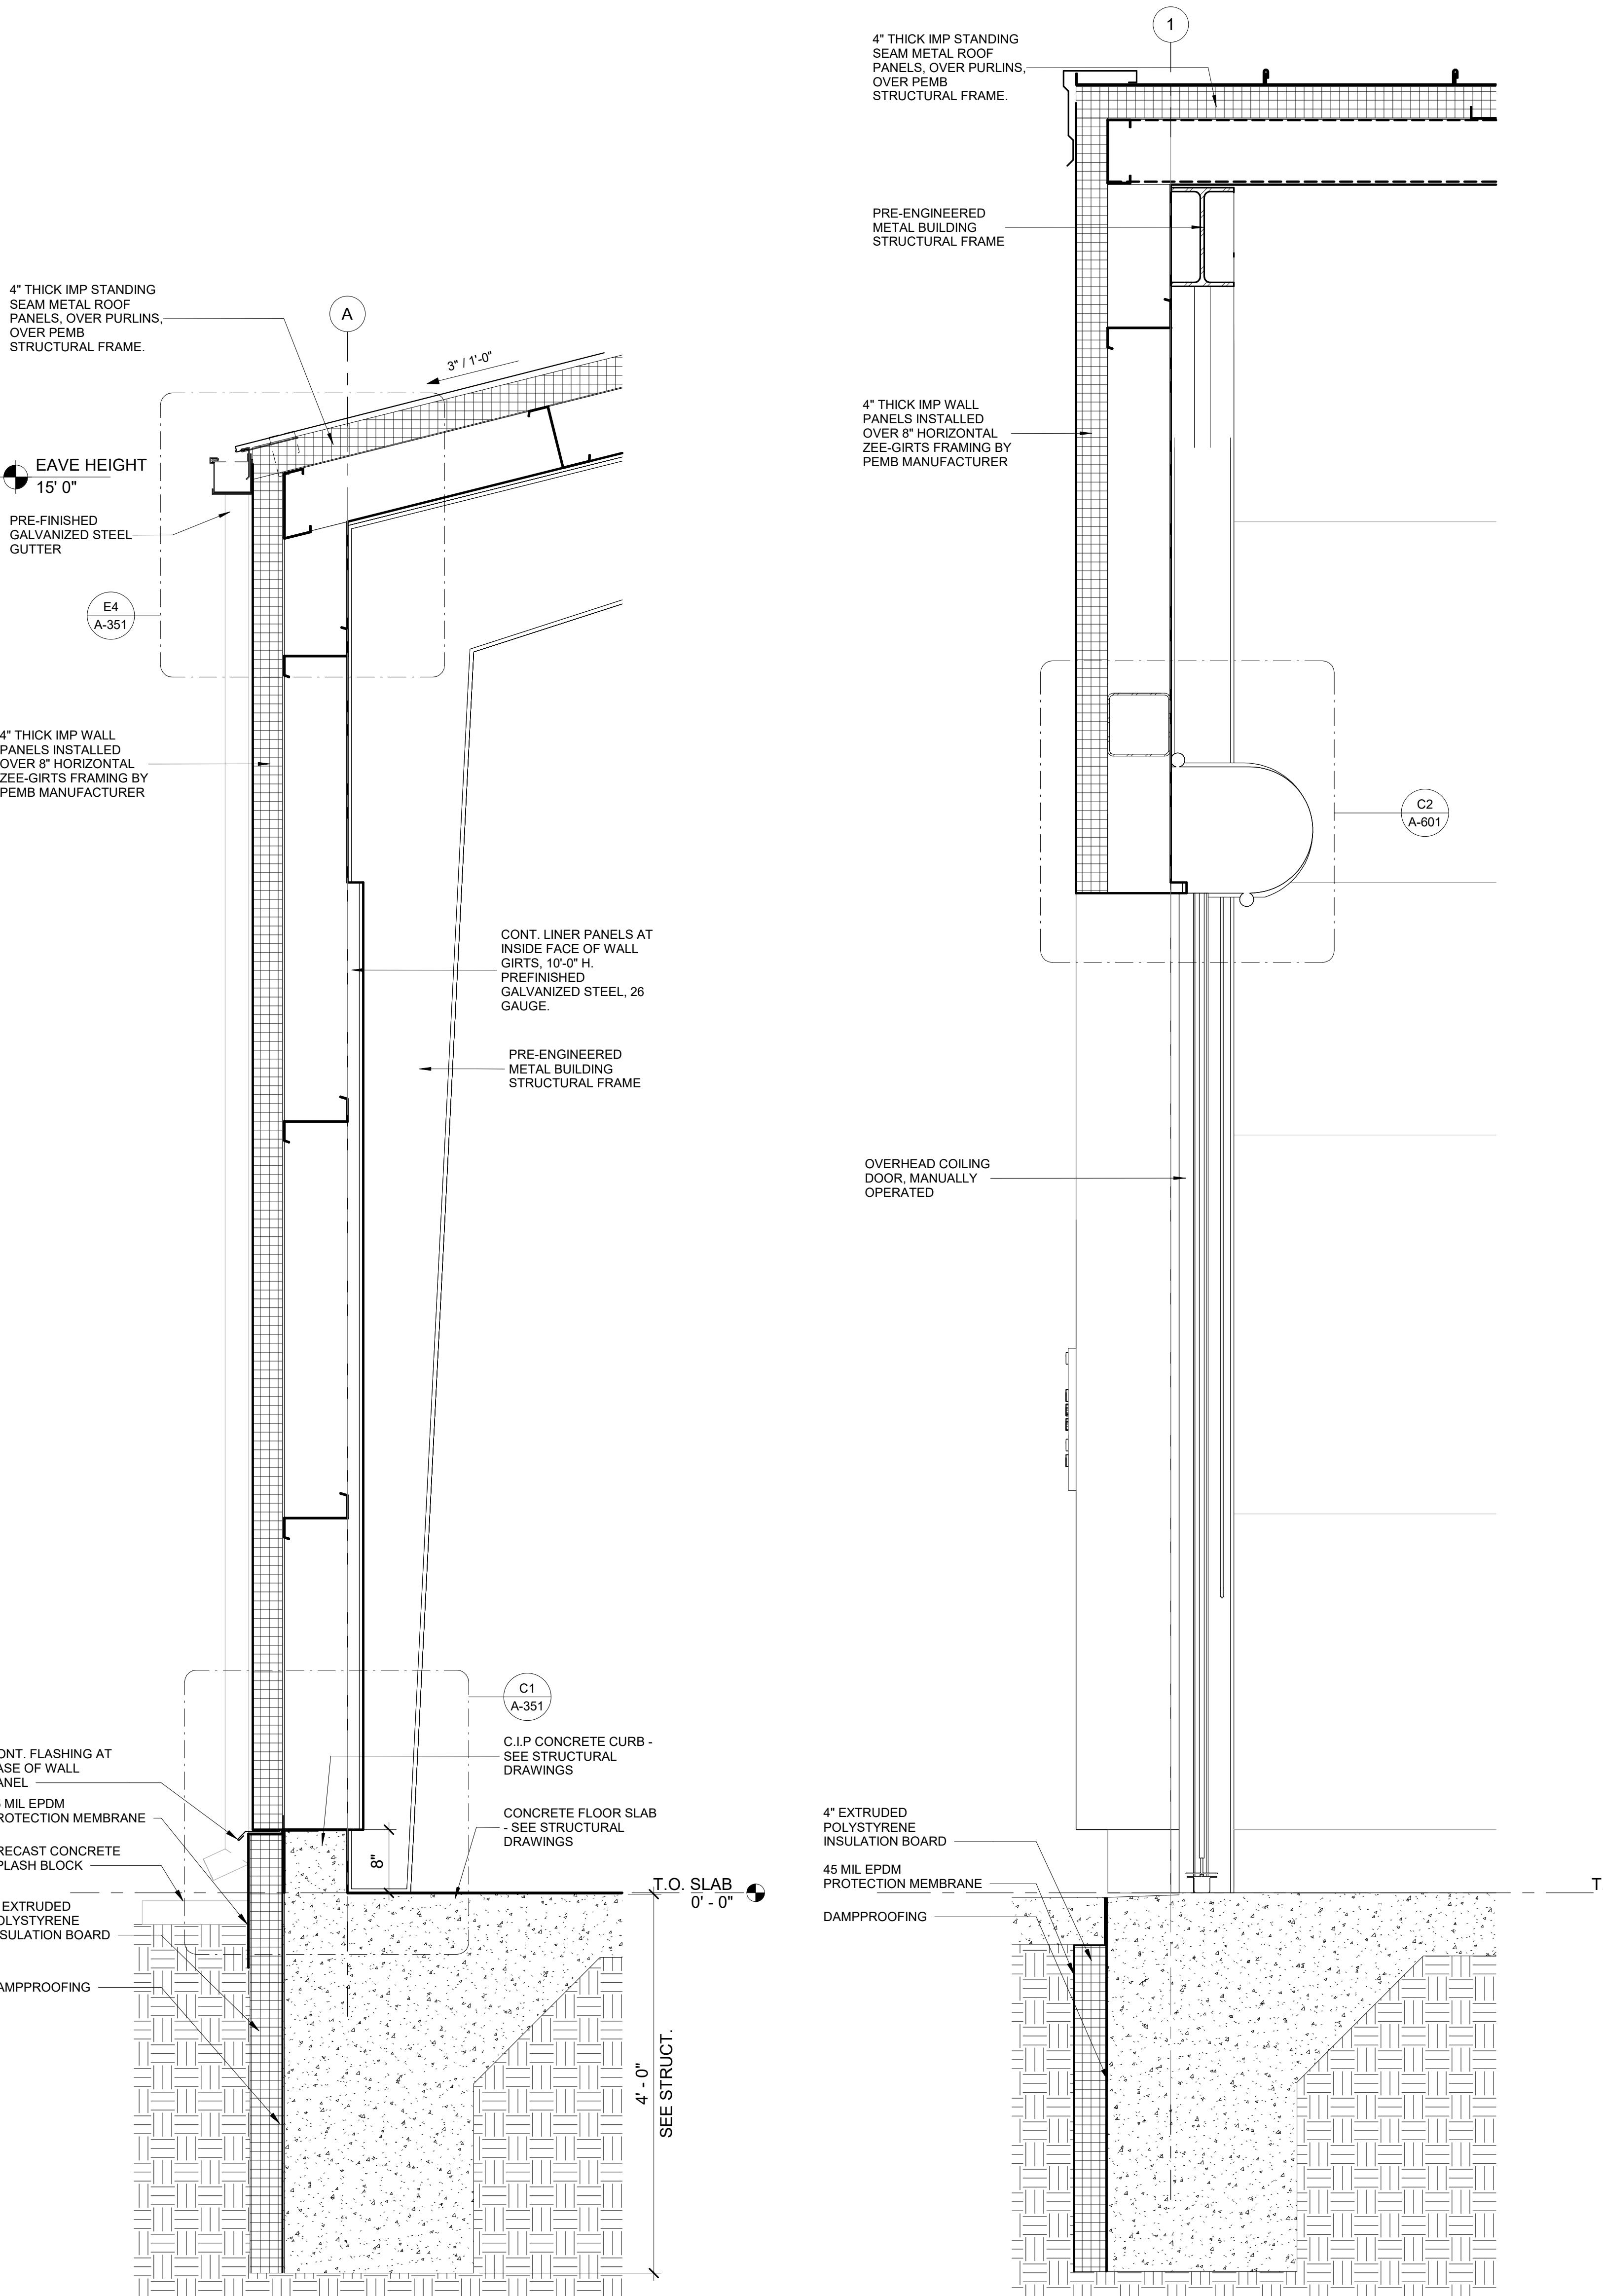


E4 EAVE DETAIL
SCALE: 1 1/2" = 1'-0"

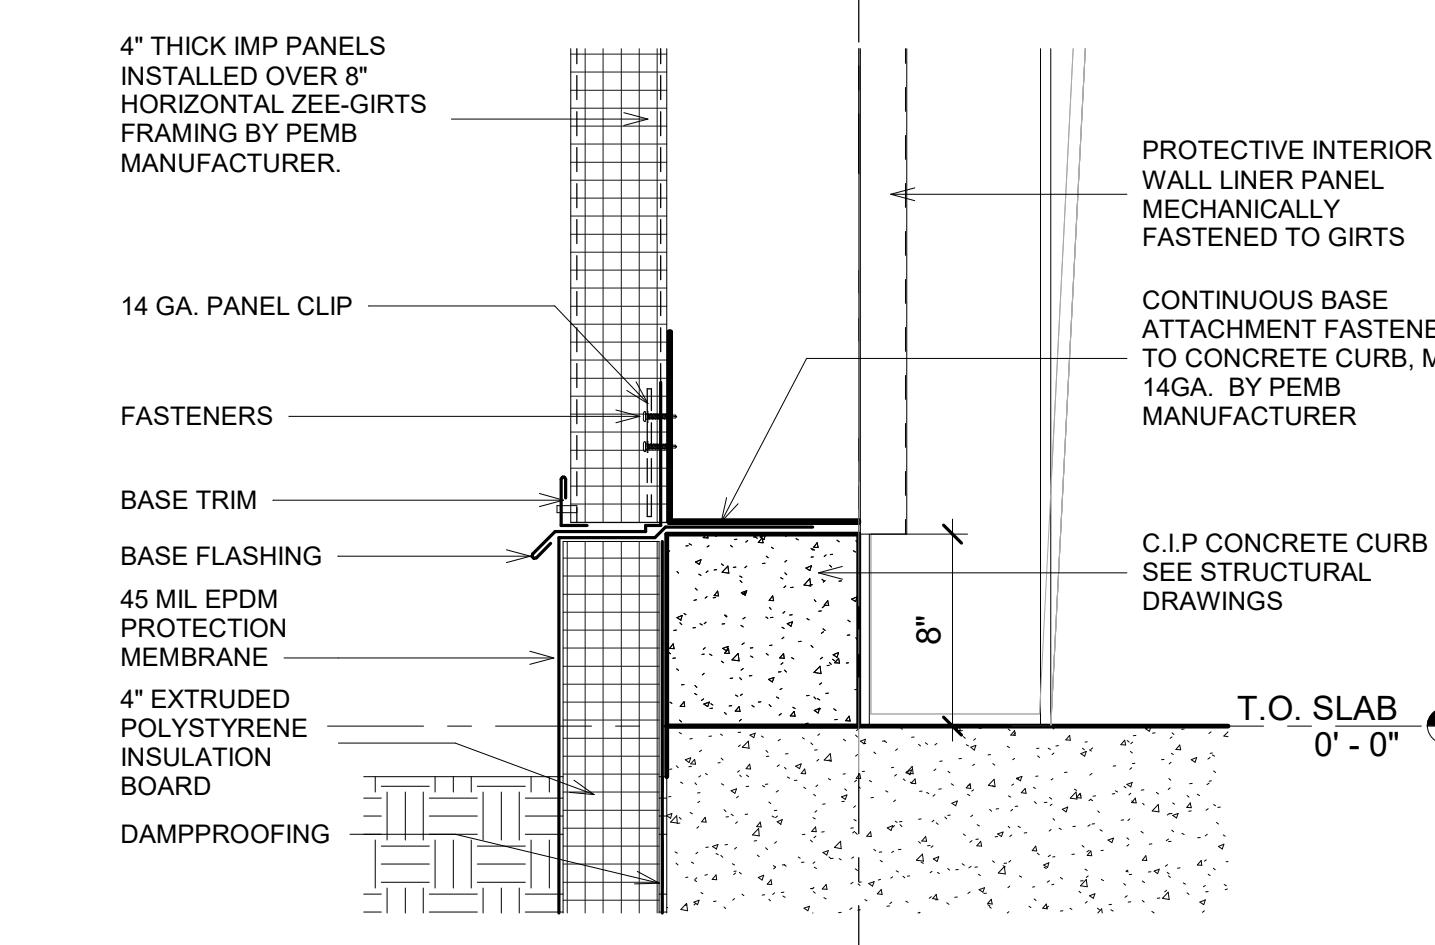

C1 CONCRETE CURB / BOTTOM DETAIL
SCALE: 1 1/2" = 1'-0"

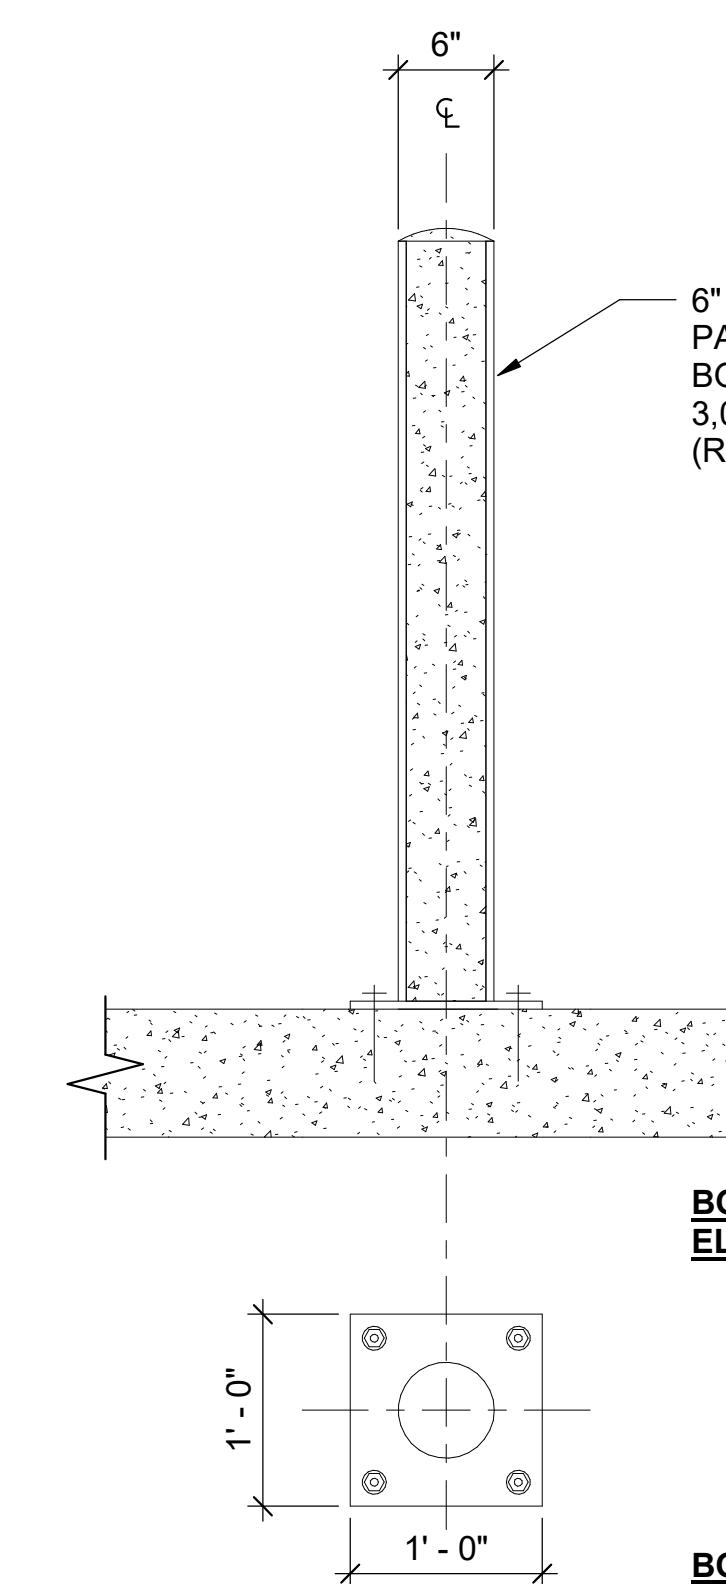

A4 INTERIOR BOLLARD DETAIL
SCALE: 1" = 1'-0"

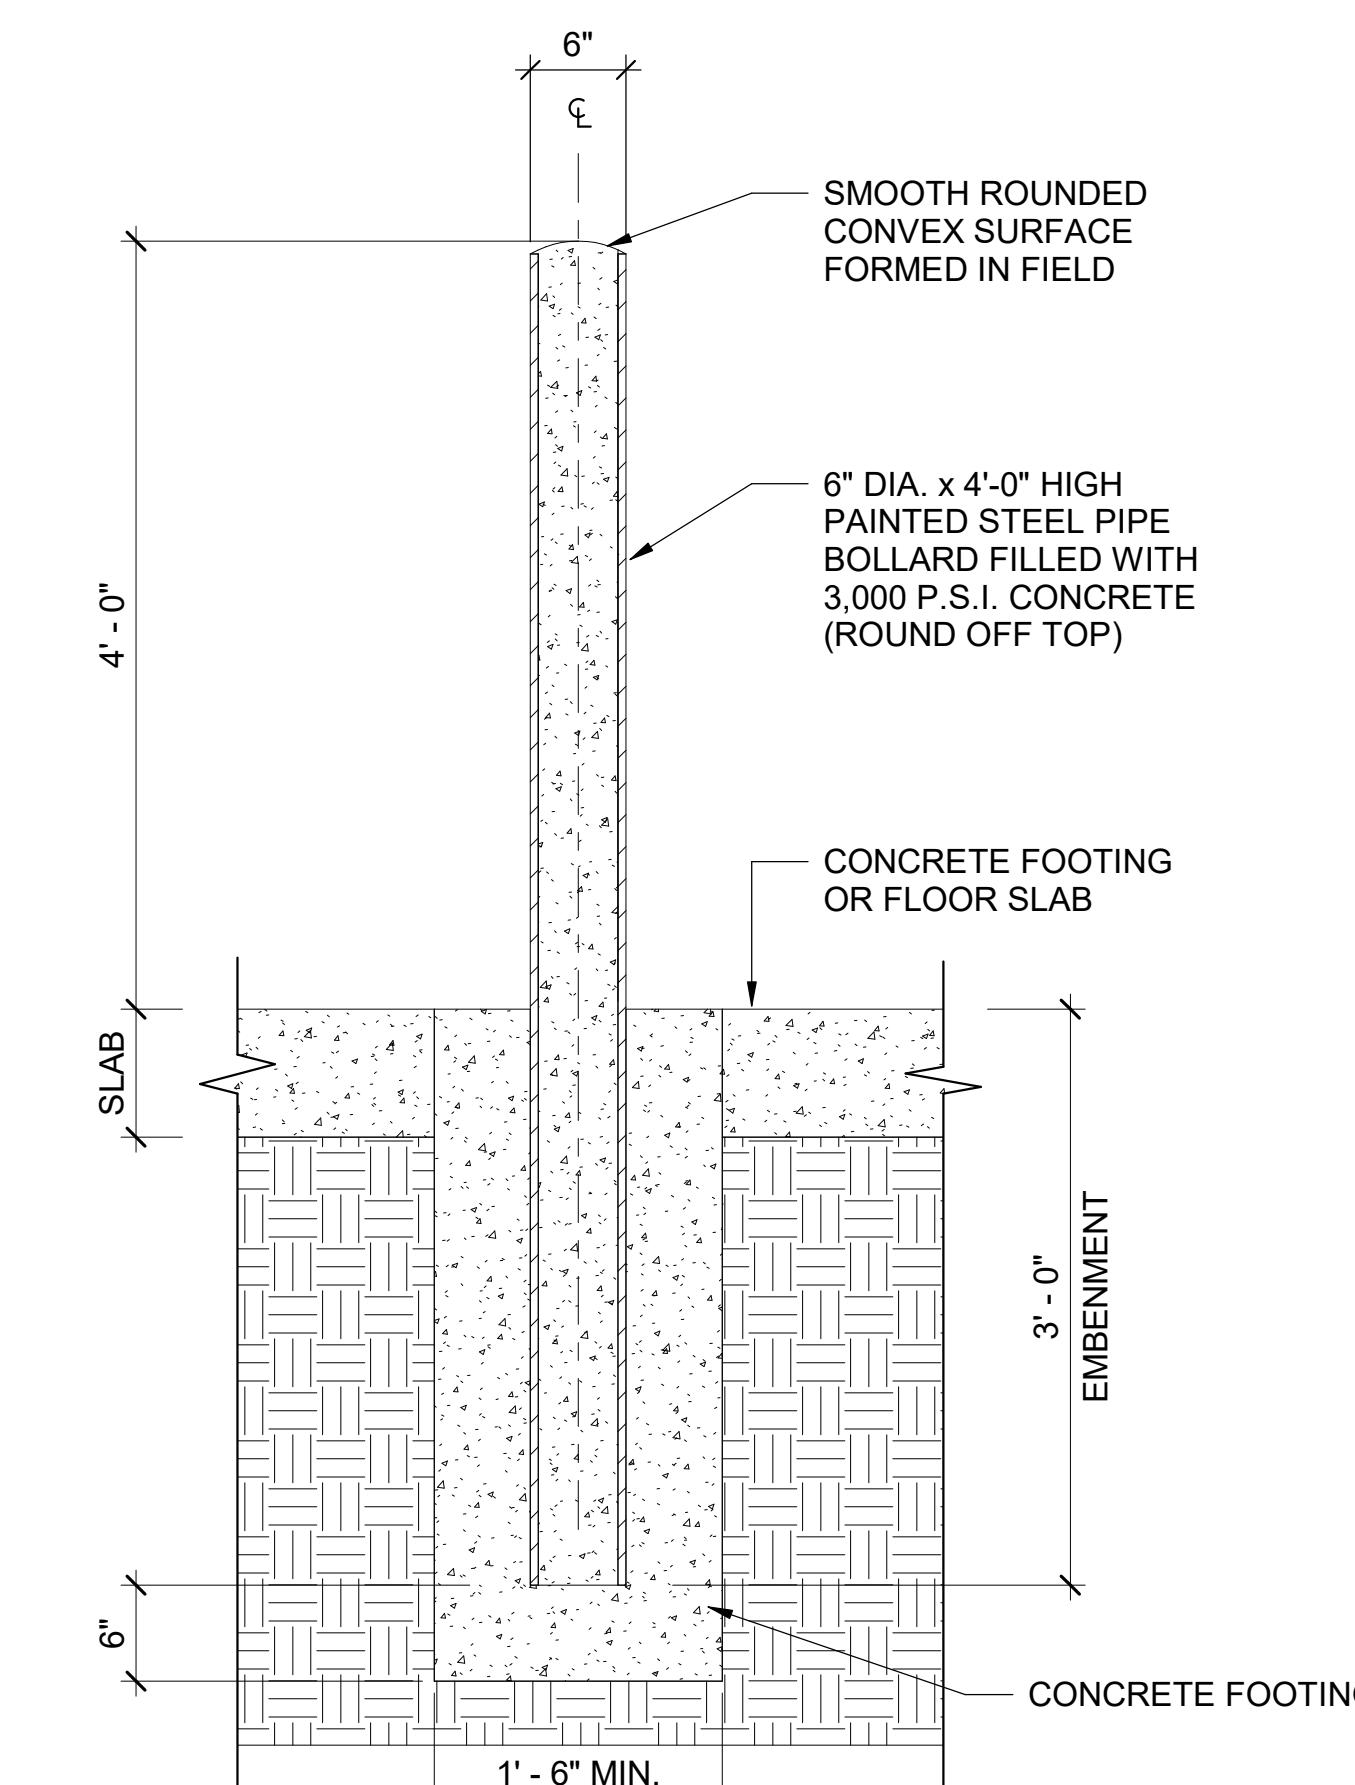

A5 EXTERIOR BOLLARD DETAIL
SCALE: 1" = 1'-0"

SHEET NOTES

- SEE SHEET A-001 FOR GENERAL NOTES
- SEE SHEET A-601 FOR DOOR SCHEDULE AND TYPES
- REFER TO MECHANICAL, PLUMBING, AND ELECTRICAL DRAWINGS FOR THE LOCATION OF ALL MEP WORK, INCLUDING BUT NOT LIMITED TO LIGHTS, DIFFUSERS, PIPES AND DUCTWORK.
- ELEVATIONS GIVEN ARE RELATIVE TO GROUND LEVEL T.O. SLAB (0'-0"). SEE CIVIL FOR HEIGHT ABOVE SEA LEVEL.

EOR/AOR SEAL

COA SEAL

amazon

PROJECT NAME
AMZL DKO1
AVI

151-153 TAYLOR
STREET
LITTLETON, MA
01460

DRAWING ISSUE
CD 100% FOR REVIEW
ISSUED FOR REVIEW
DATE
27/2025
16/2025

CD 100% FOR REVIEW
ISSUED FOR REVIEW
DESCRIPTION
B A MARK

DESIGNED BY: JOC
DRAWN BY: MA
CHECKED BY: KK
SUBMITTED BY: JAM
DATE: 27/2025
PROJECT #: 1240262

**WALL SECTIONS
AND DETAILS**

**SHEET NUMBER
A-351**

ORIGINAL SHEET SIZE:
30" X 42"

GENERAL

ALL WORK SHALL BE IN ACCORDANCE WITH CODES LISTED IN CODE SUMMARY. CONTRACTOR SHALL PAY FOR AND OBTAIN ALL PERMITS REQUIRED BY THE LOCAL BUILDING CODE. ALL WORK SHALL CONFORM TO APPLICABLE INDUSTRY AND MANUFACTURER'S PUBLISHED STANDARDS FOR QUALITY OF MATERIALS AND WORKMANSHIP, AS WELL AS ALL REQUIREMENTS IN THESE DRAWINGS AND SPECIFICATIONS. ANY CONFLICTING REQUIREMENTS IN THE SOURCES LISTED ABOVE SHALL BE BROUGHT TO THE ARCHITECT'S ATTENTION PRIOR TO PROCEEDING WITH THE WORK.

DRAWINGS AND SPECIFICATIONS ARE COMPLEMENTARY. WHAT IS CALLED FOR BY ONE SHALL BE PROVIDED AS IF CALLED FOR IN BOTH. IN THE EVENT THERE IS A DISCREPANCY BETWEEN THE DRAWINGS AND SPECIFICATIONS, THE MORE STRICT OR HIGHER QUALITY PRODUCT, COMPONENT, ELEMENT OR ASSEMBLY SHALL BE PROVIDED. CONTRACTOR SHALL FIELD VERIFY ALL DIMENSIONS PRIOR TO PURCHASING EQUIPMENT.

SUBMITTALS FOR APPROVAL

ALL DISCIPLINES SHALL PROVIDE ARCHITECT WITH LIST OF PROPOSED SUBMITTAL, SHOP DRAWINGS, PRODUCT DATA FOR REVIEW.

PRODUCT DATA: SUBMIT PRODUCT DATA FOR THE FOLLOWING ITEMS:

COLLECT INFORMATION INTO A SINGLE SUBMITTAL FOR EACH ELEMENT OF CONSTRUCTION AND TYPE OF PRODUCT OR EQUIPMENT.

1. IF INFORMATION MUST BE SPECIALLY PREPARED FOR SUBMITTAL BECAUSE STANDARD PUBLISHED DATA ARE UNSUITABLE FOR USE, SUBMIT AS SHOP DRAWINGS, NOT AS PRODUCT DATA.

2. MARK EACH COPY OF EACH SUBMITTAL TO SHOW WHICH PRODUCTS AND OPTIONS ARE APPLICABLE.

3. INCLUDE THE FOLLOWING INFORMATION, AS APPLICABLE:

- A. MANUFACTURER'S CATALOG CUTS.
- B. MANUFACTURER'S PRODUCT SPECIFICATIONS.
- C. STANDARD COLOR CHARTS.
- D. STATEMENT OF COMPLIANCE WITH SPECIFIED REFERENCED STANDARDS.
- E. TESTING BY RECOGNIZED TESTING AGENCY.
- F. APPLICATION OF TESTING AGENCY LABELS AND SEALS.
- G. NOTATION OF COORDINATION REQUIREMENTS.
- H. AVAILABILITY AND DELIVERY TIME INFORMATION.

4. FOR EQUIPMENT, INCLUDE THE FOLLOWING IN ADDITION TO THE ABOVE, AS APPLICABLE:

- A. WIRING DIAGRAMS THAT SHOW FACTORY-INSTALLED WIRING.
- B. PRINTED PERFORMANCE CURVES.
- C. OPERATIONAL RANGE DIAGRAMS.
- D. CLEARANCES REQUIRED TO OTHER CONSTRUCTION, IF NOT INDICATED ON ACCOMPANYING SHOP DRAWINGS.

5. SUBMIT PRODUCT DATA BEFORE SHOP DRAWINGS, AND BEFORE OR CONCURRENT WITH SAMPLES.

SHOP DRAWINGS: SUBMIT FOR THE FOLLOWING ITEMS:

- A. IDENTIFICATION OF PRODUCTS.
- B. SCHEDULES.
- C. COMPLIANCE WITH SPECIFIED STANDARDS.
- D. NOTATION OF COORDINATION REQUIREMENTS.
- E. NOTATION OF DIMENSIONS ESTABLISHED BY FIELD MEASUREMENT.
- F. RELATIONSHIP AND ATTACHMENT TO ADJOINING CONSTRUCTION CLEARLY INDICATED.
- G. SEAL AND SIGNATURE OF PROFESSIONAL ENGINEER REGISTERED

03 03560 CONCRETE SEALER / HARDNER

THE AVI FLOOR SHALL RECEIVE A LITHIUM BASED (MINIMUM 6% LITHIUM SILICATE SOLIDS) CHEMICAL FLOOR HARDENER/SEALER AT TIME OF SLAB PLACEMENT PRIOR TO THE CURING MEMBRANE APPLICATION. BASIS-OF-DESIGN CONSOLIDECK LS/CS BY PROSOCO, OR EQUAL BY DAYTON SUPERIOR, NOX-CRETE OR SPECHEM. SEE STRUCTURAL DRAWINGS FOR CONCRETE FINISHING REQUIREMENTS.

07 1113 BITUMINOUS DAMPROOFING

FIBERED BRUSH / SPRAY COATS, MEETING ASTM D1227, TYPE II, CLASS 1, BASIS-OF-DESIGN TO BE "SEALMASTIC EMULSION / SEALMASTIC TYPE II" BY W.R. MEADOWS, INC., OR APPROVED EQUAL BY APOC, INC., OR THE HENRY COMPANY.

07 2100 THERMAL INSULATION (SLAB EDGE)

EXTRUDED POLYSTYRENE FOAM-PLASTIC BOARD INSULATION (XPS), TYPE IV, ASTM C578. 25 PSI MINIMUM COMPRESSIVE STRENGTH; UNFACED. THICKNESS AS SHOWN ON DRAWINGS. BASIS-OF-DESIGN TO BE STYROFOAM XPS INSULATION BY DUPONT, OR APPROVED EQUAL BY OWENS CORNING, OR KINGSPAN.

07 4116 INSULATED ROOF PANELS

BASIS-OF-DESIGN TO BE CFR INSULATED METAL ROOF PANEL BY METLSPAN. PROVIDE IN THICKNESS AND WIDTH SHOWN ON DRAWINGS.

ALTERNATE PRODUCTS BY KINGSPAN OR MBCI MAY BE APPROVED, SUBJECT TO REVIEW OF PERFORMANCE REQUIREMENTS.

07 4213 INSULATED WALL PANELS

BASIS-OF-DESIGN TO BE CF LIGHT MESA INSULATED METAL WALL PANEL BY METLSPAN. PROVIDE IN THICKNESS AND WIDTH SHOWN ON DRAWINGS.

ALTERNATE PRODUCTS BY KINGSPAN OR MBCI MAY BE APPROVED, SUBJECT TO REVIEW OF PERFORMANCE REQUIREMENTS.

07 5323 EPDM MEMBRANE (PROTECTION MEMBRANE AT SLAB EDGE INSULATION)

PROVIDE FULLY ADHERED 60 MIL REINFORCED EPDM MEMBRANE. PREPARE SURFACE OF CONCRETE FOUNDATION FOR APPLICATION OF ADHERED MEMBRANE. BASIS-OF-DESIGN TO BE "SURE-TOUGH EPDM REINFORCED MEMBRANE" BY CARLISLE, OR APPROVED EQUAL BY GAF, THE HENRY COMPANY, OR JOHNS MANVILLE.

07 6000 FLASHING AND SHEET METAL

SHEET METAL FLASHING
METAL FLASHING INCLUDING GUTTERS, DOWNSPOUTS, AND FASCIA, SHALL BE PREFINISHED GALVANIZED STEEL WITH ADVANCED THERMOSET SOLUTION FLUOROPOLYMER COATING AND RUSTPROOF FASTENERS.

08 1113 STEEL DOORS AND FRAMES**HOLLOW METAL DOORS AND FRAMES**

PROVIDE METAL DOORS AND FRAMES COMPLYING WITH STEEL DOOR INSTITUTE "SDI-100 - RECOMMENDED SPECIFICATIONS: STANDARD STEEL DOORS AND FRAMES."

EXTERIOR HOLLOW METAL DOORS SHALL BE 1-3/4" THICK STEEL, LEVEL 3 AND PHYSICAL PERFORMANCE LEVEL A (EXTRA HEAVY DUTY), MODEL 2 (SEAMLESS), WITH FACE SHEETS FABRICATED FROM 16 GAUGE STEEL, AND FULLY WELDED FRAMES FABRICATED FROM 14 GAUGE STEEL. STEEL SHALL BE A90 HOT-DIPPED GALVANIZED PER ASTM A653. SINGLE-LEAF DOORS SHALL HAVE INSULATED CORES MEETING U-FACTOR REQUIREMENT BELOW.

BASIS-OF-DESIGN FOR EXTERIOR SINGLE DOORS TO BE CURRIES MODEL 707 SINGLE FLUSH DOOR, FULLY INSULATED WITH QMAX CORE. DOOR AND FRAME MAX. THERMAL U-FACTOR TO BE 0.37.

ALTERNATE PRODUCTS BY STEELCRAFT, TRUDOR, OR OTHER APPROVED MANUFACTURERS MAY BE APPROVED, SUBJECT TO REVIEW OF PERFORMANCE REQUIREMENTS.

08 3323 OVERHEAD COILING DOORS

INSULATED STEEL OVERHEAD COILING DOORS 12' WIDE X 12' HIGH, MANUALLY OPERATED, SURFACE MOUNTED.

BASIS-OF-DESIGN TO BE OVERHEAD DOOR CO. MODEL 625, SLAT PROFILE F2651, INSULATED TO R7.7, GALV 24 GA FRONT, GALV 24 GA BACK. PROVIDE WITH MANUFACTURER'S POWDER COAT FINISH.

ALTERNATE PRODUCTS BY CLOPAY, COOKSON, CORNELL, OR RAYNOR MAY BE APPROVED, SUBJECT TO REVIEW OF PERFORMANCE REQUIREMENTS.

08 7100 FINISH HARDWARE

ALL DOOR HARDWARE SHALL BE FULLY ACCESSIBLE PER THE PROVISIONS OF FBC 1010.1.9 AND ANSI A11.7.

PROVIDE CLOSERS ON ALL EXTERIOR DOORS.

PROVIDE CONSTRUCTION CORES AND KEYS DURING CONSTRUCTION. PERMANENT CORES AND KEYS WILL BE FURNISHED TO THE TENANT AND WILL BE EQUAL TO BEST PATENTED - KABA-PEAKS SFIC 7-PIN KEY SYSTEM ONLY. NO SUBSTITUTIONS. THE TENANT, AT THEIR COST, WILL HIRE A LOCKSMITH TO PROVIDE FINAL KEYING AND INSTALL PERMANENT CORES AND RETURN THE CONSTRUCTION CORES TO THE GENERAL CONTRACTOR.

PROVIDE HARDWARE AND FASTENERS FABRICATED FROM STAINLESS STEEL, TYP.

SET: 1.0

DOORS: 103, 104

3	HINGE, HEAVY-DUTY STAINLESS STEEL BALL-BEARING HINGES	4-1/2" x 4-1/2"	US32D	MK
1	CYLINDRICAL LOCK, STOREROOM FUNCTION	6500 SERIES	US32D	SA
1	CYLINDER	AS REQUIRED	US32D	SA
1	DOOR CLOSER	EN	EN	SA
1	THRESHOLD	2005		PE
1	RAIN GUARD	346C		PE
1	KICK PLATE	10" X 1.5" LDW	US32D	RO
1	GASKETING	S88		PE

NOTE: REFERENCE U.L. ZHLA.12 FOR ALLOWABLE THRESHOLDS AND WEATHERSTRIP.

09 9000 PAINTING

NATIONAL ACCOUNTS: PROVIDE COMPLETE PAINTING SYSTEMS, UTILIZING THE PRODUCTS OF ONE APPROVED MANUFACTURER: BENJAMIN MOORE, PPG, OR SHERWIN- WILLIAMS. BASIS OF DESIGN: SHERWIN WILLIAMS.

EXTERIOR EXPOSED FERROUS METAL ITEMS, NOT SCHEDULED TO RECEIVE PAINT FINISH, SHALL BE HOT-DIPPED, GALVANIZED FINISH, A60.

EXTERIOR, EXPOSED FERROUS METAL ITEMS SCHEDULED TO RECEIVE PAINT- 2 COAT ALKYD SYSTEM OVER 1 COAT OF FACTORY (OR FIELD) PRIMER. FACTORY PRIMED ITEMS SHALL BE TOUCHED UP PRIOR TO FINISH PAINT APPLICATION.

EXTERIOR, EXPOSED GALVANIZED METALS SCHEDULED TO RECEIVE PAINT- 3 COAT ALKYD SYSTEM- 2 COATS GLOSS FINISH PAINT OVER 1 COAT OF GALVANIZED METAL PRIMER.

PREFINISHED PAINTED ITEMS DO NOT REQUIRE PAINTING. REFER TO DRAWINGS FOR PAINT COLORS.

10 4400 FIRE PROTECTION SPECIALTIES

FIRE EXTINGUISHERS ARE TO COMPLY WITH PRODUCT REQ'S OF NFPA 10 AND APPLICABLE CODES, WHICHEVER IS MORE STRINGENT. MULTI-PURPOSE DRY CHEMICAL TYPE EXTINGUISHERS TO HAVE STEEL TANK WITH PRESSURE GAUGE. TANK FINISH IS TO BE BAKED ENAMEL; RED COLOR. 10 LB., MINIMUM 4A-80B:C, TYPICAL.

PORTABLE FIRE EXTINGUISHERS: LARSEN'S MANUFACTURING CO. MODEL: "MP SERIES", MULTIPURPOSE DRY-CHEMICAL TYPE WITH FLUIDIZED AND SILICONIZED MONO AMMONIUM PHOSPHATE POWER, UL-RATED AS SCHEDULED.

PROVIDE WALL MOUNTED FIRE EXTINGUISHERS WHERE INDICATED ON THE DRAWINGS.

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Georgia 30092
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EOR/AOR SEAL

COA SEAL

CLIENT INFORMATION

PROJECT NAME

AMZL DKO1
AVI

151-153 TAYLOR
STREET
LITTLETON, MA
01460

DRAWING ISSUE
DATE

CD 100% FOR REVIEW
ISSUED DATE
DESCRIPTION

B
A
MARK

DESIGNED BY: JOC
DRAWN BY: MA
CHECKED BY: JR
SUBMITTED BY: JAM
DATE: 2/7/2025
PROJECT #: 1240262

SHEET TITLE
SPECIFICATIONS

SHEET NUMBER

A-701

ORIGINAL SHEET SIZE:
30" X 42"